THIS DOCUMENT HAS BEEN DIGITALLY SIGNED AND SEALED BY:

Allyson Foster Boyd Allyson Foster Boyd 2025.04.09 14:15:40-04'00'

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CDM Smith 1100 Marion Street Suite 300 Knoxville, TN 37921 Allyson Foster Boyd, P.E. No. 119,736

THE ABOVE NAMED PROFESSIONAL ENGINEER SHALL BE RESPONSIBLE FOR THE FOLLOWING SHEETS IN ACCORDANCE OF TENN. CODE ANN. §62-2-306.

SHEET NAME	SHEET NO.
SIGNATURE SHEET	BRIDGE-SIGN1
TITLE SHEET	1
INDEX AND STANDARD DRAWINGS	1A
PROJECT COMMITMENTS	1B
ESTIMATED ROADWAY QUANTITIES AND UTILITY OWNERS	2A
GENERAL NOTES & SPECIAL NOTES	2B-2B3
GUARDRAIL PLAN & PAVEMENT TRANSITION DETAILS (BR. NO. 30-SR34-17.25 L&R).	2C
TRAFFIC CONTROL PLAN BR. NO. 30-SR34-17.25 (LEFT & RIGHT)	3-3E
TRAFFIC CONTROL PLAN SNAPPS FERRY ROAD	3F-3G
TRAFFIC CONTROL PLAN WIDE LOAD DETOUR	3H

THIS DOCUMENT HAS BEEN DIGITALLY SIGNED AND SEALED BY:

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Susanne Dawson Susanne Dawson 2025.04.09 14:18:01-04'00' PRINTED COPIES OF THIS DOCUMENT ARE NOT CONSIDERED SIGNED

CDM Smith 1100 Marion Street Suite 300 Knoxville, TN 37921

Susanne Dawson, P.E. No. 111,826

THE ABOVE NAMED PROFESSIONAL ENGINEER SHALL BE RESPONSIBLE FOR THE FOLLOWING SHEETS IN ACCORDANCE OF TENN. CODE ANN. §62-2-306.

SHEET NAME	SHEET NO.
SIGNATURE SHEET	.BRIDGE-SIGN1
TITLE SHEET	. 1
INDEX AND STANDARD DRAWINGS	. 1A
LAYOUT OF BRIDGES TO BE REPAIRED	.BR-131-902
GENERAL NOTES AND ESTIMATED BRIDGE QUANTITIES	.BR-131-903
PHASE CONSTRUCTION	.BR-131-904
SUPERSTRUCTURE REPAIRS	.BR-131-905
ABUTMENT REPAIRS LEFT BRIDGE	.BR-131-906
ABUTMENT REPAIRS RIGHT BRIDGE	.BR-131-907
BENT REPAIRS BENT 1 – LEFT BRIDGE	.BR-131-908
BENT REPAIRS BENT 2 – LEFT BRIDGE	.BR-131-909
BENT REPAIRS BENT 3 – LEFT BRIDGE	.BR-131-910
BENT REPAIRS BENT 1 – RIGHT BRIDGE	.BR-131-911
BENT REPAIRS BENT 2 – RIGHT BRIDGE	.BR-131-912
BENT REPAIRS BENT 3 – RIGHT BRIDGE	.BR-131-913
REPAIR DETAILS	.BR-131-914
CONCRETE REPAIR DETAILS	.BR-131-915

YEAR	PROJECT NO.	SHEET NO.
2025	30S034-M3-002	BRIDGE-SIGN1

S.R. 34

GREENE COUNTY

STATE OF TENNESSEE **DEPARTMENT OF TRANSPORTATION**

SIGNATURE SHEET

BRIDGE NO. 30-SR34-17.25 (R & L) FEDERAL BRIDGE ID NOS. 30FA0343003 & 30FA0343004 BRIDGES OVER SNAPPS FERRY RD. & NFS RAILROAD, LM 17.25 GREENE COUNTY 2025

OTILLI MANIL	SHEET NO.
SIGNATURE SHEET	BRIDGE-SIGN1
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INDEX OF SHEETS

SEE SHEET 1-A FOR INDEX AND STANDARD DRAWINGS

STATE OF TENNESSEE DEPARTMENT OF TRANSPORTATION BUREAU OF ENGINEERING

DOES THIS PROJECT QUALIFY FOR UTILITY CHAPTER 86	YES	NO X	
WORK ZONE SIGNIFICANCE DETERMI	NATION		
SIGNIFICANT	YES X	NO	

×	TENNI	YEAR	SHEET NO.
	TENN.	2025	1
_	FED. AID PROJ. NO.		
	STATE PROJ. NO.	30S034-	M3-002
	FED. BRIDGE ID NO.	30FA0343003	& 30FA0343004

GREENE COUNTY

STATE ROUTE 34 BRIDGES OVER SNAPPS FERRY ROAD AND NFS RAILWAY, LM 17.25


PS&E

BRIDGE REPAIR

STATE HIGHWAY NO. 34


F.A.H.S. NO. NA



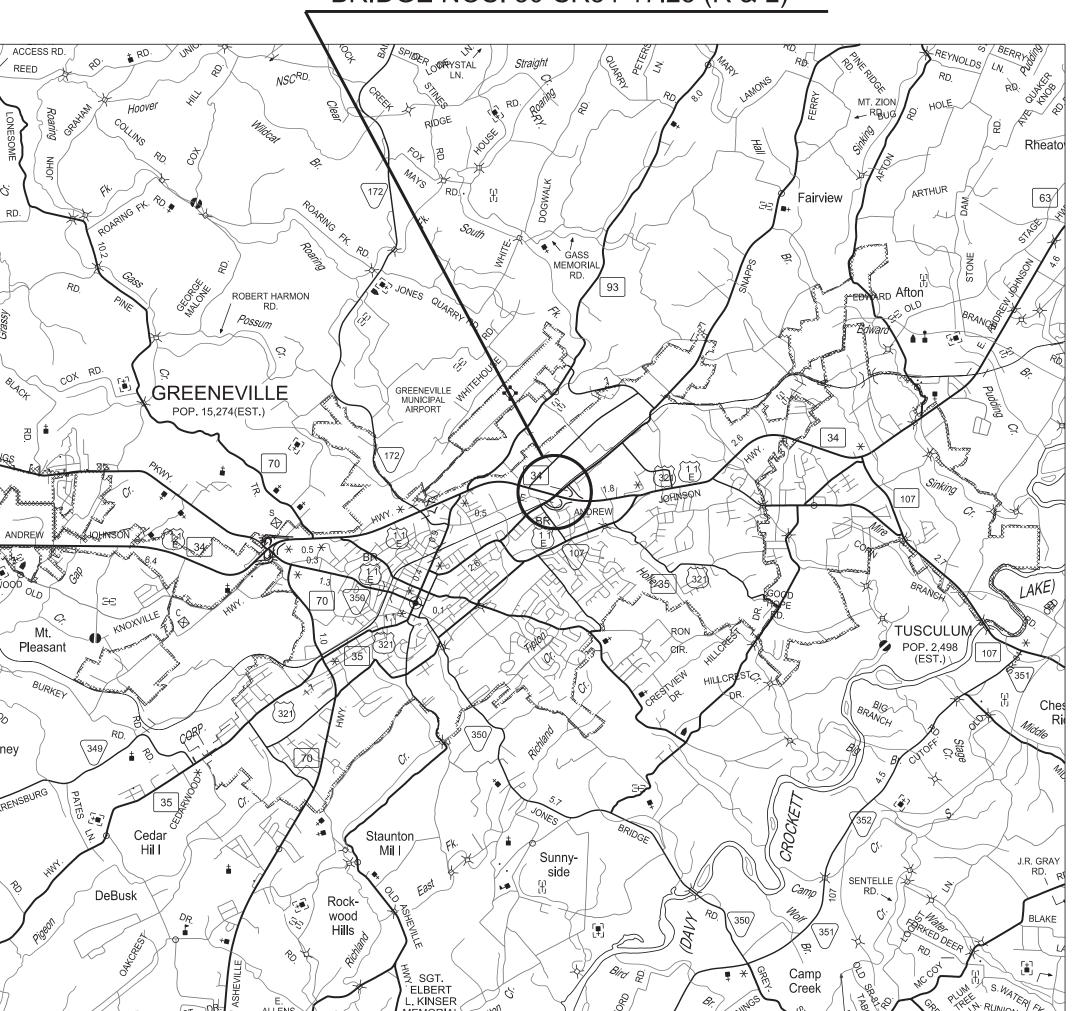


SCALE: 1" = 5,280' (1 MILE)


STEWART ORDERTSON SULLIVAN ACCORD CLAY PICKET OBION WEAKLEY HENRY HOUSTON DYER GIBSON CARROLL OFFICE ORDER OF THE PROPERTY
PROJECT LOCATION

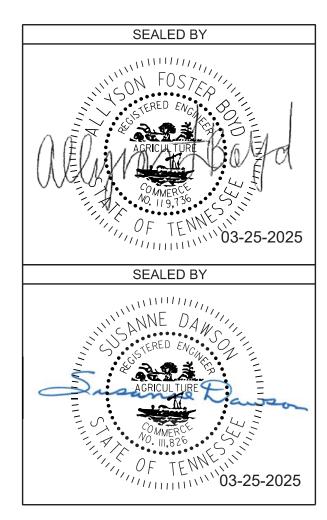

TRAFFIC DA Snapps Ferry	
ADT (2025)	6359
ADT (2045)	8903
DHV (2045)	979
D	51-49
T (ADT)	3
T (DHV)	3
V	40/45

TRAFFIC D SR 34	ATA
ADT (2025)	30630
ADT (2045)	42882
DHV (2045)	3430
D	51-49
T (ADT)	5
T (DHV)	5
V	30

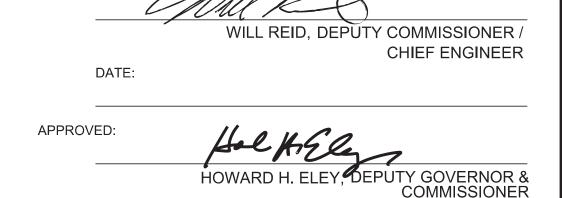

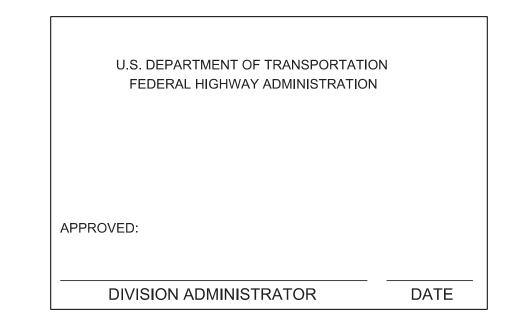

SPECIAL NOTES

PROPOSALS MAY BE REJECTED BY THE COMMISSIONER IF ANY OF THE UNIT PRICES CONTAINED THEREIN ARE OBVIOUSLY UNBALANCED, EITHER EXCESSIVE OR BELOW THE REASONABLE COST ANALYSIS VALUE.

THIS PROJECT TO BE CONSTRUCTED UNDER THE STANDARD SPECIFICATIONS OF THE TENNESSEE DEPARTMENT OF TRANSPORTATION DATED JANUARY 1, 2021 AND ADDITIONAL SPECIFICATIONS AND SPECIAL PROVISIONS CONTAINED IN THE PLANS AND IN THE PROPOSAL CONTRACT.

TDOT REPAIR OFFICE PROJECT MANAGER STEPHEN WILSON DESIGNED BY __CDM Smith DESIGNER SUSANNE DAWSON, P.E. P.E. NO. <u>30S034-M3-002</u>

PIN NO. <u>082699.01</u>

ROADWAY INDEX

SHEET NAME	SHEET NO
SIGNATURE SHEET	BRIDGE-SIGN
TITLE SHEET	1
INDEX AND STANDARD DRAWINGS	1A
PROJECT COMMITMENTS	1B
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TRAFFIC CONTROL PLAN WIDE LOAD DETOUR	3H

STANDARD ROADWAY DRAWINGS

DWG.	REV.	DESCRIPTION
ROADWAY	DESIGN S	TANDARDS

RD-A-1 02-20-20 STANDARD ABBREVIATIONS A THROUGH L STANDARD ABBREVIATIONS M THROUGH Z RD-A-2 02-20-20 STANDARD LEGEND

RD-L-1 RD-L-1A STANDARD LEGEND

SAFETY DESIGN AND GUARDRAILS

S-CZ-1	06-28-19	CLEAR ZONE CRITERIA
S-PL-3	03-01-23	SAFETY PLAN MINIMUM INSTALLATION AT BRIDGE ENDS
S-PL-5	06-28-19	SAFETY PLAN FOR BRIDGE ENDS IN MEDIANS
S-CC-1	10-01-24	CRASH CUSHION
S-GR31-1	06-15-21	GUARDRAIL DETAILS
S-GRC-4	01-30-25	GUARDRAIL CONNECTION TO BRIDGE RAILING CONCRETE PARAPET
S-GRC-5	02-28-20	GUARDRAIL CONNECTION TO BRIDGE ENDS (TRAILING ENDS)
S-GRT-2	06-28-19	TYPE 38 GUARDRAIL END TERMINAL
S-GRT-2P	10-16-20	EARTH PAD FOR TYPE 38 AND TYPE 21 TERMINAL
S-GRT-2R	06-28-19	EARTH PAD FOR TYPE 38 AND TYPE 21 TERMINAL (RETROFIT)
S-GRA-3	01-09-24	TYPE 13 GUARDRAIL ANCHOR

DESIGN -	TRAFFIC C	CONTROL
T-M-1	01-24-25	DETAILS OF PAVEMENT MARKINGS FOR CONVENTIONAL ROADS AND MARKING ABBREVIATIONS
T-WZ-10	04-02-12	ADVANCE ROAD WORK SIGNING ON HIGHWAYS AND FREEWAYS
T-WZ-11	03-04-21	ONE LANE CLOSURE DETAIL ON DIVIDED HIGHWAYS
T-WZ-12	03-04-21	ONE LANE CLOSURE DETAIL FOR BRIDGES ON DIVIDED HIGHWAYS
T-WZ-42	03-05-17	CENTER LANE CLOSURES AT NEAR SIDE OF INTERSECTIONS
T-WZ-PBR1	12-09-22	INTERCONNECTED PORTABLE BARRIER RAIL
T-WZ-PBR2	02-28-20	DETAILS FOR WORK ZONE CHANNELIZATION DEVICES
EROSION	PREVENT	ION AND SEDIMENT CONTROL

S-GR28-7M 06-28-19 GUARDRAIL ATTACHMENT TO BRIDGE END DETAILS

EC-STR-3C 03-01-23 SILT FENCE WITH WIRE BACKING

EC-STR-3D 03-01-23 ENHANCED SILT FENCE

EC-STR-37 06-10-14 SEDIMENT TUBE

LIST OF BRIDGE DRAWINGS

	<u>DRAWING</u>
DRAWING	NO.
LAYOUT OF BRIDGES TO BE REPAIRED	BR-131-902
GENERAL NOTES AND ESTIMATED BRIDGE QUANTITIES	BR-131-903
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REPAIR DETAILS	BR-131-914
CONCRETE REPAIR DETAILS	BR-131-915

LIST OF BRIDGE REFERENCE DRAWINGS

(TO BE PRINTED WITH PLANS) BR-16-74, BR-16-76 THRU BR-16-81, K-27-108 THRU K-27-112 AND K-15-65

STANDARD BRIDGE DRAWINGS


DRAWING	LATES


NO. REV. DATE	DRAWING
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05/10/2021 STANDARD PROTECTIVE FENCE DETAILS STD-8-5 STD-10-3 01/10/2024 STANDARD FLUME DETAILS

YEAR PROJECT NO. 2022 L&G 30S034-M3-002 2025 PS&E 30S034-M3-002

GREENE COUNTY S.R. 34



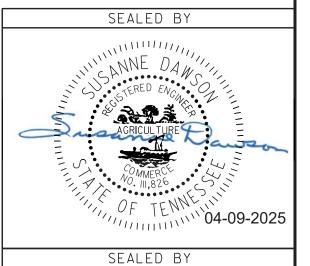

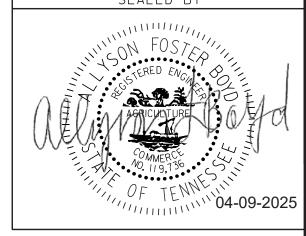STATE OF TENNESSEE DEPARTMENT OF TRANSPORTATION


> **INDEX** AND STANDARD **DRAWINGS**

PROJECT COMMITMENTS					
COMMITMENT ID	SOURCE DIVISON	DESCRIPTION	STA. / LOCATION		
EDHZ001	ENVIRONMENTAL DIVISION, HAZARDOUS MATERIALS	Asbestos Containing Material (ACM) surveys were completed on Bridge No. 30FA0343003 SR-34 EB over Snapps Ferry Road and NFSRR LM 17.25 (30-SR034-17.25R) and Bridge No. 30FA0343004 SR-34 WB over Snapps Ferry Road and NFSRR LM 17.25 (30-SR034-17.25L) and no ACM was detected. Please see the reports for further details and photographs. No special accommodations for demolition and waste disposal are anticipated for these structures and the material can be deposited in a C&D landfill. Prior to the demolition or rehabilitation of any structure (bridge or building), the contractor is required to submit the National Emission Standards for Hazardous Air Pollutants standard 10-day notice of demolition to the TDEC Division of Air Pollution Control (per TDOT Standard Specifications for Road and Bridge Construction (January 1, 2021) Sections 107.08.D and 202.03).			

TYPE	YEAR	PROJECT NO.	SHEET NO.
L&G	2022	30S034-M3-002	1B
PS&E	2025	30S034-M3-002	1B

S.R. 34

GREENE COUNTY

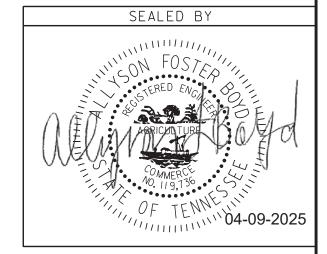

STATE OF TENNESSEE
DEPARTMENT OF TRANSPORTATION

PROJECT COMMITMENTS

		ESTIMATED ROADWAY QUANTITIES		
	ITEM NO.	DESCRIPTION	UNIT	QUANTITY
190900	201-01	CLEARING AND GRUBBING	LS	1
10 12 1 (2)	203-06	WATER	M.G.	0.32
(12)	209-08.02	TEMPORARY SILT FENCE (WITH BACKING)	L.F.	150
12	411-02.10	ACS MIX (PG70-22) GRADING D	TON	65
1	415-01.02	COLD PLANING BITUMINOUS PAVEMENT	S.Y.	977
100H0.0H0	705-06.10	GR TERMINAL TRAILING END (TYPE 13) MASH TL-3	EACH	2
0.00	707-08.11	HIGH-VISIBILITY CONSTRUCTION FENCE	L.F.	150
(5)	709-05.06	MACHINED RIP-RAP (CLASS A-1)	TON	387
53647	712-01	TRAFFIC CONTROL	LS	1
46	712-02.02	INTERCONNECTED PORTABLE BARRIER RAIL	L.F.	950
47	712-02.60	TEMPORARY WORK ZONE CRASH CUSHION (MASH TL-3)	EACH	2
4	712-04.01	FLEXIBLE DRUMS (CHANNELIZING)	EACH	130
4	712-04.50	BARRIER RAIL DELINEATOR	EACH	48
134	712-06	SIGNS (CONSTRUCTION)	S.F.	2044
4	712-07.03	TEMPORARY BARRICADES (TYPE III)	L.F.	30
	712-08.03	ARROW BOARD (TYPE C)	EACH	2
1	712-09.02	REMOVABLE PAVEMENT MARKING LINE (8" BARRIER LINE)	L.F.	13,220
1	712-09.31	REMOVABLE BLACK-OUT TAPE (8")	L.F.	8,000
0.000	716-12.02	ENHANCED FLATLINE THERMO PVMT MARKING (6IN LINE)	L.M.	0.3
_	717-01	MOBILIZATION	LS	1
(5)	740-10.04	GEOTEXTILE (TYPE IV) (STABILIZATION)	S.Y.	535
18	740-11.04	TEMPORARY SEDIMENT TUBE 20IN	L.F.	300
9	801-02	SEEDING (WITHOUT MULCH)	UNIT	3.2
911	805-12.01	EROSION CONTROL BLANKET (TYPE I)	S.Y.	354

FOOTNOTES

- 1 ITEM MAY BE INCREASED OR DECREASED AS DIRECTED BY THE TDOT ENGINEER.
- (GENERAL USE) AND 0.10 GAL/S.Y. (COLD PLANE AREAS).
- THIS ITEM INCLUDES THE INSPECTION AND MAINTENANCE OF ANY SIGNING AND TRAFFIC CONTROL APPURTENANCES DURING THE CONSTRUCTION OPERATIONS.
- 4 ALL COSTS ASSOCIATED WITH INSTALLING, STORING, AND RE-INSTALLING ALL TRAFFIC CONTROL DEVICES DURING AND BETWEEN THE DIFFERENT TRAFFIC CONTROL PHASES WILL BE INCLUDED IN THE BID ITEM OF EACH ITEM. DURING THE TIME BETWEEN DIFFERENT TRAFFIC CONTROL PHASES, THE CONTRACTOR SHALL STORE ALL TRAFFIC CONTROL DEVICES IN A PROPER LOCATION THAT WILL NOT INTERFERE WITH THE TRAFFIC FLOW. ALL WORK MUST MEET THE FULL APPROVAL OF THE TDOT ENGINEER.
- (5) FOR DRAINAGE DITCHES.
- (6) ITEM SHALL INCLUDE COST OF INSTALLING AND RELOCATING PORTABLE BARRIER RAIL.
- THIS ITEM SHALL BE A PORTABLE ENERGY ABSORBING TERMINAL MEETING THE REQUIREMENTS OF NCHRP 350 FOR TEST LEVEL 3. THE PAY ITEM WILL INCLUDE FURNISHING AND INSTALLING ALL COMPONENTS AS LISTED ON THE MANUFACTURER'S DRAWING.
- THIS ITEM INCLUDES ALL MATERIALS INCLUDING GEOTEXTILE FABRIC AND LABOR NECESSARY FOR CONSTRUCTION, MAINTENANCE, AND REMOVAL OF SEDIMENT TUBE.
- 9 FOR DISTURBED AREA RESTABILIZATION.
- for seeding.
- THIS ITEM SHALL INCLUDE ALL MATERIALS AND LABOR NECESSARY FOR CONSTRUCTION AND MAINTENANCE OF EROSION CONTROL BLANKETS.
- INCLUDES THE COST OF ALL LABOR AND MATERIALS FOR FURNISHING AND INSTALLING THE TEMPORARY SILT FENCE WHERE LOCATED BY THE ENGINEER, AND REMOVAL UPON PROJECT COMPLETION. ALSO INCLUDES COST TO REMOVE SEDIMENT ACCUMULATION. SEE STD. DWGS. EC-STR-3C AND EC-STR-3E.

UTILITY OWNERS

ELECTRIC:

GREENEVILLE LIGHT & POWER SYSTEM

P.O. BOX 1690 GREENEVILLE, TN 37744-1690 ATTENTION: STACY BOLTON sbolton@glps.net

PHONE: (423)636-6218; (423)832-0560

TELEPHONE:

CENTURYLINK

101 NORTH ROAN STREET
JOHNSON CITY, TN 37601
ATTENTION: ANDREW ICE
andrew.f.ice@centurylink.com
nationalrelo@centurylink.com
PHONE: (423)461-7724; (423)470-5636

SEWER:

GREENEVILLE WATER COMMISSION

P.O. BOX 368

516 N MAIN STREET GREENEVILLE, TN 37744-0368 ATTENTION: ERIC FRYE efrye@greenevillewater.org PHONE: (423)638-3148; (423)823-1330

WATER

GREENEVILLE WATER COMMISSION

P.O. BOX 368
516 N MAIN STREET
GREENEVILLE, TN 37744-0368
ATTENTION: ERIC FRYE
efrye@greenevillewater.org
PHONE: (423)638-3148; (423)823-1330

SAS.

ATMOS

2833 WEST MARKET STREET
JOHNSON CITY, TN 37604
ATTENTION: ISAIAH GREER/ SETH BRADBURN
isaiah.greer@atmosenergy.com
seth.bradburn@atmosenergy.com
PHONE: (423)202-1455; (423)440-4521

CABLE:

CHARTER COMMUNICATIONS – TRI-CITIES

ENGINEERING DEPT.

10417 WALLACE ALLEY STREET
KINGSPORT, TN 37663
ATTENTION: MARK TAYLOR; DON RILEY; ADAM
CLONINGER
mark.taylor2@charter.com
donald.riley@charter.com
adam.cloninger@charter.com

PHONE: (423)212-2349; (423)212-2344; (423)212-

FIBER OPTICS:


SUNSET DIGITAL COMMUNICATIONS, INC.

dba/ POINT BROADBAND
15022 LEE HIGHWAY
BRISTOL, VA 24202
ATTENTION: NOAH MADEN/ TIM NUTTER
noah.maden@point-broadband.com
tim.nutter@point-broadband.com
PHONE: (423)631-1166

UTILITY NOTES


UTILITY

(1) NO UTILITY CONFLICTS ARE ANTICIPATED BASED ON THE SCOPE OF WORK.

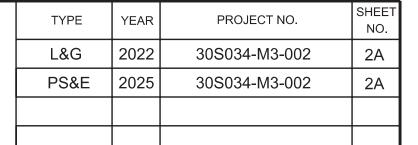

GREENE COUNTY

S.R. 34

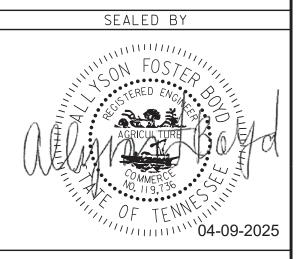

STATE OF TENNESSEE

DEPARTMENT OF TRANSPORTATION

ESTIMATED
ROADWAY
QUANTITIES
AND
UTILITY OWNERS

GUARDRAIL

(1) IF ANY APPROACH END OF A SECTION OF GUARDRAIL OR BRIDGE RAIL MUST TEMPORARILY BE LEFT INCOMPLETE AND EXPOSED TO TRAFFIC, THE CONTRACTOR SHALL USE TWO (2) TEMPORARY BARRICADES OR DRUMS WITH TYPE "A" LIGHTS AND ROUNDED END ELEMENTS AS MINIMUM MEASURES TO PROTECT TRAFFIC FROM THE HAZARD OF AN EXPOSED END. ALL COST OF FURNISHING AND INSTALLING TEMPORARY BARRICADES OR DRUMS WITH TYPE "A" LIGHTS TO DELINEATE GUARDRAIL END AND A TEMPORARY ROUNDED END ELEMENT SHALL BE INCLUDED IN THE COST OF THE PROPOSED GUARDRAIL END TERMINAL.

FINAL PAVEMENT MARKING

(1) PERMANENT PAVEMENT LINE MARKINGS SHALL BE 6" ENHANCED FLATLINE THERMOPLASTIC INSTALLED TO PERMANENT STANDARDS AT THE END OF EACH DAY'S WORK. SHORT UNMARKED SECTIONS SHALL NOT BE ALLOWED. PAVEMENT MARKINGS WILL BE MEASURED AND PAID FOR UNDER ITEM NO. 716-12.02, ENHANCED FLATLINE THERMO PVMT MRKNG (6IN LINE), L.M. THE CONTRACTOR SHALL HAVE THE OPTION OF USING REFLECTORIZED PAINT INSTALLED TO PERMANENT STANDARDS AT THE END OF EACH DAY'S WORK AND THEN INSTALLING THE PERMANENT MARKINGS AFTER THE PAVING OPERATION IS COMPLETED. THE TEMPORARY MARKINGS FOR THE FINAL SURFACE WILL NOT BE MEASURED AND PAID FOR DIRECTLY, BUT THE COSTS ARE TO BE INCLUDED IN THE PRICE BID FOR THE PERMANENT MARKINGS.

DETOURS, LANE SHIFTS AND MEDIAN CROSS-OVERS

- (1) THE PAVEMENT MARKING ON THE EDGELINE FOR LANE SHIFTS WILL BE INSTALLED AND MAINTAINED TO THE SAME STANDARDS AS FOR PERMANENT MARKINGS ON THE MAIN ROADWAY. THESE MARKINGS SHALL BE IN PLACE PRIOR TO ALLOWING TRAFFIC ONTO THE PAVEMENT. THESE PAVEMENT MARKINGS WILL BE MEASURED AND PAID FOR UNDER ITEM NO. 712-09.08 REMOVABLE PAVEMENT MARKING (6" LINE) (L.F.) OR 712-09.02 REMOVABLE PAVEMENT MARKING (8" BARRIER LINE) (L.F.). SEE PLANS FOR DETAILS.
- (2) BEFORE OPENING THE LANE SHIFTS TO TRAFFIC, THE TRANSITIONAL MARKINGS ON THE EXISTING ROADWAY MUST BE IN PLACE. THESE MARKINGS WILL BE MEASURED AND PAID FOR UNDER ITEM NO. 712-09.08 REMOVABLE PAVEMENT MARKING (6" LINE) (L.F.) OR 712-09.02 REMOVABLE PAVEMENT MARKING (8" BARRIER LINE) PER L.F. ALL EXISTING MARKINGS IN THE AREA OF THESE TRANSITIONAL MARKINGS SHALL BE OBLITERATED AND ALL EXISTING RAISED PAVEMENT MARKERS SHALL BE REMOVED TO ELIMINATE CONFLICTING MARKINGS. REMOVAL OF THE EXISTING CONFLICTING MARKINGS AND RAISED PAVEMENT MARKERS WILL NOT BE MEASURED AND PAID FOR DIRECTLY, BUT THE COST WILL BE INCLUDED IN ITEM NO. 712-01, TRAFFIC CONTROL, LUMP SUM.

PAVING

- (1) THE CONTRACTOR SHALL BE REQUIRED TO PAVE IN THE DIRECTION OF TRAFFIC.
- (2) THE CONTRACTOR SHALL BE REQUIRED TO COLD PLANE AND PAVE IN THE DIRECTION OF TRAFFIC.
- (3) THE CONTRACTOR SHALL ATTACH A DEVICE TO THE SCREED OF THE PAVER SUCH THAT MATERIAL IS CONFINED AT THE END GATE AND EXTRUDES THE ASPHALT MATERIAL IN SUCH A WAY THAT RESULTS IN A CONSOLIDATED WEDGE-SHAPE PAVEMENT EDGE OF APPROXIMATELY 25 TO 30 DEGREES AS IT LEAVES THE PAVER (MEASURED FROM A LINE PARALLEL TO THE PAVEMENT SURFACE.) THE DEVICE SHALL MEET THE REQUIREMENTS THAT ARE CURRENTLY SET FORTH IN SPECIAL PROVISION 407SE.

CONSTRUCTION WORK ZONE & TRAFFIC CONTROL

- (1) ADVANCED WARNING SIGNS SHALL NOT BE DISPLAYED MORE THAN FORTY-EIGHT (48) HOURS BEFORE PHYSICAL CONSTRUCTION BEGINS. SIGNS MAY BE ERECTED UP TO ONE WEEK BEFORE NEEDED, IF THE SIGN FACE IS FULLY COVERED.
- (2) IF THE CONTRACTOR MOVES OFF THE PROJECT, HE SHALL COVER OR REMOVE ALL UNNEEDED SIGNS AS DIRECTED BY THE ENGINEER. COSTS OF REMOVAL, COVERING, AND REINSTALLING SIGNS SHALL NOT BE MEASURED AND PAID FOR SEPARATELY, BUT ALL COSTS SHALL BE INCLUDED IN THE ORIGINAL UNIT PRICE BID FOR ITEM NO. 712-06, SIGNS (CONSTRUCTION) PER SQUARE FOOT.
- (3) A LONG TERM BUT SPORADIC USE WARNING SIGN, SUCH AS A FLAGGER SIGN, MAY REMAIN IN PLACE WHEN NOT REQUIRED PROVIDED THE SIGN FACE IS FULLY COVERED.

- TRAFFIC CONTROL DEVICES SHALL NOT BE DISPLAYED OR ERECTED UNLESS RELATED CONDITIONS ARE PRESENT NECESSITATING WARNING.
- USE OF BARRICADES, PORTABLE BARRIER RAILS, AND DRUMS SHALL BE LIMITED TO THE IMMEDIATE AREAS OF CONSTRUCTION WHERE A HAZARD IS PRESENT. THESE DEVICES SHALL NOT BE STORED ALONG THE ROADWAY WITHIN THIRTY (30) FEET OF THE EDGE OF THE TRAVELED WAY BEFORE OR AFTER USE UNLESS PROTECTED BY GUARDRAIL, BRIDGE RAIL, AND/OR BARRIERS INSTALLED FOR OTHER PURPOSES FOR ROADWAYS WITH CURRENT ADT'S LESS THAN 1500 AND DESIGN SPEED OF LESS THAN 60 MPH. THIS DISTANCE SHALL INCREASE TO FORTY-FIVE (45) FEET FOR ROADWAYS WITH CURRENT ADT'S OF 1500 OR GREATER AND DESIGN SPEED OF 60 MPH OR GREATER OR ON THE OUTSIDE OF A HORIZONTAL CURVE. THESE DEVICES SHALL BE REMOVED FROM THE CONSTRUCTION WORK ZONE WHEN THE ENGINEER DETERMINES THEY ARE NO LONGER NEEDED. WHERE THERE IS INSUFFICIENT RIGHT-OF-WAY TO PROVIDE FOR THIS REQUIRED SETBACK, THE CONTRACTOR SHALL DETERMINE THE ALTERNATE LOCATIONS AND REQUEST THE ENGINEER'S APPROVAL TO USE THEM.
- THE CONTRACTOR SHALL NOT BE PERMITTED TO PARK ANY VEHICLES OR CONSTRUCTION EQUIPMENT DURING PERIODS OF INACTIVITY, WITHIN THIRTY (30) FEET OF THE EDGE OF PAVEMENT WHEN THE LANE IS OPEN TO TRAFFIC UNLESS PROTECTED BY GUARDRAIL, BRIDGE RAIL, AND/OR BARRIERS INSTALLED FOR OTHER PURPOSES FOR ROADWAYS WITH CURRENT ADT'S LESS THAN 1500 AND DESIGN SPEED OF LESS THAN 60 MPH. THIS DISTANCE SHALL BE INCREASED TO FORTY-FIVE (45) FEET FOR ROADWAYS WITH CURRENT ADT'S OF 1500 OR GREATER AND DESIGN SPEED OF 60 MPH OR GREATER OR ON THE OUTSIDE OF A HORIZONTAL CURVE. PRIVATELY OWNED VEHICLES SHALL NOT BE ALLOWED TO PARK WITHIN THIRTY (30) FEET OF AN OPEN TRAFFIC LANE AT ANY TIME UNLESS PROTECTED AS DESCRIBED ABOVE FOR ROADWAYS WITH CURRENT ADT'S LESS THAN 1500 AND DESIGN SPEED OF LESS THAN 60 MPH. THIS DISTANCE SHALL BE INCREASED TO FORTY-FIVE (45) FEET FOR ROADWAYS WITH CURRENT ADT'S OF 1500 OR GREATER AND DESIGN SPEED OF 60 MPH OR GREATER OR ON THE OUTSIDE OF A HORIZONTAL CURVE. WHERE THERE IS INSUFFICIENT RIGHT-OF-WAY TO PROVIDE FOR THIS REQUIRED SETBACK. THE CONTRACTOR SHALL DETERMINE THE ALTERNATE LOCATIONS AND REQUEST THE ENGINEER'S APPROVAL TO USE THEM.
- (7) ALL DETOUR AND CONSTRUCTION SIGNING SHALL BE IN STRICT ACCORDANCE WITH THE MANUAL ON UNIFORM TRAFFIC CONTROL DEVICES.
- (8) ALL DETOURS SHALL BE PAVED, STRIPED, SIGNED, AND FLEXIBLE DRUMS ARE TO BE IN PLACE BEFORE IT IS OPENED TO TRAFFIC.
- (9) THE CONTRACTOR SHALL BE RESPONSIBLE FOR STAKING CONSTRUCTION SIGNS. THE COST OF THIS WORK SHALL BE INCLUDED IN ITEM NO. **712-06**, SIGNS (CONSTRUCTION), S.F.

SPECIAL NOTES

DEMOLITION. REPAIR. OR REHABILITATION OF BRIDGES

- (1) THE CONTRACTOR SHALL VERIFY THAT AN ASBESTOS SURVEY HAS BEEN COMPLETED PRIOR TO ANY DEMOLITION, REPAIR OR REHABILITATIONS ACTIVITIES (NOT INCLUDING ASPHALT MILLING OR OVERLAY).
- (2) ASBESTOS-CONTAINING MATERIALS (ACM) ABATEMENT IS THE RESPONSIBILITY OF THE CONTRACTOR AND SHALL BE COMPLETED PRIOR TO ANY DEMOLITION, REPAIR OR REHABILITATION OF BRIDGE(S). ABATEMENT SHOULD BE ACCOMPLISHED PER SP202ACM SPECIAL PROVISION REGARDING REMOVAL OF ASBESTOS-CONTAINING MATERIALS. STATE OF TENNESSEE ASBESTOS ACCREDITATION REQUIREMENTS (TCA 1200-01-20) MANDATE THAT ACM ABATEMENT WORK BE PERFORMED BY AN ACCREDITED FIRM (CONTRACTOR) USING ACCREDITED ABATEMENT WORKERS AND SUPERVISORS.
- (3) THE CONTRACTOR SHALL BE RESPONSIBLE FOR SUBMITTING A NOTICE TO THE TDEC, DIVISION OF AIR POLLUTION CONTROL TEN (10) DAYS IN ADVANCE OF ANY ACM ABATEMENT, DEMOLITION, OR MAJOR REPAIR INVOLVING THE REMOVAL/REPLACEMENT OF A STRUCTURAL COMPONENT.

DISTURBED AREA

- (1) IF DISTURBED ACREAGE IS EQUAL TO ONE ACRE OR MORE, PLEASE CONTACT TDOT ENVIRONMENTAL DIVISION, PERMITS SECTION AS SOON AS POSSIBLE BECAUSE AN NPDES PERMIT WILL BE REQUIRED.
- (2) AREAS TO BE UNDISTURBED SHALL BE CLEARLY MARKED IN THE FIELD BEFORE CONSTRUCTION ACTIVITIES BEGIN.
- (3) UNLESS OTHERWISE NOTED IN THE PLANS, THE CONTRACTOR SHALL NOT CLEAR/DISTURB ANY AREA BEYOND 15 FEET FROM SLOPE LINES.

- 4) PRE-CONSTRUCTION VEGETATIVE GROUND COVER SHALL NOT BE DESTROYED, REMOVED OR DISTURBED (I.E. CLEARING AND GRUBBING INITIATED) MORE THAN 14 CALENDAR DAYS PRIOR TO GRADING OR EARTH MOVING ACTIVITIES UNLESS THE AREA IS MULCHED, SEEDED WITH MULCH, OR OTHER TEMPORARY COVER IS APPLIED.
- (5) CLEARING, GRUBBING, AND OTHER DISTURBANCE TO RIPARIAN VEGETATION SHALL BE LIMITED TO THE MINIMUM NECESSARY FOR SLOPE CONSTRUCTION AND EQUIPMENT OPERATIONS. EXISTING VEGETATION, INCLUDING STREAM AND WETLAND BUFFERS (UNLESS PERMITTED), SHOULD BE PRESERVED TO THE MAXIMUM EXTENT POSSIBLE. UNNECESSARY VEGETATION REMOVAL IS PROHIBITED.

SEDIMENT CONTROL


- (6) EPSC MEASURES SHALL BE INSTALLED AND FUNCTIONAL PRIOR TO ANY EARTH MOVING OPERATIONS AND SHALL BE MAINTAINED THROUGHOUT THE CONSTRUCTION PERIOD EXCEPT AS SUCH WORK MAY BE NECESSARY TO INSTALL EPSC MEASURES.
- (7) TEMPORARY EPSC MEASURES MAY BE REMOVED AT THE BEGINNING OF THE WORKDAY BUT MUST BE REINSTALLED AT THE END OF THE WORKDAY OR BEFORE/DURING A PRECIPITATION EVENT.
- (8) THE CONTRACTOR SHALL ESTABLISH AND MAINTAIN A PROACTIVE METHOD TO PREVENT THE OFFSITE MIGRATION OR DEPOSIT OF SEDIMENT OFF THE PROJECT LIMITS (E.G. R.O.W., EASEMENTS, ETC.), INTO WATERS OF THE STATE/U.S., OR ONTO ROADWAYS USED BY THE GENERAL PUBLIC. IF SEDIMENT ESCAPES THE CONSTRUCTION SITE, OFFSITE ACCUMULATIONS OF SEDIMENT THAT HAVE NOT REACHED A STREAM MUST BE REMOVED AT A FREQUENCY SUFFICIENT TO MINIMIZE OFFSITE IMPACTS (E.G., FUGITIVE SEDIMENT THAT HAS ESCAPED THE CONSTRUCTION SITE AND HAS COLLECTED IN A STREET MUST BE REMOVED SO THAT IT IS NOT SUBSEQUENTLY WASHED INTO STORM SEWERS AND STREAMS BY THE NEXT RAIN AND/OR SO THAT IT DOES NOT POSE A SAFETY HAZARD TO USERS OF PUBLIC STREETS). ARRANGEMENTS CONCERNING REMOVAL OF SEDIMENT ON ADJOINING PROPERTY MUST BE NEGOTIATED WITH THE ADJOINING PROPERTY OWNER BEFORE REMOVAL OF SEDIMENT.
- OFFSITE VEHICLE TRACKING OF SEDIMENTS AND THE GENERATION OF DUST SHALL BE MINIMIZED. A STABILIZED CONSTRUCTION EXIT (A POINT OF ENTRANCE/EXIT TO THE CONSTRUCTION PROJECT) SHALL BE PROVIDED TO REDUCE THE TRACKING OF MUD AND DIRT ONTO PUBLIC ROADS BY CONSTRUCTION VEHICLES.
- THE DEWATERING OF WORK AREAS, TRENCHES, FOUNDATIONS, EXCAVATIONS, ETC. THAT HAVE COLLECTED STORMWATER, WATER FROM VEHICLE WASH AREAS. OR GROUNDWATER SHALL BE EITHER HELD IN SETTLING BASINS OR TREATED BY FILTRATION AND/OR CHEMICAL TREATMENT PRIOR TO ITS DISCHARGE. ALL PHYSICAL AND/OR CHEMICAL TREATMENT WILL BE APPLIED IN ACCORDANCE WITH THE MANUFACTURER'S GUIDELINES AND FULLY DESCRIBED IN THE EPSC PLANS. WATER DISCHARGED SHALL NOT CAUSE AN OBJECTIONABLE COLOR CONTRAST WITHIN THE RECEIVING NATURAL RESOURCE. WATER MUST BE HELD IN SETTLING BASINS UNTIL AT LEAST AS CLEAR AS THE RECEIVING WATERS. SETTLING BASINS SHALL NOT BE LOCATED CLOSER THAN 20 FEET FROM THE TOP BANK OF A STREAM. SETTLING BASINS AND SEDIMENT TRAPS SHALL BE PROPERLY DESIGNED ACCORDING TO THE SIZE OF THE DRAINAGE AREAS OR VOLUME OF WATER TO BE TREATED TREATED WATER MUST BE DISCHARGED THROUGH A PIPE OR WELL-VEGETATED OR LINED CHANNEL, SO THAT THE DISCHARGE DOES NOT CAUSE EROSION OR SEDIMENT TRANSPORT. DISCHARGES FROM BASINS AND IMPOUNDMENTS SHALL UTILIZE OUTLET STRUCTURES THAT ONLY WITHDRAW WATER FROM NEAR THE SURFACE OF THE BASIN OR IMPOUNDMENT, DISCHARGES MUST NOT CAUSE AN OBJECTIONABLE COLOR CONTRAST WITH THE RECEIVING STREAM.

INSPECTION, MAINTENANCE & REPAIR

- (12) THE TDOT CONSTRUCTION SUPERVISOR (OR THEIR DESIGNEE) AND THE CONTRACTOR'S RESPONSIBLE PARTY ARE RESPONSIBLE FOR INSPECTIONS. MAINTENANCE AND REPAIR ACTIVITIES ARE THE RESPONSIBILITY OF THE CONTRACTOR. THE TDOT CONSTRUCTION SUPERVISOR OR THEIR DESIGNEE SHALL COMPLETE THE EPSC INSPECTION REPORTS AND DISTRIBUTE COPIES PER THE CONTRACT.
- (13) TDOT CONSULTANTS AND CONTRACTOR STAFF RESPONSIBLE FOR THE INSPECTION, IMPLEMENTATION, MAINTENANCE, AND/OR REPAIR OF EPSC MEASURES SHALL SUCCESSFULLY COMPLETE THE TDEC "LEVEL 1 FUNDAMENTALS OF EROSION PREVENTION AND SEDIMENT CONTROL FOR CONSTRUCTION SITES" COURSE AND ANY REFRESHER COURSES AS REQUIRED TO MAINTAIN CERTIFICATION. TDOT STAFF AND SUPERVISORS RESPONSIBLE FOR THE INSPECTION, IMPLEMENTATION, MAINTENANCE, AND/OR REPAIR OF EPSC MEASURES SHALL SUCCESSFULLY COMPLETE THE TDOT "FUNDAMENTALS OF EROSION AND SEDIMENT CONTROL" CLASS AND ANY REFRESHER COURSES AS REQUIRED TO MAINTAIN CERTIFICATION.

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L&G	2022	30S034-M3-002	2B
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- (14) EPSC CONTROLS SHALL BE INSPECTED ACCORDING TO PERMIT REQUIREMENTS TO VERIFY MEASURES HAVE BEEN INSTALLED AND MAINTAINED IN ACCORDANCE WITH TDOT STANDARD DRAWINGS, SPECIFICATIONS, AND GOOD ENGINEERING PRACTICES. EPSC INSPECTIONS SHALL BE DOCUMENTED ON THE TDOT EPSC INSPECTION REPORT.
- (15) DISCHARGE POINTS SHALL BE INSPECTED TO ASCERTAIN WHETHER EPSC MEASURES ARE EFFECTIVE IN PREVENTING EROSION AND CONTROLLING SEDIMENT INCLUDING SIGNIFICANT IMPACTS TO SURROUNDING NATURAL RESOURCES AND ADJACENT PROPERTY OWNERS. WHERE DISCHARGE LOCATIONS ARE INACCESSIBLE, NEARBY DOWN GRADIENT LOCATIONS SHALL BE INSPECTED. LOCATIONS WHERE VEHICLES ENTER AND EXIT THE SITE SHALL BE INSPECTED FOR EVIDENCE OF OFFSITE ROADWAY SEDIMENT TRACKING.
- (16) UPON CONCLUSION OF THE INSPECTIONS, EPSC MEASURES FOUND TO BE INEFFECTIVE SHALL BE REPAIRED, REPLACED, OR MODIFIED BEFORE THE NEXT RAIN EVENT, IF POSSIBLE, BUT IN NO CASE MORE THAN 24 HOURS AFTER THE INSPECTION OR WHEN THE CONDITION IS IDENTIFIED. IF THE REPAIR, REPLACEMENT OR MODIFICATION IS NOT PRACTICAL WITHIN THE 24 HOUR TIMEFRAME, WRITTEN DOCUMENTATION SHALL BE PROVIDED IN THE FIELD DIARY AND EPSC INSPECTION REPORT. AN ESTIMATED REPAIR, REPLACEMENT OR MODIFICATION SCHEDULE SHALL BE DOCUMENTED WITHIN 24 HOURS AFTER IDENTIFICATION.
- (17) INSPECTION, REPAIR, AND MAINTENANCE OF EPSC MEASURES SHALL BE PERFORMED ON A REGULAR BASIS. SEDIMENT SHALL BE REMOVED FROM SEDIMENT CONTROL STRUCTURES WHEN THE DESIGN CAPACITY HAS BEEN REDUCED BY FIFTY PERCENT (50%). DURING SEDIMENT REMOVAL, THE CONTRACTOR SHALL TAKE STEPS TO ENSURE THAT STRUCTURAL COMPONENTS OF EPSC MEASURES ARE NOT DAMAGED AND THUS MADE INEFFECTIVE. IF DAMAGE DOES OCCUR, THE CONTRACTOR SHALL REPAIR THE EPSC MEASURES AT THE CONTRACTOR'S OWN EXPENSE.
- (18) THE EPSC PLAN SHALL BE UPDATED WHENEVER EPSC INSPECTIONS INDICATE, OR WHERE STATE OR FEDERAL OFFICIALS DETERMINE EPSC MEASURES ARE PROVING INEFFECTIVE IN ELIMINATING OR SIGNIFICANTLY MINIMIZING POLLUTANT SOURCES OR ARE OTHERWISE NOT ACHIEVING THE GENERAL OBJECTIVES OF CONTROLLING POLLUTANTS IN STORM WATER DISCHARGES ASSOCIATED WITH THE CONSTRUCTION ACTIVITY.
- (19) SEDIMENT REMOVED FROM SEDIMENT CONTROL STRUCTURES SHALL BE PLACED AND TREATED IN A MANNER SO THAT THE SEDIMENT IS CONTAINED WITHIN THE PROJECT LIMITS AND DOES NOT MIGRATE ONTO ADJACENT PROPERTIES AND INTO WATERS OF THE STATE/U.S. COST FOR THIS TREATMENT SHALL BE INCLUDED IN PRICE BID FOR ITEM NO. 209-05 SEDIMENT REMOVAL, C.Y.

ENVIRONMENTAL NOTES

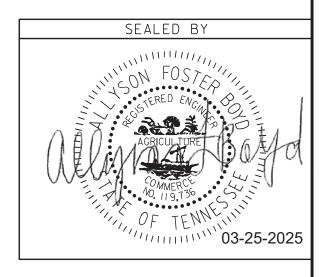ENVIRONMENTAL GENERAL NOTES

NATURAL RESOURCES

- (1) SOIL MATERIALS MUST BE PREVENTED FROM ENTERING WATERS OF THE STATE/U.S. EPSC MEASURES TO PROTECT NATURAL RESOURCES AND WATER QUALITY SHALL BE MAINTAINED THROUGHOUT THE CONSTRUCTION PERIOD. APPROPRIATE EPSC MEASURES MUST BE INSTALLED ALONG THE BASE OF ALL FILLS AND CUTS, ON THE DOWNHILL SIDE OF STOCKPILED SOIL, AND ALONG NATURAL RESOURCES IN CLEARED AREAS TO PREVENT SEDIMENT MIGRATION INTO STREAMS, WETLANDS OR OTHER NATURAL FEATURES IN ACCORDANCE WITH TDOT STANDARDS. EPSC MEASURES SHALL BE INSTALLED ON THE CONTOUR, ENTRENCHED AND STAKED, AND EXTEND THE WIDTH OF THE AREA TO BE CLEARED.
- (2) NEW CHANNEL CONSTRUCTION SHALL BE COMPLETED IN THE DRY AND STABILIZED FOR AT LEAST 72 HOURS PRIOR TO DIVERTING WATER FROM THE EXISTING AND/OR TEMPORARY CHANNEL.
- (3) INSTREAM EPSC DEVICES REQUIRE THE TDOT ENVIRONMENTAL DIVISION, PERMITS SECTION REVIEW AND MUST BE PROCESSED BY THE PERMITS SECTION TO OBTAIN WATER QUALITY PERMITS.
- (4) THE OPERATION OF EQUIPMENT IN WATERS OF THE STATE/U.S., INCLUDING WETLANDS AND EPHEMERAL, INTERMITTENT, AND PERENNIAL STREAMS. IS NOT ALLOWED.
- (5) THE WIDTH OF THE FILL ASSOCIATED WITH TEMPORARY CROSSINGS SHALL BE LIMITED TO THE MINIMUM NECESSARY FOR THE ACTUAL CROSSING, NOT TO EXCEED THE WIDTH SPECIFIED IN THE STANDARD DRAWING.
- (6) STREAM BEDS SHALL NOT BE USED AS TRANSPORTATION ROUTES FOR CONSTRUCTION EQUIPMENT. TEMPORARY CULVERT CROSSINGS SHALL BE LIMITED TO ONE POINT PER STREAM AND EPSC MEASURES SHALL BE

- USED WHERE THE STREAM BANKS ARE DISTURBED. WHERE THE STREAMBED IS NOT COMPOSED OF BEDROCK, A PAD OF CLEAN ROCK SHALL BE USED AT THE CROSSING POINT AND CULVERTED TO PREVENT THE IMPOUNDMENT OF WATER FLOW. CLEAN ROCK IS ROCK OF VARIOUS TYPE AND SIZE, DEPENDING UPON APPLICATION, WHICH CONTAINS NO FINES, SOILS, OR OTHER WASTES OR CONTAMINANTS. OTHER MATERIALS USED FOR ALL TEMPORARY FILLS SHALL BE COMPLETELY REMOVED IN THEIR ENTIRETY AFTER THE WORK IS COMPLETED AND THE AFFECTED AREAS RETURNED TO PREEXISTING ELEVATIONS. ALL TEMPORARY CROSSINGS SHALL BE CONSTRUCTED IN ACCORDANCE WITH STD. DWG. EC-STR-25 UNLESS SPECIFICALLY ADDRESSED IN THE EPSC PLANS. ALTERNATIVELY, PLACING A TEMPORARY BRIDGE (E.G. BAILEY BRIDGE OR EQUIVALENT, TIMBERS, ETC.) FROM TOP OF BANK TO TOP OF BANK OR THE APPROPRIATE USE OF BARGES AT THE CROSSING TO AVOID DISTURBANCE OF THE STREAMBED IS AN ACCEPTABLE OPTION.
- (7) HEAVY EQUIPMENT WORKING IN WETLANDS WITH PERMITTED TEMPORARY IMPACTS SHALL BE PLACED ON MATS, OR OTHER MEASURES MUST BE TAKEN TO MINIMIZE SOIL DISTURBANCE AND COMPACTION UNLESS SPECIFICALLY ADDRESSED IN THE CONSTRUCTION PLANS. ANY MATS AND OTHER MEASURES USED FOR HEAVY EQUIPMENT SHALL BE REMOVED IN THEIR ENTIRETY AFTER THE WORK IS COMPLETED. ALL AFFECTED AREAS SHOULD BE RETURNED TO PRE-EXISTING CONDITIONS.
- (8) WETLANDS SHALL NOT BE USED AS EQUIPMENT STORAGE, STAGING, OR TRANSPORTATION AREAS, UNLESS SPECIFICALLY PROVIDED FOR IN THE CONSTRUCTION PLANS AND PERMITS.
- THE CONTRACTOR SHALL TAKE APPROPRIATE STEPS PRIOR TO ANY CONSTRUCTION AND MAINTENANCE ACTIVITIES TO ENSURE THAT ENVIRONMENTAL FEATURES (E.G., STREAMS, WETLANDS, SPRINGS, ETC.) ARE NOT IMPACTED BEYOND PERMITTED LOCATIONS. IF THE CONTRACTOR OR TDOT INSPECTOR IS UNSURE OF THE IDENTITY OF AN ENVIRONMENTAL FEATURE, THE INSPECTOR SHALL CONTACT THE TDOT REGION ENVIRONMENTAL TECH GROUP IMMEDIATELY.

SPECIES

- (10) NO ACTIVITY MAY SUBSTANTIALLY DISRUPT THE MOVEMENT OF THOSE SPECIES OF AQUATIC LIFE INDIGENOUS TO THE WATER BODY, INCLUDING THOSE SPECIES THAT NORMALLY MIGRATE THROUGH THE AREA.
- (11) SHOULD CLIFF SWALLOW OR BARN SWALLOW NESTS, EGGS, OR BIRDS (YOUNG AND ADULTS) BE PRESENT, THE CONTRACTOR SHALL CONTACT THE REGIONAL ECOLOGY OFFICE TO DETERMINE IF SEASONAL RESTRICTIONS WILL BE NECESSARY. GENERALLY, BIRDS, NESTS, AND EGGS MAY NOT BE DISTURBED BETWEEN APRIL 15 AND JULY 31. FROM AUGUST 1 TO APRIL 14, NESTS CAN BE REMOVED OR DESTROYED SO LONG AS BIRDS OR EGGS ARE NOT PRESENT, AND MEASURES IMPLEMENTED TO PREVENT FUTURE NEST BUILDING AT THE SITE (I.E., CLOSING OFF AREA USING NETTING).
- (12) IF THE REMOVAL OF ANY TREES WITH A DIAMETER AT BREAST HEIGHT (DBH) GREATER THAN 3 INCHES IS DEEMED NECESSARY THE TDOT SUPERVISOR SHALL CONTACT THE TDOT ENVIRONMENTAL DIVISION, ECOLOGY SECTION IMMEDIATELY.

PERMITS, PLANS & RECORDS

- (13) THE CONTRACTOR SHALL BE SOLELY RESPONSIBLE FOR AND OBTAIN ANY NECESSARY ENVIRONMENTAL PERMITS OR APPROVALS, INCLUDING BUT NOT LIMITED TO ARCHAEOLOGY, ECOLOGY, HISTORICAL, HAZARDOUS MATERIALS, AIR AND NOISE, TDEC ARAP/401, USACE SECTION 404, TVA SECTION 26A, AND TDEC NPDES PERMITS, FROM FEDERAL, STATE AND/OR LOCAL AGENCIES REGARDING ANY MATERIAL AND STAGING AREAS AND THE OPERATION OF ANY PROJECT-DEDICATED ASPHALT AND/OR CONCRETE PLANTS TO BE USED. ANY SUCH PERMITS SHALL BE SUPPLIED TO THE TDOT PROJECT RESPONSIBLE PARTY PRIOR TO THE USE OF THE PERMITTED AREA(S).
- (14) ANY DISAGREEMENT BETWEEN THE CONSTRUCTION PLANS, THE PROJECT AS CONSTRUCTED, AND THE PERMIT(S) ISSUED FOR THE PROJECT, SHALL BE BROUGHT TO THE ATTENTION OF THE TDOT PROJECT RESPONSIBLE PARTY. THE ENVIRONMENTAL DIVISION, DESIGN DIVISION, AND HEADQUARTERS CONSTRUCTION OFFICE SHALL BE CONTACTED IN THESE INSTANCES AND DECIDE WHICH HAS PRECEDENCE AND WHETHER PERMIT OR PLANS REVISIONS ARE NEEDED. IN GENERAL, PERMIT CONDITIONS WILL PREVAIL.
- (15) IF A CHANGE IN PROJECT SCOPE OCCURS DURING CONSTRUCTION, INCLUDING VALUE ENGINEERING, THE TDOT PERMIT SECTION SHALL BE CONTACTED TO DETERMINE WHETHER PERMIT REVISIONS ARE NEEDED. THE ROADWAY DESIGN DIVISION SHALL BE CONTACTED TO DETERMINE IF ANY PLAN REVISIONS ARE NEEDED.
- (16) THE CONTRACTOR SHALL REVIEW ALL EXISTING PERMITS TO ENSURE THAT WORK AT PERMITTED SITES DOES NOT EXCEED EXPIRATION DATE. IF WORK IS GOING TO BE CONTINUED AFTER EXPIRATION DATES, THE

- CONTRACTOR SHALL CONTACT THE TDOT PROJECT RESPONSIBLE PARTY TO COMMENCE PERMIT RENEWAL PROCESS.
- (17) ALL WATER QUALITY PERMITS SHALL BE POSTED NEAR THE MAIN ENTRANCE OF THE CONSTRUCTION SITE ACCESSIBLE TO THE PUBLIC. THE NAME, COMPANY NAME, EMAIL ADDRESS, TELEPHONE NUMBER AND ADDRESS OF THE PROJECT SITE OWNER, OPERATOR, OR A LOCAL CONTACT PERSON WITH A BRIEF DESCRIPTION OF THE PROJECT SHALL ALSO BE POSTED. IF POSTING THIS INFORMATION NEAR A MAIN ENTRANCE IS INFEASIBLE, THE INFORMATION SHALL BE PLACED IN A PUBLICLY ACCESSIBLE LOCATION NEAR WHERE THE CONSTRUCTION IS ACTIVELY UNDERWAY AND MOVED AS NECESSARY. THIS LOCATION SHALL BE POSTED AT THE CONSTRUCTION SITE. ALL POSTINGS SHALL BE MAINTAINED IN LEGIBLE CONDITION.

SUPPORT ACTIVITIES

(18) MATERIALS AND STAGING AREAS SHALL NOT AFFECT ANY WATERS OF THE STATE/U.S. UNLESS THESE AREAS ARE SPECIFICALLY COVERED BY ENVIRONMENTAL PERMITS, OBTAINED SOLELY BY THE CONTRACTOR. THE CONTRACTOR SHALL REVIEW ALL EXISTING PERMITS TO ENSURE THAT WORK AT PERMITTED SITES DOES NOT EXCEED EXPIRATION DATES. IF WORK IS GOING TO BE CONTINUED AFTER EXPIRATION DATES, THE CONTRACTOR SHALL CONTACT THE TDOT PROJECT RESPONSIBLE PARTY TO COMMENCE PERMIT RENEWAL PROCESS.

ENVIRONMENTAL

(19) EXCEPT AS OTHERWISE SPECIFIED, THERE ARE NO KNOWN SPECIAL ENVIRONMENTAL FACTORS PRESENT ON THIS PROJECT THAT INDICATE A NEED FOR SEASONAL LIMITATIONS ON THE CLEARING, GRUBBING, EXCAVATION, GRADING, CUTTING OR FILLING OPERATIONS OR ON THE TOTAL AREA OF EXPOSED SOIL.

ENVIRONMENTAL SPECIAL NOTES

ENVIRONMENTAL

(1) STAFF FROM THE TDOT ENVIRONMENTAL DIVISION COMPLIANCE AND FIELD SERVICES OFFICE SHALL BE INVITED TO ALL PRE-CONSTRUCTION MEETINGS.

ECOLOGY

- (2) STAFF FROM THE TDOT ENVIRONMENTAL DIVISION OR A DESIGNEE SHALL ADVISE THE CONTRACTOR DURING THE PRE-CONSTRUCTION MEETING WHEN ENVIRONMENTAL DIVISION PERSONNEL OR A DESIGNATED CONSULTANT WILL NEED TO BE ONSITE FOR WORK BEING DONE WHICH COULD AFFECT WATERS OF THE STATE/U.S. OR SPECIES.
- (3) STAFF FROM THE TDOT ENVIRONMENTAL DIVISION OR A DESIGNEE SHALL ATTEND THE PRE-CONSTRUCTION MEETING FOR ALL PROJECTS WHICH HAVE THREATENED OR ENDANGERED SPECIES OR CRITICAL HABITAT PROXIMAL TO SCHEDULED WORK. THIS WILL PROVIDE THE OPPORTUNITY TO ENSURE THAT PERSONNEL INCLUDING THE CONTRACTOR'S PERSONNEL AND SUBCONTRACTORS ARE MADE AWARE OF THE NECESSARY PRECAUTIONS THAT MUST BE FOLLOWED.
- (4) ALL PROJECTS WITH LEGALLY PROTECTED SPECIES OR CRITICAL HABITAT IDENTIFIED SHALL HAVE MEASURES IN PLACE TO CONTAIN CONCRETE DUST, CEMENT DUST AND ALL OTHER MATERIALS. THESE MATERIALS ARE NOT ALLOWED TO ENTER WATERS OF THE STATE/U.S.

PROJECT COMMITMENTS

(5) SEE PROJECT COMMITMENTS, SHEET 1B FOR DETAILS RELATING TO SPECIAL ENVIRONMENTAL COMMITMENTS REQUIRED BY THIS PROJECT.


EROSION PREVENTION AND SEDIMENT CONTROL GENERAL NOTES

DISTURBED AREA

- (1) IF DISTURBED ACREAGE IS EQUAL TO ONE ACRE OR MORE, PLEASE CONTACT TDOT ENVIRONMENTAL DIVISION, PERMITS SECTION AS SOON AS POSSIBLE BECAUSE AN NPDES PERMIT WILL BE REQUIRED.
- (2) AREAS TO BE UNDISTURBED SHALL BE CLEARLY MARKED IN THE FIELD BEFORE CONSTRUCTION ACTIVITIES BEGIN.
- (3) UNLESS OTHERWISE NOTED IN THE PLANS, THE CONTRACTOR SHALL NOT CLEAR/DISTURB ANY AREA BEYOND 15 FEET FROM SLOPE LINES.

TYPE	YEAR	PROJECT NO.	SHEET NO.
L&G	2022	30S034-M3-002	2B1
PS&E	2025	30S034-M3-002	2B1

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STATE OF TENNESSEE

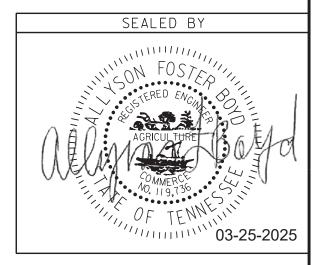DEPARTMENT OF TRANSPORTATION

- (4) PRE-CONSTRUCTION VEGETATIVE GROUND COVER SHALL NOT BE DESTROYED, REMOVED OR DISTURBED (I.E. CLEARING AND GRUBBING INITIATED) MORE THAN 14 CALENDAR DAYS PRIOR TO GRADING OR EARTH MOVING ACTIVITIES UNLESS THE AREA IS MULCHED, SEEDED WITH MULCH, OR OTHER TEMPORARY COVER IS APPLIED.
- (5) CLEARING, GRUBBING, AND OTHER DISTURBANCE TO RIPARIAN VEGETATION SHALL BE LIMITED TO THE MINIMUM NECESSARY FOR SLOPE CONSTRUCTION AND EQUIPMENT OPERATIONS. EXISTING VEGETATION, INCLUDING STREAM AND WETLAND BUFFERS (UNLESS PERMITTED), SHOULD BE PRESERVED TO THE MAXIMUM EXTENT POSSIBLE. UNNECESSARY VEGETATION REMOVAL IS PROHIBITED.

SEDIMENT CONTROL

- (6) EPSC MEASURES SHALL BE INSTALLED AND FUNCTIONAL PRIOR TO ANY EARTH MOVING OPERATIONS AND SHALL BE MAINTAINED THROUGHOUT THE CONSTRUCTION PERIOD EXCEPT AS SUCH WORK MAY BE NECESSARY TO INSTALL EPSC MEASURES.
- (7) TEMPORARY EPSC MEASURES MAY BE REMOVED AT THE BEGINNING OF THE WORKDAY BUT MUST BE REINSTALLED AT THE END OF THE WORKDAY OR BEFORE/DURING A PRECIPITATION EVENT.
- (8) THE CONTRACTOR SHALL ESTABLISH AND MAINTAIN A PROACTIVE METHOD TO PREVENT THE OFFSITE MIGRATION OR DEPOSIT OF SEDIMENT OFF THE PROJECT LIMITS (E.G. R.O.W., EASEMENTS, ETC.), INTO WATERS OF THE STATE/U.S., OR ONTO ROADWAYS USED BY THE GENERAL PUBLIC. IF SEDIMENT ESCAPES THE CONSTRUCTION SITE, OFFSITE ACCUMULATIONS OF SEDIMENT THAT HAVE NOT REACHED A STREAM MUST BE REMOVED AT A FREQUENCY SUFFICIENT TO MINIMIZE OFFSITE IMPACTS (E.G., FUGITIVE SEDIMENT THAT HAS ESCAPED THE CONSTRUCTION SITE AND HAS COLLECTED IN A STREET MUST BE REMOVED SO THAT IT IS NOT SUBSEQUENTLY WASHED INTO STORM SEWERS AND STREAMS BY THE NEXT RAIN AND/OR SO THAT IT DOES NOT POSE A SAFETY HAZARD TO USERS OF PUBLIC STREETS). ARRANGEMENTS CONCERNING REMOVAL OF SEDIMENT ON ADJOINING PROPERTY MUST BE NEGOTIATED WITH THE ADJOINING PROPERTY OWNER BEFORE REMOVAL OF SEDIMENT.
- (9) OFFSITE VEHICLE TRACKING OF SEDIMENTS AND THE GENERATION OF DUST SHALL BE MINIMIZED. A STABILIZED CONSTRUCTION EXIT (A POINT OF ENTRANCE/EXIT TO THE CONSTRUCTION PROJECT) SHALL BE PROVIDED TO REDUCE THE TRACKING OF MUD AND DIRT ONTO PUBLIC ROADS BY CONSTRUCTION VEHICLES.
- (10) THE DEWATERING OF WORK AREAS, TRENCHES, FOUNDATIONS, EXCAVATIONS, ETC. THAT HAVE COLLECTED STORMWATER, WATER FROM VEHICLE WASH AREAS, OR GROUNDWATER SHALL BE EITHER HELD IN SETTLING BASINS OR TREATED BY FILTRATION AND/OR CHEMICAL TREATMENT PRIOR TO ITS DISCHARGE. ALL PHYSICAL AND/OR CHEMICAL TREATMENT WILL BE APPLIED IN ACCORDANCE WITH THE MANUFACTURER'S GUIDELINES AND FULLY DESCRIBED IN THE EPSC PLANS. WATER DISCHARGED SHALL NOT CAUSE AN OBJECTIONABLE COLOR CONTRAST WITHIN THE RECEIVING NATURAL RESOURCE. WATER MUST BE HELD IN SETTLING BASINS UNTIL AT LEAST AS CLEAR AS THE RECEIVING WATERS. SETTLING BASINS SHALL NOT BE LOCATED CLOSER THAN 20 FEET FROM THE TOP BANK OF A STREAM. SETTLING BASINS AND SEDIMENT TRAPS SHALL BE PROPERLY DESIGNED ACCORDING TO THE SIZE OF THE DRAINAGE AREAS OR VOLUME OF WATER TO BE TREATED. TREATED WATER MUST BE DISCHARGED THROUGH A PIPE OR WELL-VEGETATED OR LINED CHANNEL, SO THAT THE DISCHARGE DOES NOT CAUSE EROSION OR SEDIMENT TRANSPORT. DISCHARGES FROM BASINS AND IMPOUNDMENTS SHALL UTILIZE OUTLET STRUCTURES THAT ONLY WITHDRAW WATER FROM NEAR THE SURFACE OF THE BASIN OR IMPOUNDMENT. DISCHARGES MUST NOT CAUSE AN OBJECTIONABLE COLOR CONTRAST WITH THE RECEIVING STREAM.

INSPECTION, MAINTENANCE & REPAIR

- (12) THE TDOT CONSTRUCTION SUPERVISOR (OR THEIR DESIGNEE) AND THE CONTRACTOR'S RESPONSIBLE PARTY ARE RESPONSIBLE FOR INSPECTIONS. MAINTENANCE AND REPAIR ACTIVITIES ARE THE RESPONSIBILITY OF THE CONTRACTOR. THE TDOT CONSTRUCTION SUPERVISOR OR THEIR DESIGNEE SHALL COMPLETE THE EPSC INSPECTION REPORTS AND DISTRIBUTE COPIES PER THE CONTRACT.
- (13) TDOT CONSULTANTS AND CONTRACTOR STAFF RESPONSIBLE FOR THE INSPECTION, IMPLEMENTATION, MAINTENANCE, AND/OR REPAIR OF EPSC MEASURES SHALL SUCCESSFULLY COMPLETE THE TDEC "LEVEL 1 FUNDAMENTALS OF EROSION PREVENTION AND SEDIMENT CONTROL FOR CONSTRUCTION SITES" COURSE AND ANY REFRESHER COURSES AS REQUIRED TO MAINTAIN CERTIFICATION. TDOT STAFF AND SUPERVISORS RESPONSIBLE FOR THE INSPECTION, IMPLEMENTATION, MAINTENANCE, AND/OR REPAIR OF EPSC MEASURES SHALL SUCCESSFULLY COMPLETE THE TDOT "FUNDAMENTALS OF EROSION AND SEDIMENT CONTROL" CLASS

- AND ANY REFRESHER COURSES AS REQUIRED TO MAINTAIN CERTIFICATION.
- (14) EPSC CONTROLS SHALL BE INSPECTED ACCORDING TO PERMIT REQUIREMENTS TO VERIFY MEASURES HAVE BEEN INSTALLED AND MAINTAINED IN ACCORDANCE WITH TDOT STANDARD DRAWINGS, SPECIFICATIONS, AND GOOD ENGINEERING PRACTICES. EPSC INSPECTIONS SHALL BE DOCUMENTED ON THE TDOT EPSC INSPECTION REPORT.
- (15) DISCHARGE POINTS SHALL BE INSPECTED TO ASCERTAIN WHETHER EPSC MEASURES ARE EFFECTIVE IN PREVENTING EROSION AND CONTROLLING SEDIMENT INCLUDING SIGNIFICANT IMPACTS TO SURROUNDING NATURAL RESOURCES AND ADJACENT PROPERTY OWNERS. WHERE DISCHARGE LOCATIONS ARE INACCESSIBLE, NEARBY DOWN GRADIENT LOCATIONS SHALL BE INSPECTED. LOCATIONS WHERE VEHICLES ENTER AND EXIT THE SITE SHALL BE INSPECTED FOR EVIDENCE OF OFFSITE ROADWAY SEDIMENT TRACKING.
- (16) UPON CONCLUSION OF THE INSPECTIONS, EPSC MEASURES FOUND TO BE INEFFECTIVE SHALL BE REPAIRED, REPLACED, OR MODIFIED BEFORE THE NEXT RAIN EVENT, IF POSSIBLE, BUT IN NO CASE MORE THAN 24 HOURS AFTER THE INSPECTION OR WHEN THE CONDITION IS IDENTIFIED. IF THE REPAIR, REPLACEMENT OR MODIFICATION IS NOT PRACTICAL WITHIN THE 24 HOUR TIMEFRAME, WRITTEN DOCUMENTATION SHALL BE PROVIDED IN THE FIELD DIARY AND EPSC INSPECTION REPORT. AN ESTIMATED REPAIR, REPLACEMENT OR MODIFICATION SCHEDULE SHALL BE DOCUMENTED WITHIN 24 HOURS AFTER IDENTIFICATION.
- (17) INSPECTION, REPAIR, AND MAINTENANCE OF EPSC MEASURES SHALL BE PERFORMED ON A REGULAR BASIS. SEDIMENT SHALL BE REMOVED FROM SEDIMENT CONTROL STRUCTURES WHEN THE DESIGN CAPACITY HAS BEEN REDUCED BY FIFTY PERCENT (50%). DURING SEDIMENT REMOVAL, THE CONTRACTOR SHALL TAKE STEPS TO ENSURE THAT STRUCTURAL COMPONENTS OF EPSC MEASURES ARE NOT DAMAGED AND THUS MADE INEFFECTIVE. IF DAMAGE DOES OCCUR, THE CONTRACTOR SHALL REPAIR THE EPSC MEASURES AT THE CONTRACTOR'S OWN EXPENSE.
- (18) THE EPSC PLAN SHALL BE UPDATED WHENEVER EPSC INSPECTIONS INDICATE, OR WHERE STATE OR FEDERAL OFFICIALS DETERMINE EPSC MEASURES ARE PROVING INEFFECTIVE IN ELIMINATING OR SIGNIFICANTLY MINIMIZING POLLUTANT SOURCES OR ARE OTHERWISE NOT ACHIEVING THE GENERAL OBJECTIVES OF CONTROLLING POLLUTANTS IN STORM WATER DISCHARGES ASSOCIATED WITH THE CONSTRUCTION ACTIVITY.
- (19) SEDIMENT REMOVED FROM SEDIMENT CONTROL STRUCTURES SHALL BE PLACED AND TREATED IN A MANNER SO THAT THE SEDIMENT IS CONTAINED WITHIN THE PROJECT LIMITS AND DOES NOT MIGRATE ONTO ADJACENT PROPERTIES AND INTO WATERS OF THE STATE/U.S. COST FOR THIS TREATMENT SHALL BE INCLUDED IN PRICE BID FOR ITEM NO. 209-05 SEDIMENT REMOVAL, C.Y.

EROSION PREVENTION

- (20) CONSTRUCTION SHALL BE SEQUENCED AND STAGED TO MINIMIZE THE EXPOSURE TIME OF GRADED OR DENUDED SOIL AREAS, PRESERVE TOPSOIL, AND MINIMIZE SOIL COMPACTION.
- (21) THE ACCEPTED EPSC PLAN SHALL REQUIRE THAT EPSC MEASURES BE IN PLACE BEFORE CLEARING, GRUBBING, EXCAVATION, GRADING, CULVERT OR BRIDGE CONSTRUCTION, CUTTING, FILLING, OR ANY OTHER EARTHWORK OCCURS, EXCEPT AS SUCH WORK MAY BE NECESSARY TO INSTALL EPSC MEASURES.
- (22) NO WORK SHALL BE STARTED UNTIL THE CONTRACTOR'S PLAN FOR THE STAGING OF OPERATIONS, INCLUDING THE PLAN FOR STAGING OF TEMPORARY AND PERMANENT EPSC MEASURES, HAS BEEN ACCEPTED BY THE TDOT RESPONSIBLE PARTY. THE CONTRACTOR'S EPSC PLAN SHALL INCORPORATE AND SUPPLEMENT, AS ACCEPTABLE, THE BASIC EPSC DEVICES ON THE EPSC PLAN.
- (23) TEMPORARY STABILIZATION SHALL BE INITIATED WITHIN 14 CALENDAR DAYS WHEN CONSTRUCTION ACTIVITIES ON A PORTION OF THE SITE ARE TEMPORARILY CEASED AND EARTH DISTURBING ACTIVITIES WILL NOT RESUME UNTIL AFTER 14 CALENDAR DAYS. PERMANENT STABILIZATION MEASURES IN DISTURBED AREAS SHALL BE INITIATED WITHIN 14 CALENDAR DAYS AFTER FINAL GRADING OF ANY PHASE OF CONSTRUCTION.
- (24) STEEP SLOPES SHALL BE TEMPORARILY STABILIZED NOT LATER THAN 7 DAYS AFTER CONSTRUCTION ACTIVITY ON THE SLOPE HAS TEMPORARILY OR PERMANENTLY CEASED. STEEP SLOPES ARE DEFINED AS A NATURAL OR CREATED SLOPE OF 35% GRADE OR GREATER REGARDLESS OF HEIGHT.
- (25) PERMANENT STABILIZATION WILL REPLACE TEMPORARY MEASURES AS SOON AS PRACTICABLE. PRIORITY SHALL BE GIVEN TO FINISHING OPERATIONS AND PERMANENT EPSC MEASURES OVER TEMPORARY EPSC MEASURES ON ALL PROJECTS.

- (26) TEMPORARY OR PERMANENT STABILIZATION MUST BE FREE OF FINES (SILT AND CLAY SIZED PARTICLES). UNPACKED GRAVEL CONTAINING FINES OR CRUSHER-RUN WILL NOT BE CONSIDERED SUFFICIENT STABILIZATION.
- (27) DELAYING THE PLANTING OF COVER VEGETATION UNTIL WINTER MONTHS OR DRY MONTHS SHOULD BE AVOIDED.

PERMITS, PLANS & RECORDS


(28) THE EPSC PLAN IS TO SERVE AS AN INITIAL GUIDE FOR SITE PERSONNEL AS THE CONSTRUCTION PROCESS DEVELOPS. IT MUST BE AMENDED, MODIFIED, AND UPDATED WHENEVER A CHANGE IN THE DESIGN OR CONSTRUCTION OF THE PROJECT OCCURS. THE STAGES DEPICTED IN THE EPSC PLANS MAY NOT COINCIDE WITH THE ACTUAL PHASES OF CONSTRUCTION ESTABLISHED BY THE CONTRACTOR DURING CONSTRUCTION, THUS MODIFICATIONS WILL BE REQUIRED TO ENSURE THE EPSC PLAN IS MAINTAINED TO DEPICT CURRENT SITE CONDITIONS. IT SHOULD BE MAINTAINED SUCH THAT IT WILL ALWAYS REFLECT THE MEASURES THAT ARE INSTALLED DURING THE VARIOUS PHASES OF CONSTRUCTION. IT IS IMPRACTICAL TO DETERMINE ALL THE INTERMEDIATE PHASES OF CONSTRUCTION THAT WILL OCCUR; THUS THESE DOCUMENTS WILL HAVE TO BE UPDATED THROUGHOUT THE LIFE OF THE CONSTRUCTION PROJECT.

GOOD HOUSEKEEPING MEASURES & WASTE DISPOSAL

- (29) THE CONTRACTOR SHALL ESTABLISH AND MAINTAIN A PROACTIVE METHOD TO PREVENT LITTER AND CONSTRUCTION WASTES FROM ENTERING WATERS OF THE STATE/U.S. THESE MATERIALS SHALL BE REMOVED FROM STORMWATER EXPOSURE PRIOR TO ANTICIPATED STORM EVENTS OR BEFORE BEING CARRIED OFFSITE BY WIND, OR OTHERWISE PREVENTED FROM BECOMING A POLLUTANT SOURCE FOR STORMWATER DISCHARGES. AFTER USE, MATERIALS USED FOR EPSC SHALL BE REMOVED FROM THE SITE.
- (30) THE CONTRACTOR SHALL TAKE APPROPRIATE STEPS TO ENSURE THAT PETROLEUM PRODUCTS OR OTHER CHEMICAL POLLUTANTS ARE PREVENTED FROM ENTERING WATERS OF THE STATE/U.S. ALL EQUIPMENT REFUELING, SERVICING, AND STAGING AREAS SHALL COMPLY WITH ALL LOCAL, STATE, AND FEDERAL LAWS, RULES, REGULATIONS, AND ORDINANCES, INCLUDING THOSE OF THE NATIONAL FIRE PROTECTION ASSOCIATION. APPROPRIATE CONTAINMENT MEASURES FOR THESE AREAS SHALL BE USED.
- 31) CONTRACTORS SHALL PROVIDE DESIGNATED TRUCK WASHOUT AREAS ON THE SITE. THESE AREAS MUST BE SELF CONTAINED, NOT CONNECTED TO ANY STORMWATER OUTLET OF THE SITE, AND PROPERLY SIGNED. WASH DOWN OR WASTE DISCHARGE OF CONCRETE TRUCKS SHALL NOT BE PERMITTED ONSITE UNLESS PROPER SETTLEMENT AREAS HAVE BEEN PROVIDED IN ACCORDANCE WITH BOTH STATE AND FEDERAL REGULATIONS.
- (32) WHEEL WASH WATER SHALL BE COLLECTED AND ALLOWED TO SETTLE OUT SUSPENDED SOLIDS PRIOR TO DISCHARGE. WHEEL WASH WATER SHALL NOT BE DISCHARGED DIRECTLY INTO ANY STORMWATER SYSTEM OR STORMWATER TREATMENT SYSTEM.
- (33) IF PORTABLE SANITARY FACILITIES ARE PROVIDED ON CONSTRUCTION SITES, SANITARY WASTE SHALL BE COLLECTED FROM THE PORTABLE UNITS IN A TIMELY MANNER BY A LICENSED WASTE MANAGEMENT CONTRACTOR OR AS REQUIRED BY ANY REGULATIONS. THE CONTRACTOR SHALL OBTAIN ANY AND ALL NECESSARY PERMITS TO DISPOSE OF SANITARY WASTE.
- (34) ONLY CONSTRUCTION PRODUCTS NEEDED SHALL BE STORED ONSITE BY THE CONTRACTOR. THE CONTRACTOR SHALL STORE ALL MATERIALS UNDER COVER AND IN APPROPRIATE CONTAINERS. PRODUCTS MUST BE STORED IN ORIGINAL CONTAINERS AND LABELED. MATERIAL MIXING SHALL BE CONDUCTED IN ACCORDANCE WITH THE MANUFACTURER'S RECOMMENDATIONS. THE CONTRACTOR'S RESPONSIBLE PARTY SHALL INSPECT MATERIALS STORAGE AREAS REGULARLY TO ENSURE PROPER USE AND DISPOSAL.
- (35) WHEN POSSIBLE, ALL PRODUCTS SHALL BE USED COMPLETELY BEFORE PROPERLY DISPOSING OF THE CONTAINER OFFSITE. THE MANUFACTURER'S DIRECTIONS FOR DISPOSAL OF MATERIALS AND CONTAINERS SHALL BE FOLLOWED.
- (36) ALL PAINT CONTAINERS SHALL BE TIGHTLY SEALED AND STORED WHEN NOT REQUIRED FOR USE. EXCESS PAINT SHALL BE DISPOSED OF ACCORDING TO THE MANUFACTURER'S INSTRUCTIONS AND APPLICABLE STATE AND LOCAL REGULATIONS.

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L&G	2022	30S034-M3-002	2B2
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STATE OF TENNESSEE

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- (37) ALL HAZARDOUS WASTE MATERIALS SHALL BE DISPOSED OF IN A MANNER WHICH IS COMPLIANT WITH LOCAL OR STATE REGULATIONS. SITE PERSONNEL SHALL BE INSTRUCTED IN THESE PRACTICES, AND THE INDIVIDUAL DESIGNATED AS THE CONTRACTOR'S RESPONSIBLE PARTY SHALL BE RESPONSIBLE FOR SEEING THAT THESE PRACTICES ARE FOLLOWED. THE CONTRACTOR SHALL OBTAIN ANY AND ALL NECESSARY PERMITS TO DISPOSE OF HAZARDOUS MATERIAL.
- (38) OPEN BURNING IS PROHIBITED UNLESS IT IS SPECIFICALLY ALLOWED BY LAW. IF ALLOWED, NATURAL VEGETATION, TREES, AND UNTREATED LUMBER SHALL BE THE ONLY MATERIALS THAT CAN BE OPEN BURNED. THE CONTRACTOR SHALL BE RESPONSIBLE FOR OBTAINING ALL APPLICABLE STATE AND LOCAL PERMITS PRIOR TO ANY BURNING.
- (39) DISPOSAL OF ONSITE VEGETATION AND TREES BY CHIPPING THEM INTO MULCH IS PREFERABLE TO OPEN BURNING. THIS MULCH MAY BE USED AS AN ONSITE SOIL STABILIZATION MEASURE WHERE APPROPRIATE.
- (40) WASTE MATERIAL (EARTH, ROCK, ASPHALT, CONCRETE, ETC.) NOT REQUIRED FOR THE CONSTRUCTION OF THE PROJECT WILL BE DISPOSED OF BY THE CONTRACTOR. IMPACTS TO WATERS OF THE STATE/U.S. SHALL BE AVOIDED IF POSSIBLE. IF UNAVOIDABLE, THE CONTRACTOR WILL OBTAIN ANY AND ALL NECESSARY PERMITS INCLUDING, BUT NOT LIMITED TO NPDES, AQUATIC RESOURCES ALTERATION PERMIT(S), CORPS OF ENGINEERS SECTION 404 PERMITS, AND TVA SECTION 26A PERMITS TO DISPOSE OF WASTE MATERIALS.

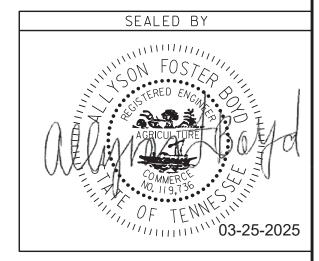SUPPORT ACTIVITIES

- (41) IF OFFSITE BORROW AND WASTE AREAS BECOME NECESSARY DURING THE LIFE OF THE PROJECT, THIS SUPPORT ACTIVITY SHALL BE ADDRESSED PER THE TDOT WASTE AND BORROW MANUAL.
- (42) MATERIALS AND STAGING AREAS SHALL BE LOCATED IN NON-WETLAND AREAS AND ABOVE THE 100-YEAR, FEDERAL EMERGENCY MANAGEMENT AGENCY FLOODPLAIN.
- (43) IT WILL BE THE RESPONSIBILITY OF THE CONTRACTOR TO SUPPLY EPSC PLANS FOR THE MATERIAL AND STAGING AREAS TO THE ENVIRONMENTAL DIVISION COMPLIANCE AND FIELD SERVICES OFFICE FOR REVIEW.

SPILL PREVENTION, MANAGEMENT & NOTIFICATION

- (44) ALL ONSITE VEHICLES SHALL BE MONITORED FOR LEAKS AND RECEIVE REGULAR PREVENTIVE MAINTENANCE TO REDUCE THE CHANCE OF LEAKAGE AND SPILLS.
- (45) FOR ALL HAZARDOUS MATERIALS STORED ONSITE, THE MANUFACTURER'S RECOMMENDED METHODS FOR SPILL CLEAN UP SHALL BE CLEARLY POSTED. SITE PERSONNEL SHALL BE MADE AWARE OF THE PROCEDURES AND THE LOCATIONS OF THE INFORMATION AND CLEANUP SUPPLIES.
- (46) APPROPRIATE CLEANUP MATERIALS AND EQUIPMENT SHALL BE MAINTAINED BY THE CONTRACTOR IN THE MATERIALS STORAGE AREA ONSITE AND UNDER COVER. SPILL RESPONSE EQUIPMENT SHALL BE INSPECTED AND MAINTAINED BY THE CONTRACTOR AS NECESSARY TO REPLACE ANY MATERIALS USED IN SPILL RESPONSE ACTIVITIES.
- (47) ALL SPILLS SHALL BE CLEANED IMMEDIATELY AFTER DISCOVERY AND THE MATERIALS DISPOSED OF PROPERLY. THE SPILL AREA SHALL BE KEPT WELL VENTILATED AND PERSONNEL WILL WEAR APPROPRIATE PROTECTIVE CLOTHING TO PREVENT INJURY FROM CONTACT WITH A HAZARDOUS SUBSTANCE.
- (48) THE CONTRACTOR'S RESPONSIBLE PARTY SHALL BE THE SPILL PREVENTION AND CLEANUP COORDINATOR. THE CONTRACTOR IS RESPONSIBLE FOR ENSURING THAT THE SITE SUPERINTENDENT HAS HAD APPROPRIATE TRAINING FOR HAZARDOUS MATERIALS HANDLING, SPILL MANAGEMENT. AND CLEANUP.
- (49) IF AN OIL SHEEN IS OBSERVED ON SURFACE WATER (E.G. SETTLING PONDS, DETENTION PONDS, SWALES), ACTION SHALL BE TAKEN IMMEDIATELY TO REMOVE THE MATERIAL CAUSING THE SHEEN. THE CONTRACTOR SHALL USE APPROPRIATE MATERIALS TO CONTAIN AND ABSORB THE SPILL. THE SOURCE OF THE OIL SHEEN WILL ALSO BE IDENTIFIED AND REMOVED OR REPAIRED AS NECESSARY TO PREVENT FURTHER RELEASES.
- (50) FERTILIZERS SHALL BE APPLIED ONLY IN THE AMOUNTS SPECIFIED. ONCE APPLIED, FERTILIZERS SHALL BE WORKED INTO THE SOIL TO LIMIT THE EXPOSURE TO STORMWATER.
- (51) IF A SPILL OCCURS THE CONTRACTOR'S RESPONSIBLE PARTY SHALL BE RESPONSIBLE FOR COMPLETING THE SPILL REPORTING FORM AND FOR REPORTING THE SPILL TO THE TDOT PROJECT RESPONSIBLE PARTY. ALL SPILLS MUST BE REPORTED TO THE APPROPRIATE AGENCY, AND


- MEASURES SHALL BE TAKEN IMMEDIATELY TO PREVENT THE POLLUTION OF WATERS OF THE STATE/U.S., INCLUDING GROUNDWATER, SHOULD A SPILL OCCUR.
- (52) WHERE A RELEASE CONTAINING A HAZARDOUS SUBSTANCE IN AN AMOUNT EQUAL TO OR IN EXCESS OF A REPORTABLE QUANTITY ESTABLISHED UNDER EITHER 40 CFR 117 OR 40 CFR 302 OCCURS DURING A 24 HOUR PERIOD, SEE THE LATEST TENNESSEE GENERAL PERMIT NO. TNR100000 STORMWATER DISCHARGES FROM CONSTRUCTION ACTIVITIES SECTION 5.1 FOR REPORTING REQUIREMENTS.
- (53) CONTRACTOR'S BULK FUEL AND PETROLEUM PRODUCTS STORED ONSITE OR ADJACENT TO THE R.O.W. IN ABOVE GROUND STORAGE CONTAINERS WITH A COMBINED CAPACITY OF 1320 GALLONS OR MORE SHALL HAVE SECONDARY CONTAINMENT. THE CONTRACTOR SHALL BE RESPONSIBLE FOR PREPARING A SPILL PREVENTION CONTROL AND COUNTERMEASURE (SPCC) PLAN FOR THE BULK STORAGE AND BE SOLELY RESPONSIBLE FOR OBTAINING ANY NECESSARY LOCAL, STATE, AND FEDERAL PERMITS. THE SPCC PLAN AND/OR PERMITS SHALL BE KEPT ONSITE AND A COPY PROVIDED TO THE TDOT PROJECT RESPONSIBLE PARTY PRIOR TO STORING 1320 GALLONS ON SITE.

STREAMS, WETLANDS & BUFFER ZONES

(54) ANY WORK WITHIN THE STREAM CHANNEL AREA (E.G., PIER FOOTING, RIP-RAP PLACEMENT, CULVERT/BRIDGE CONSTRUCTION, ETC.) SHALL BE SEPARATED FROM FLOWING WATER OR EXPECTED FLOW PATH AND PERFORMED DURING LOW FLOW CONDITIONS. ALL ITEMS USED WITHIN THE STREAM CHANNEL AREA FOR DIVERSION OF FLOW (OR EXPECTED FLOW), UNLESS SPECIFIED IN THE PLANS, SHALL NOT BE PAID FOR DIRECTLY BUT SHALL BE INCLUDED IN THE COST OF OTHER ITEMS. THIS NOTE EXCLUDES ANY ITEMS SPECIFIED IN THE PLANS FOR THE TEMPORARY DIVERSION CHANNELS (EC-STR-31) AND TEMPORARY DIVERSION CULVERTS (EC STR-32) FOR SINGLE BARREL CULVERT CONSTRUCTION.

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L&G	2022	30S034-M3-002	2B3
PS&E	2025	30S034-M3-002	2B3

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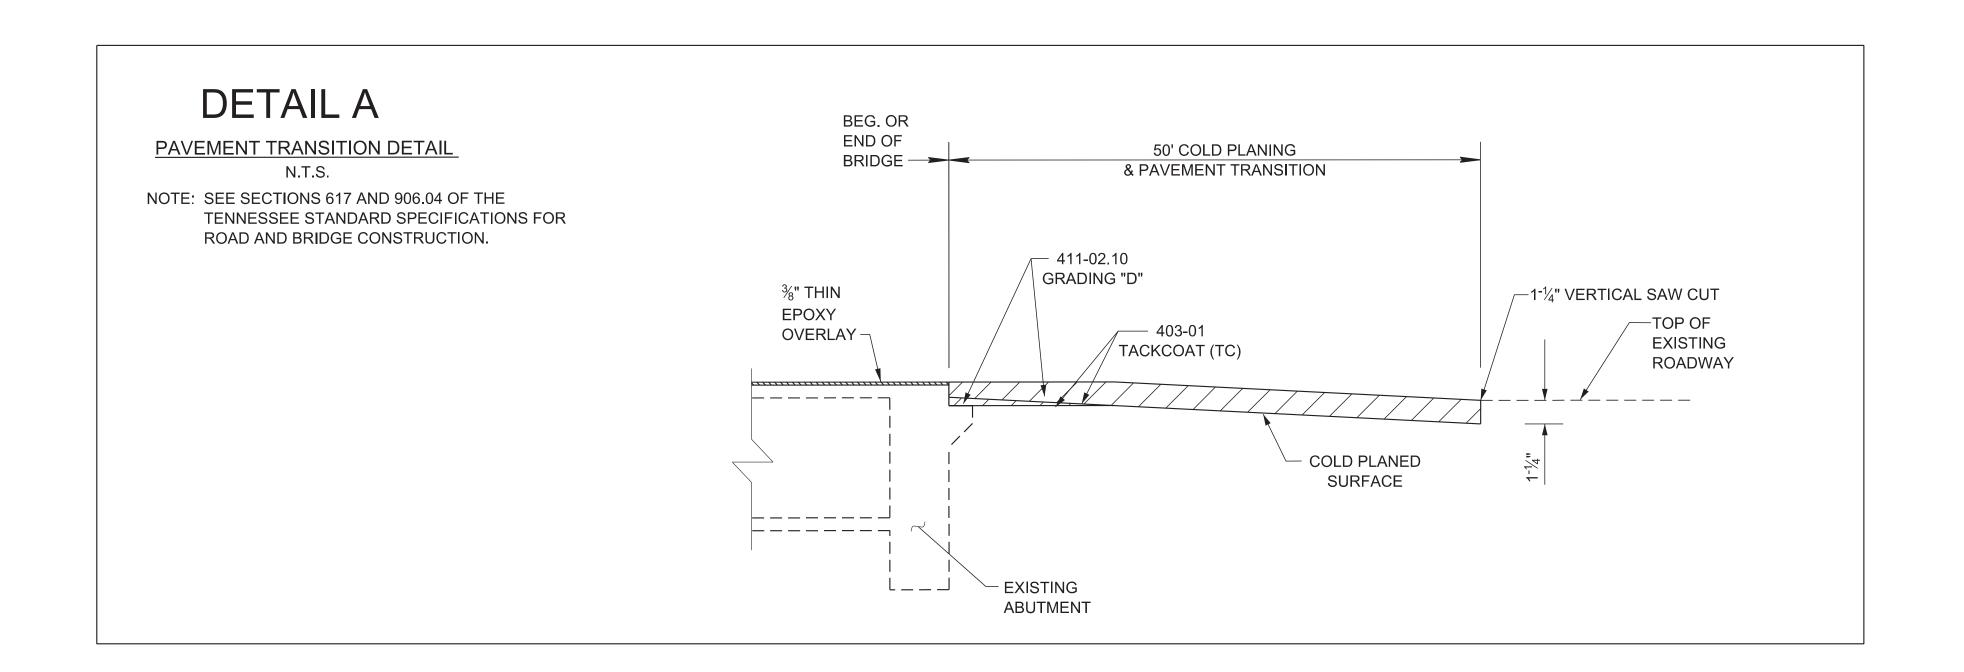


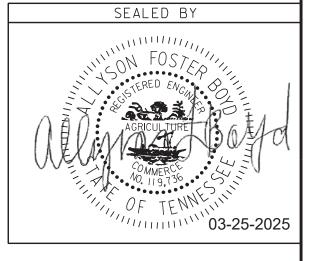
STATE OF TENNESSEE


DEPARTMENT OF TRANSPORTATION

TYPE	YEAR	PROJECT NO.	SHEET NO.
L&G	2022	30S034-M3-002	2C
PS&E	2025	30S034-M3-002	2C





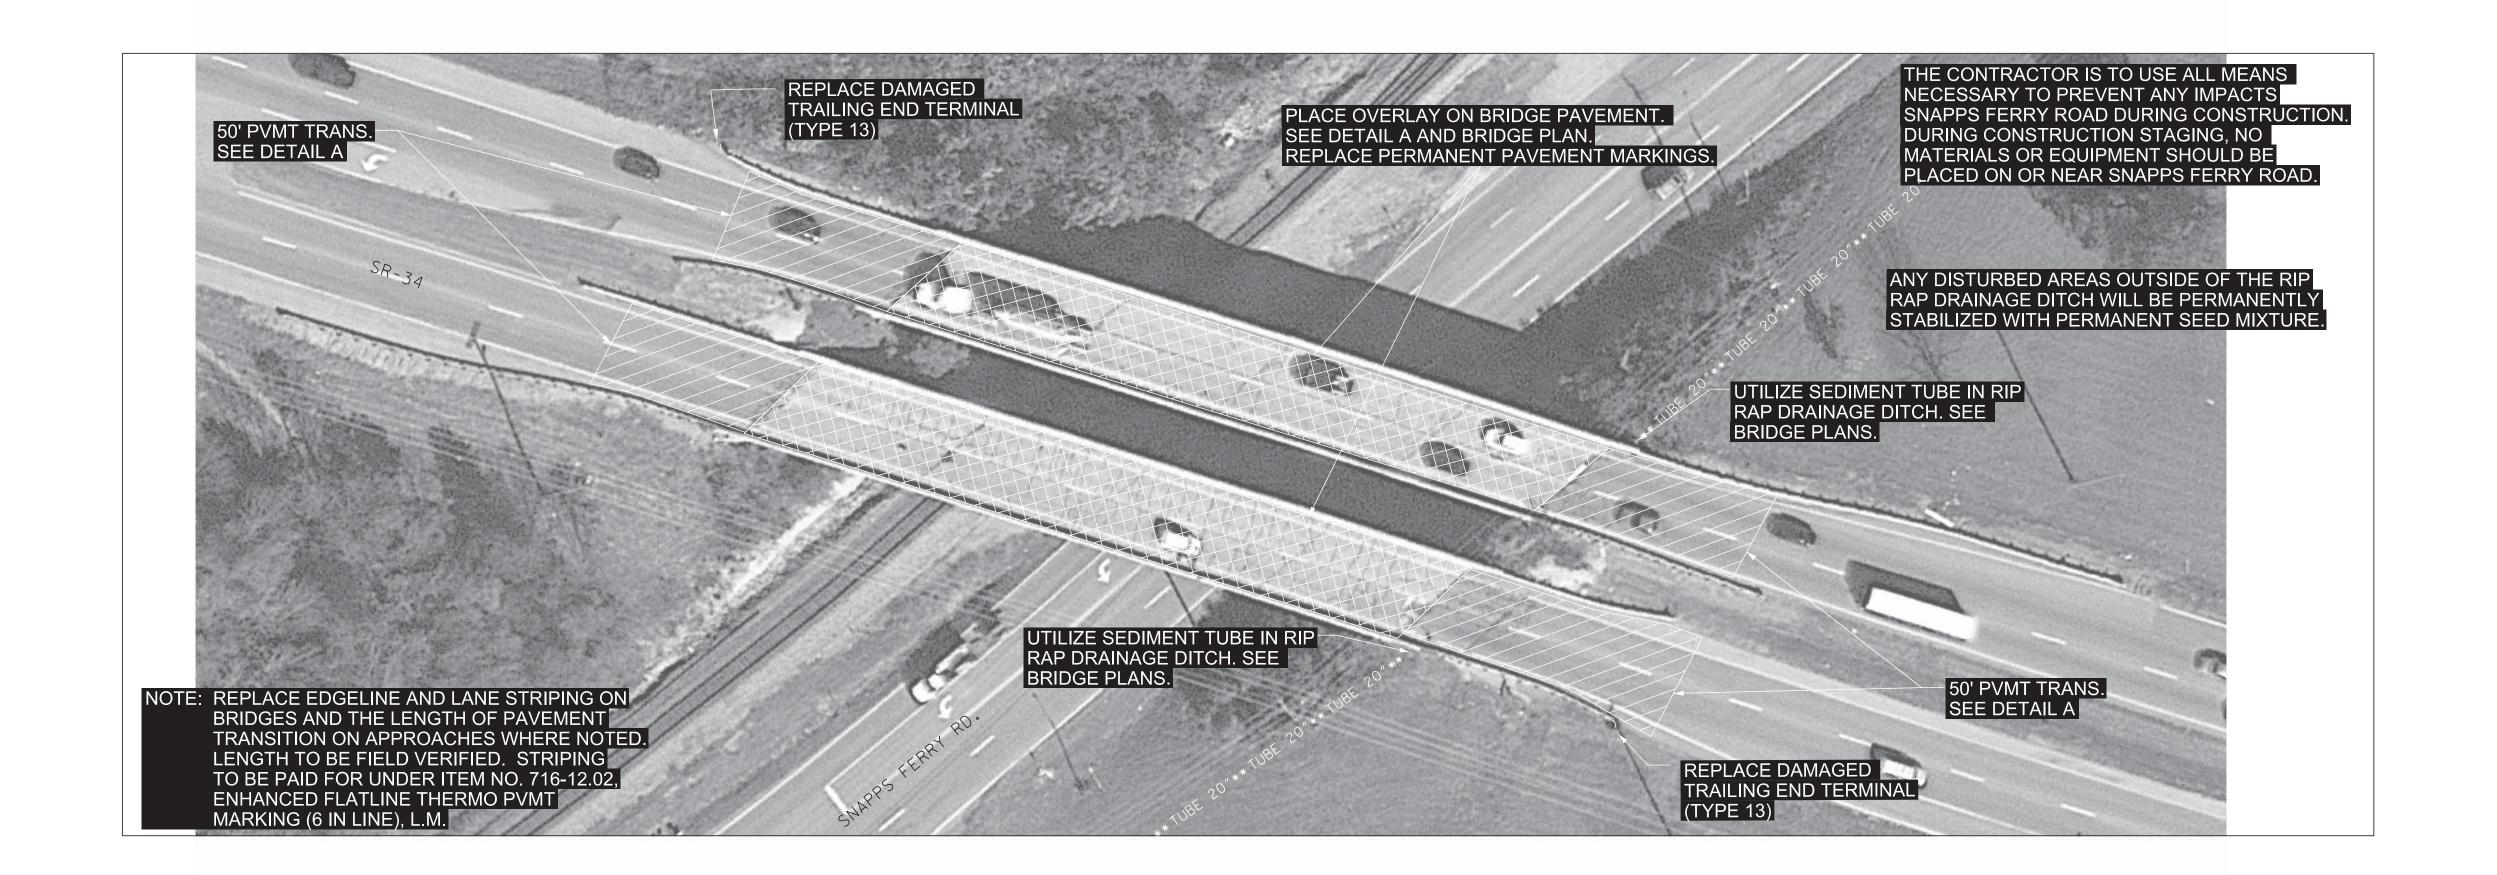

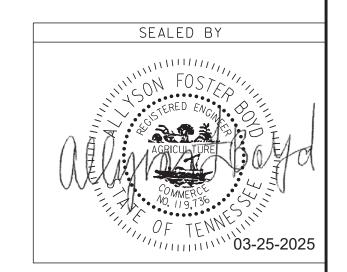



STATE OF TENNESSEE

DEPARTMENT OF TRANSPORTATION

GUARDRAIL PLAN AND PAVEMENT TRANSITION DETAILS

S.R. 34 OVER SNAPPS FERRY RD.

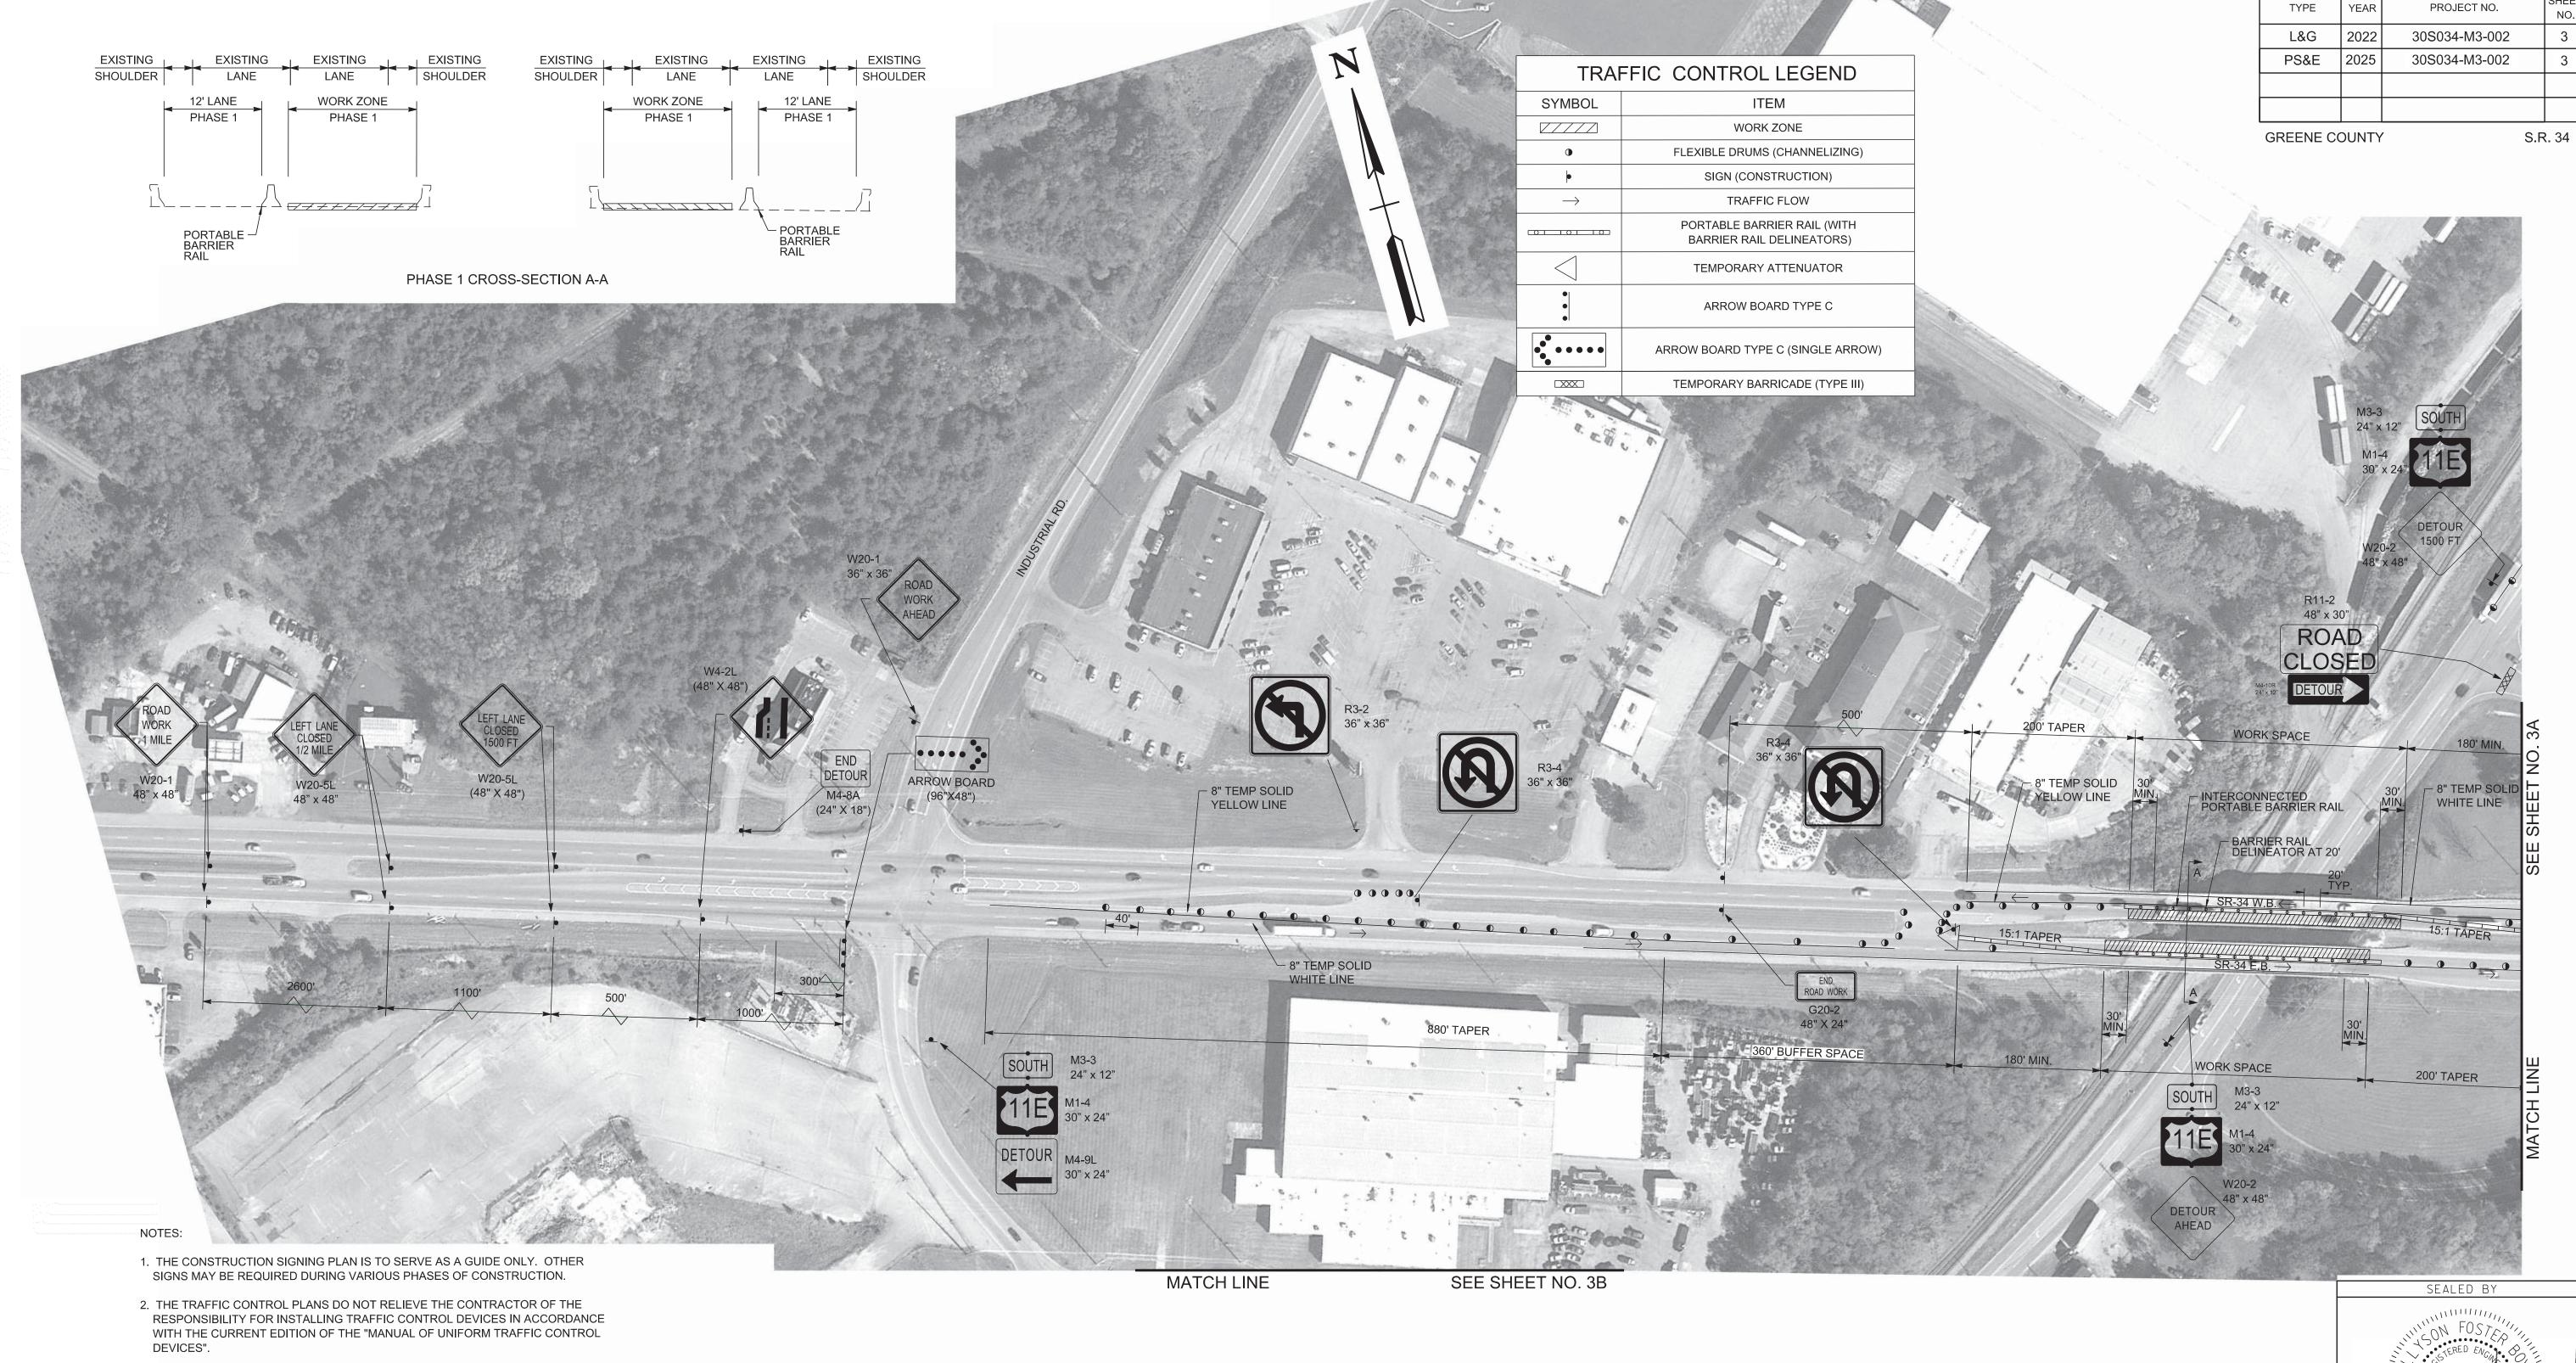

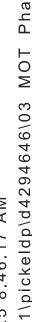

3. THIS TRAFFIC CONTROL PLAN CAN BE USED FOR THE CLOSURE

LANE CLOSURE SIGNS.

SIGNS (CONSTRUCTION), SQ. FT.

6. SEE SHEET 2A FOR QUANTITIES.

OPEN. SEE SHEETS 3F-H FOR DETAILS.

OF THE INSIDE OR OUTSIDE LANES OF SR-34 WITH LANE SHIFT. USE APPROPRIATE

4. IF ADDITIONAL SIGNS ARE DEEMED NECESSARY BY THE ENGINEER, THEY SHALL BE FURNISHED AND INSTALLED AT THE UNIT PRICE BID FOR ITEM NO. 712-06,

5. FOR ADDITIONAL NOTES AND DETAILS, SEE STD DWG. T-WZ-12 AND MUTCD FIGURE


7. OVERSIZE LOAD VEHICLES THAT CANNOT BE ACCOMMODATED WITHIN THE WORK ZONE SHALL BE DETOURED AROUND THE PROJECT AREA WITH APPROPRIATE

SIGNAGE. DETOUR SHALL OCCUR WHEN ALL LANES ON SNAPPS FERRY ROAD ARE


STATE OF TENNESSEE
DEPARTMENT OF TRANSPORTATION

TRAFFIC CONTROL PLAN

BR. NO. 30-SR34-17.25 (LEFT & RIGHT) SCALE: 1"=200'

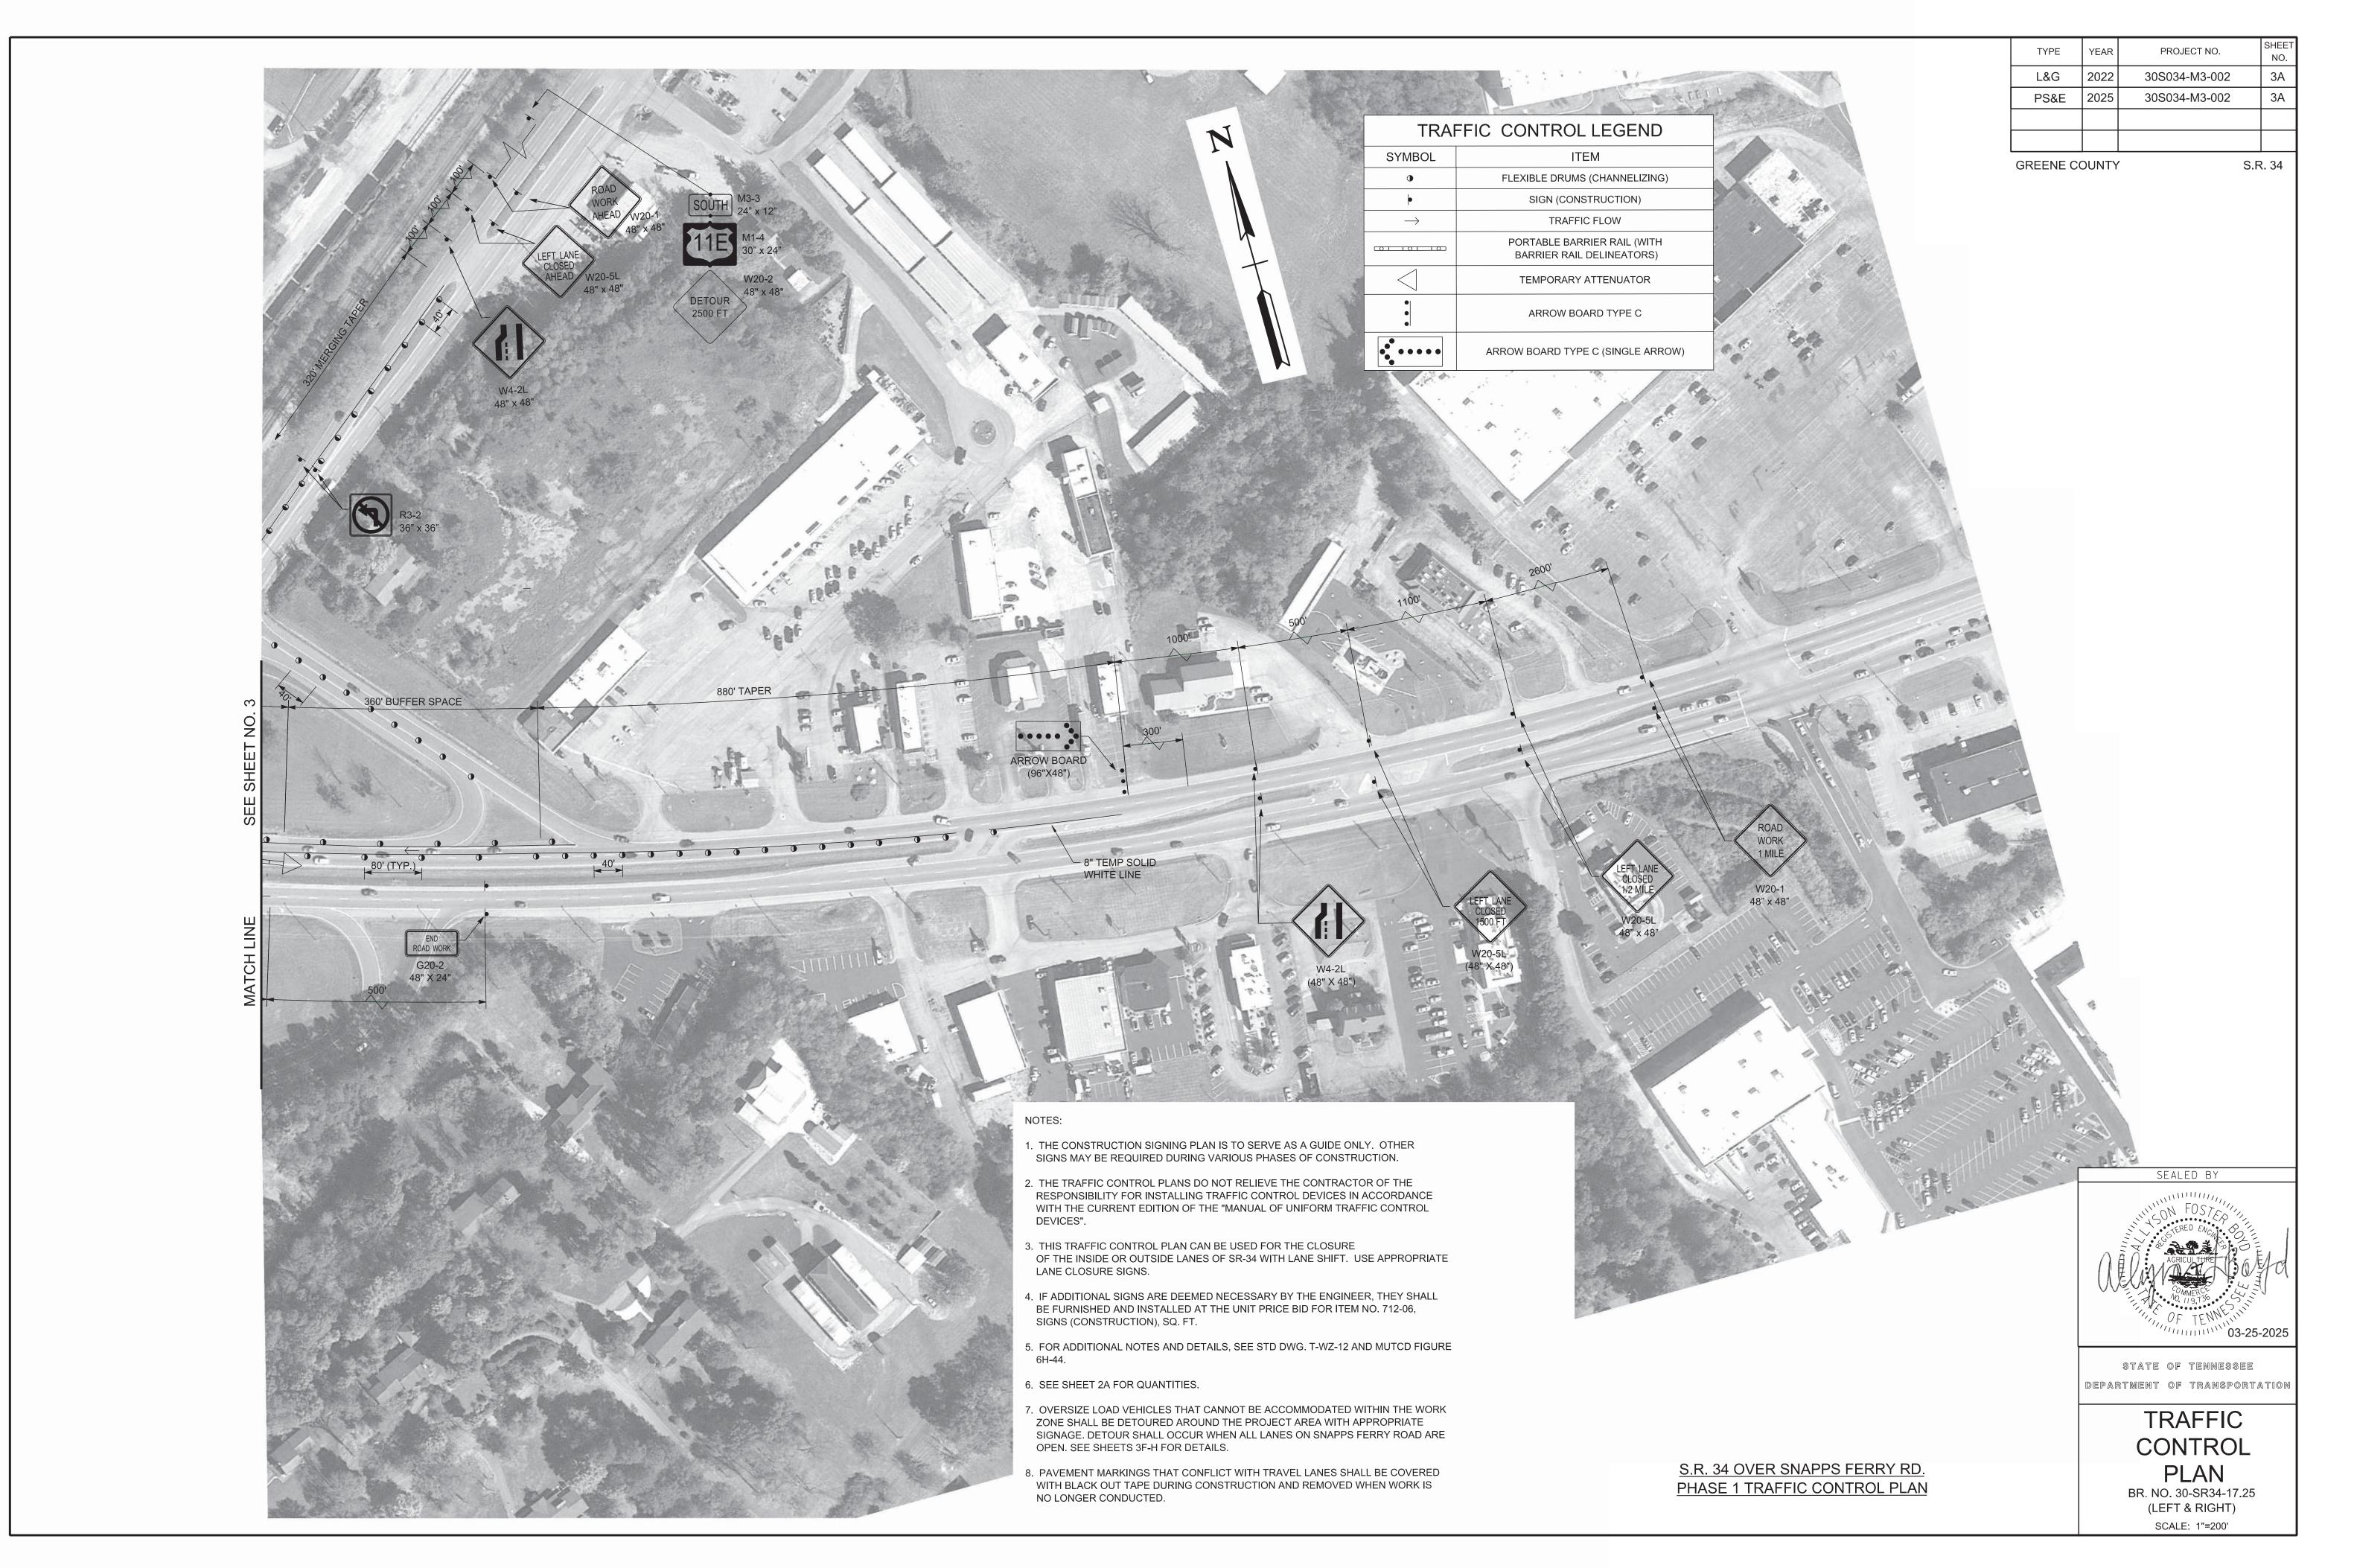

TYPE	YEAR	PROJECT NO.	SHEET NO.	
L&G	2022	30S034-M3-002	3B	
PS&E	2025	30S034-M3-002	3B	

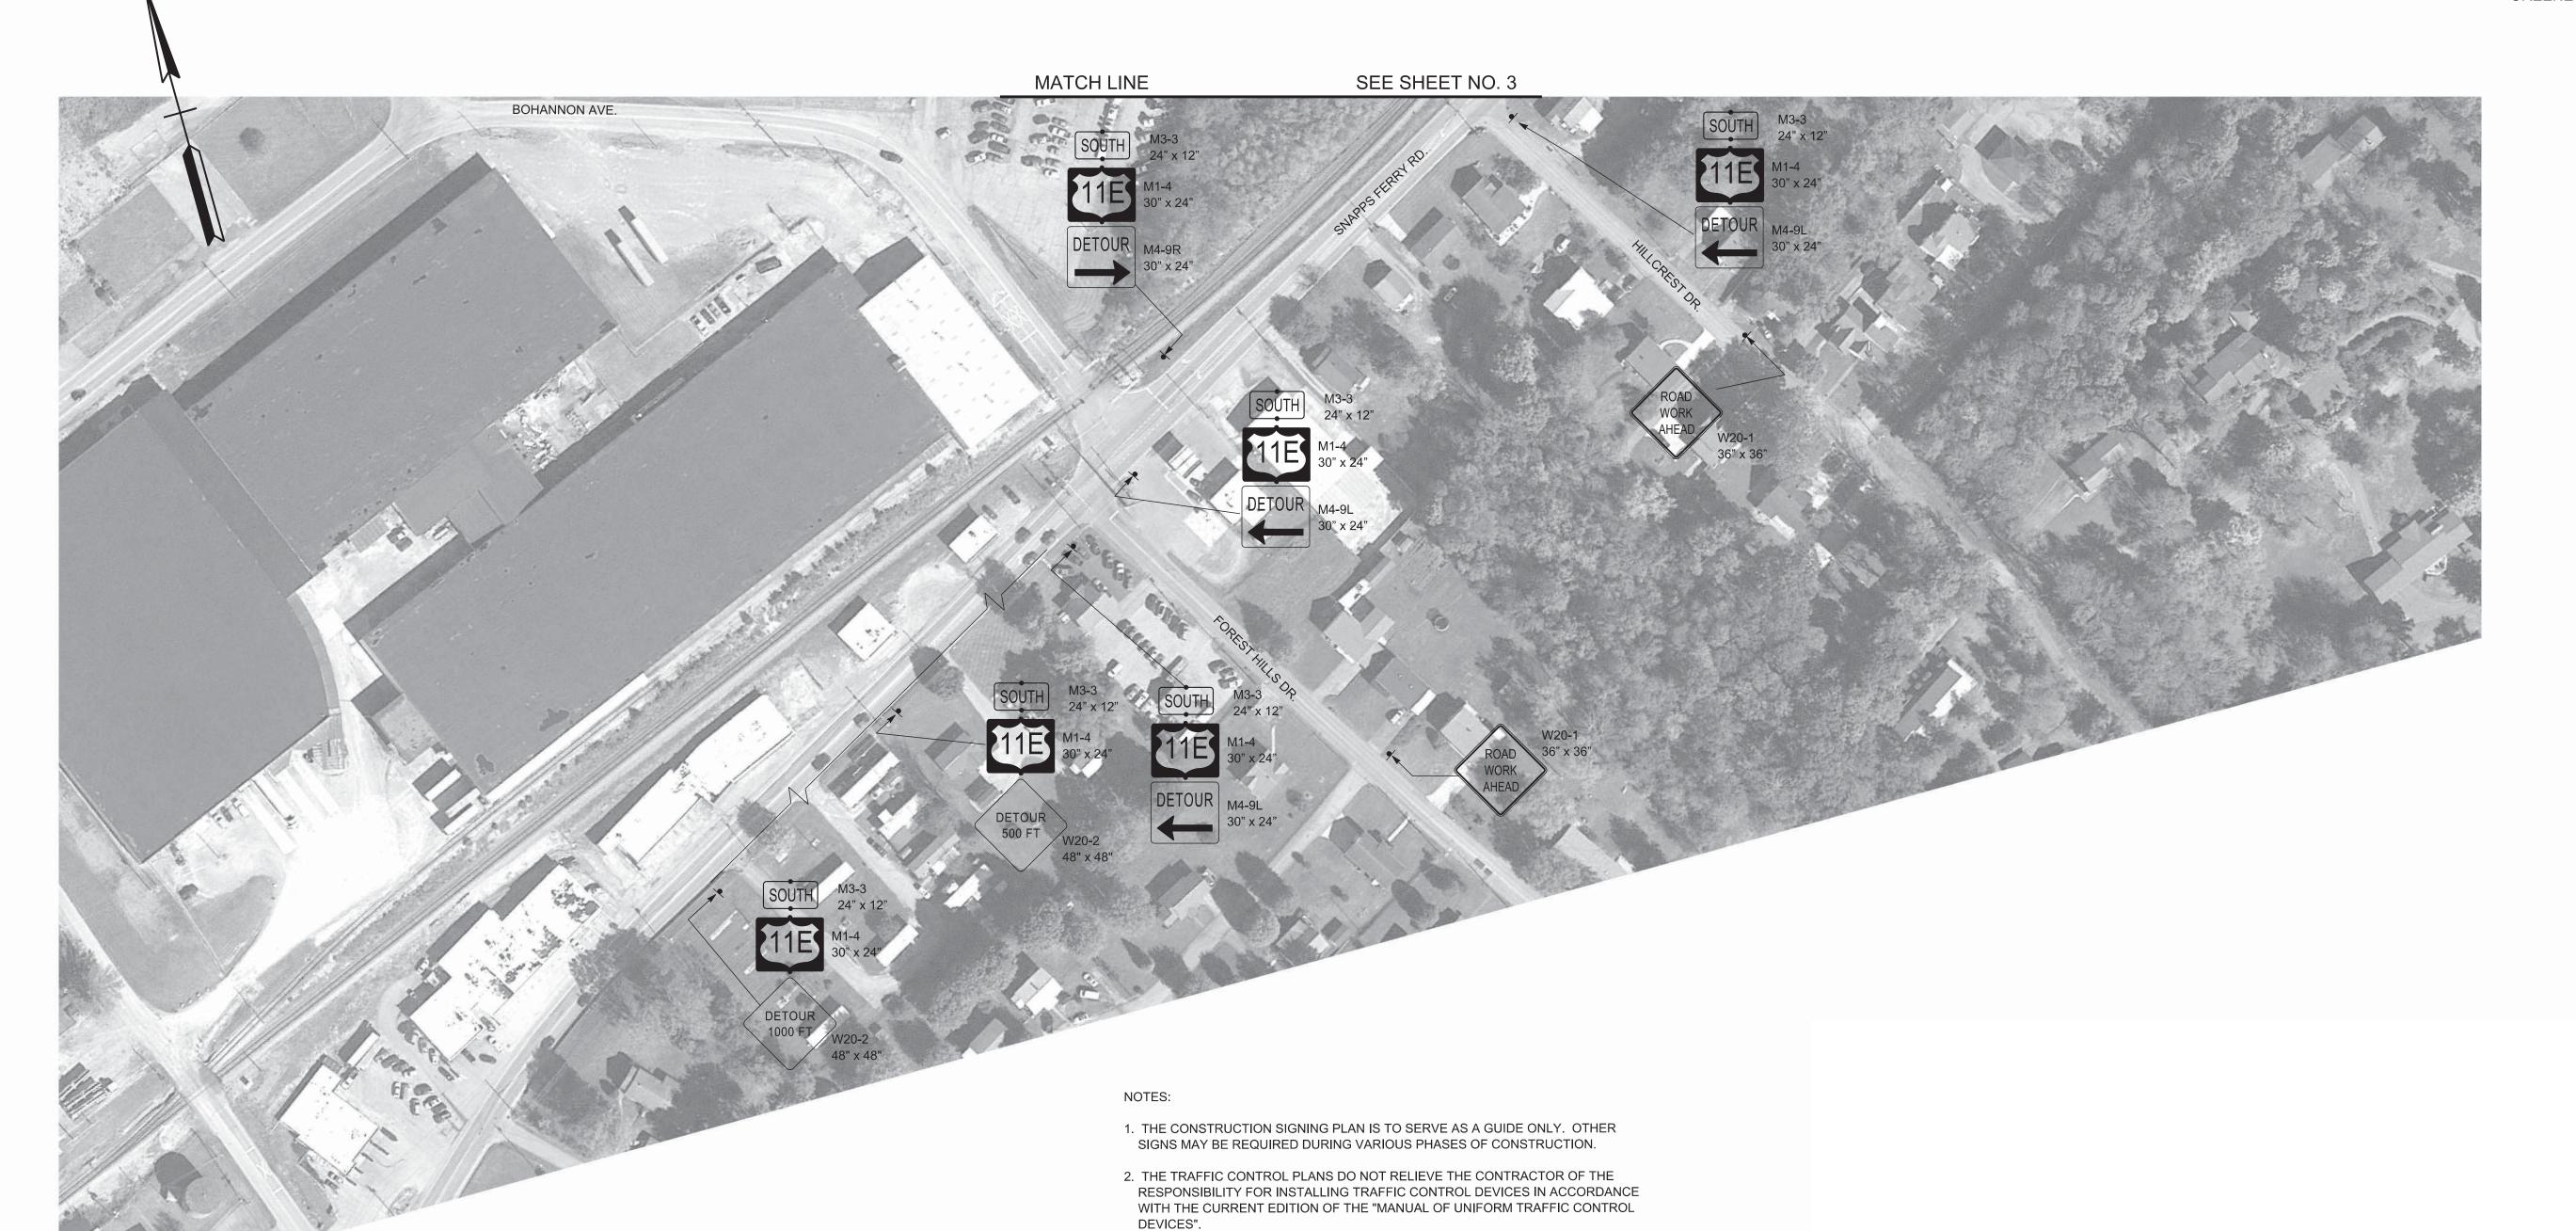

	SIGNS (CONSTRUCTION), SQ. FT.
5.	FOR ADDITIONAL NOTES AND DETAILS, SEE STD DWG. T-WZ-12 AND MUTCD FIGURE 6H-44.
6.	SEE SHEET 2A FOR QUANTITIES.

OF THE INSIDE OR OUTSIDE LANES OF SR-34 WITH LANE SHIFT. USE APPROPRIATE

4. IF ADDITIONAL SIGNS ARE DEEMED NECESSARY BY THE ENGINEER, THEY SHALL BE FURNISHED AND INSTALLED AT THE UNIT PRICE BID FOR ITEM NO. 712-06,

3. THIS TRAFFIC CONTROL PLAN CAN BE USED FOR THE CLOSURE


LANE CLOSURE SIGNS.

7. OVERSIZE LOAD VEHICLES THAT CANNOT BE ACCOMMODATED WITHIN THE WORK ZONE SHALL BE DETOURED AROUND THE PROJECT AREA WITH APPROPRIATE SIGNAGE. DETOUR SHALL OCCUR WHEN ALL LANES ON SNAPPS FERRY ROAD ARE OPEN. SEE SHEETS 3F-H FOR DETAILS.

8. PAVEMENT MARKINGS THAT CONFLICT WITH TRAVEL LANES SHALL BE COVERED WITH BLACK OUT TAPE DURING CONSTRUCTION AND REMOVED WHEN WORK IS NO LONGER CONDUCTED.

> S.R. 34 OVER SNAPPS FERRY RD. PHASE 1 TRAFFIC CONTROL PLAN


TRAFFIC CONTROL LEGEND				
SYMBOL	ITEM			
•	FLEXIBLE DRUMS (CHANNELIZING)			
 •	SIGN (CONSTRUCTION)			
\rightarrow	TRAFFIC FLOW			
	PORTABLE BARRIER RAIL (WITH BARRIER RAIL DELINEATORS)			
	TEMPORARY ATTENUATOR			
•	ARROW BOARD TYPE C			
••••••	ARROW BOARD TYPE C (SINGLE ARROW)			

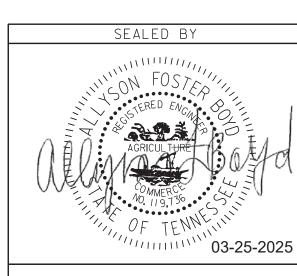

STATE OF TENNESSEE DEPARTMENT OF TRANSPORTATION

> TRAFFIC CONTROL PLAN

BR. NO. 30-SR34-17.25 (LEFT & RIGHT) SCALE: 1"=200'

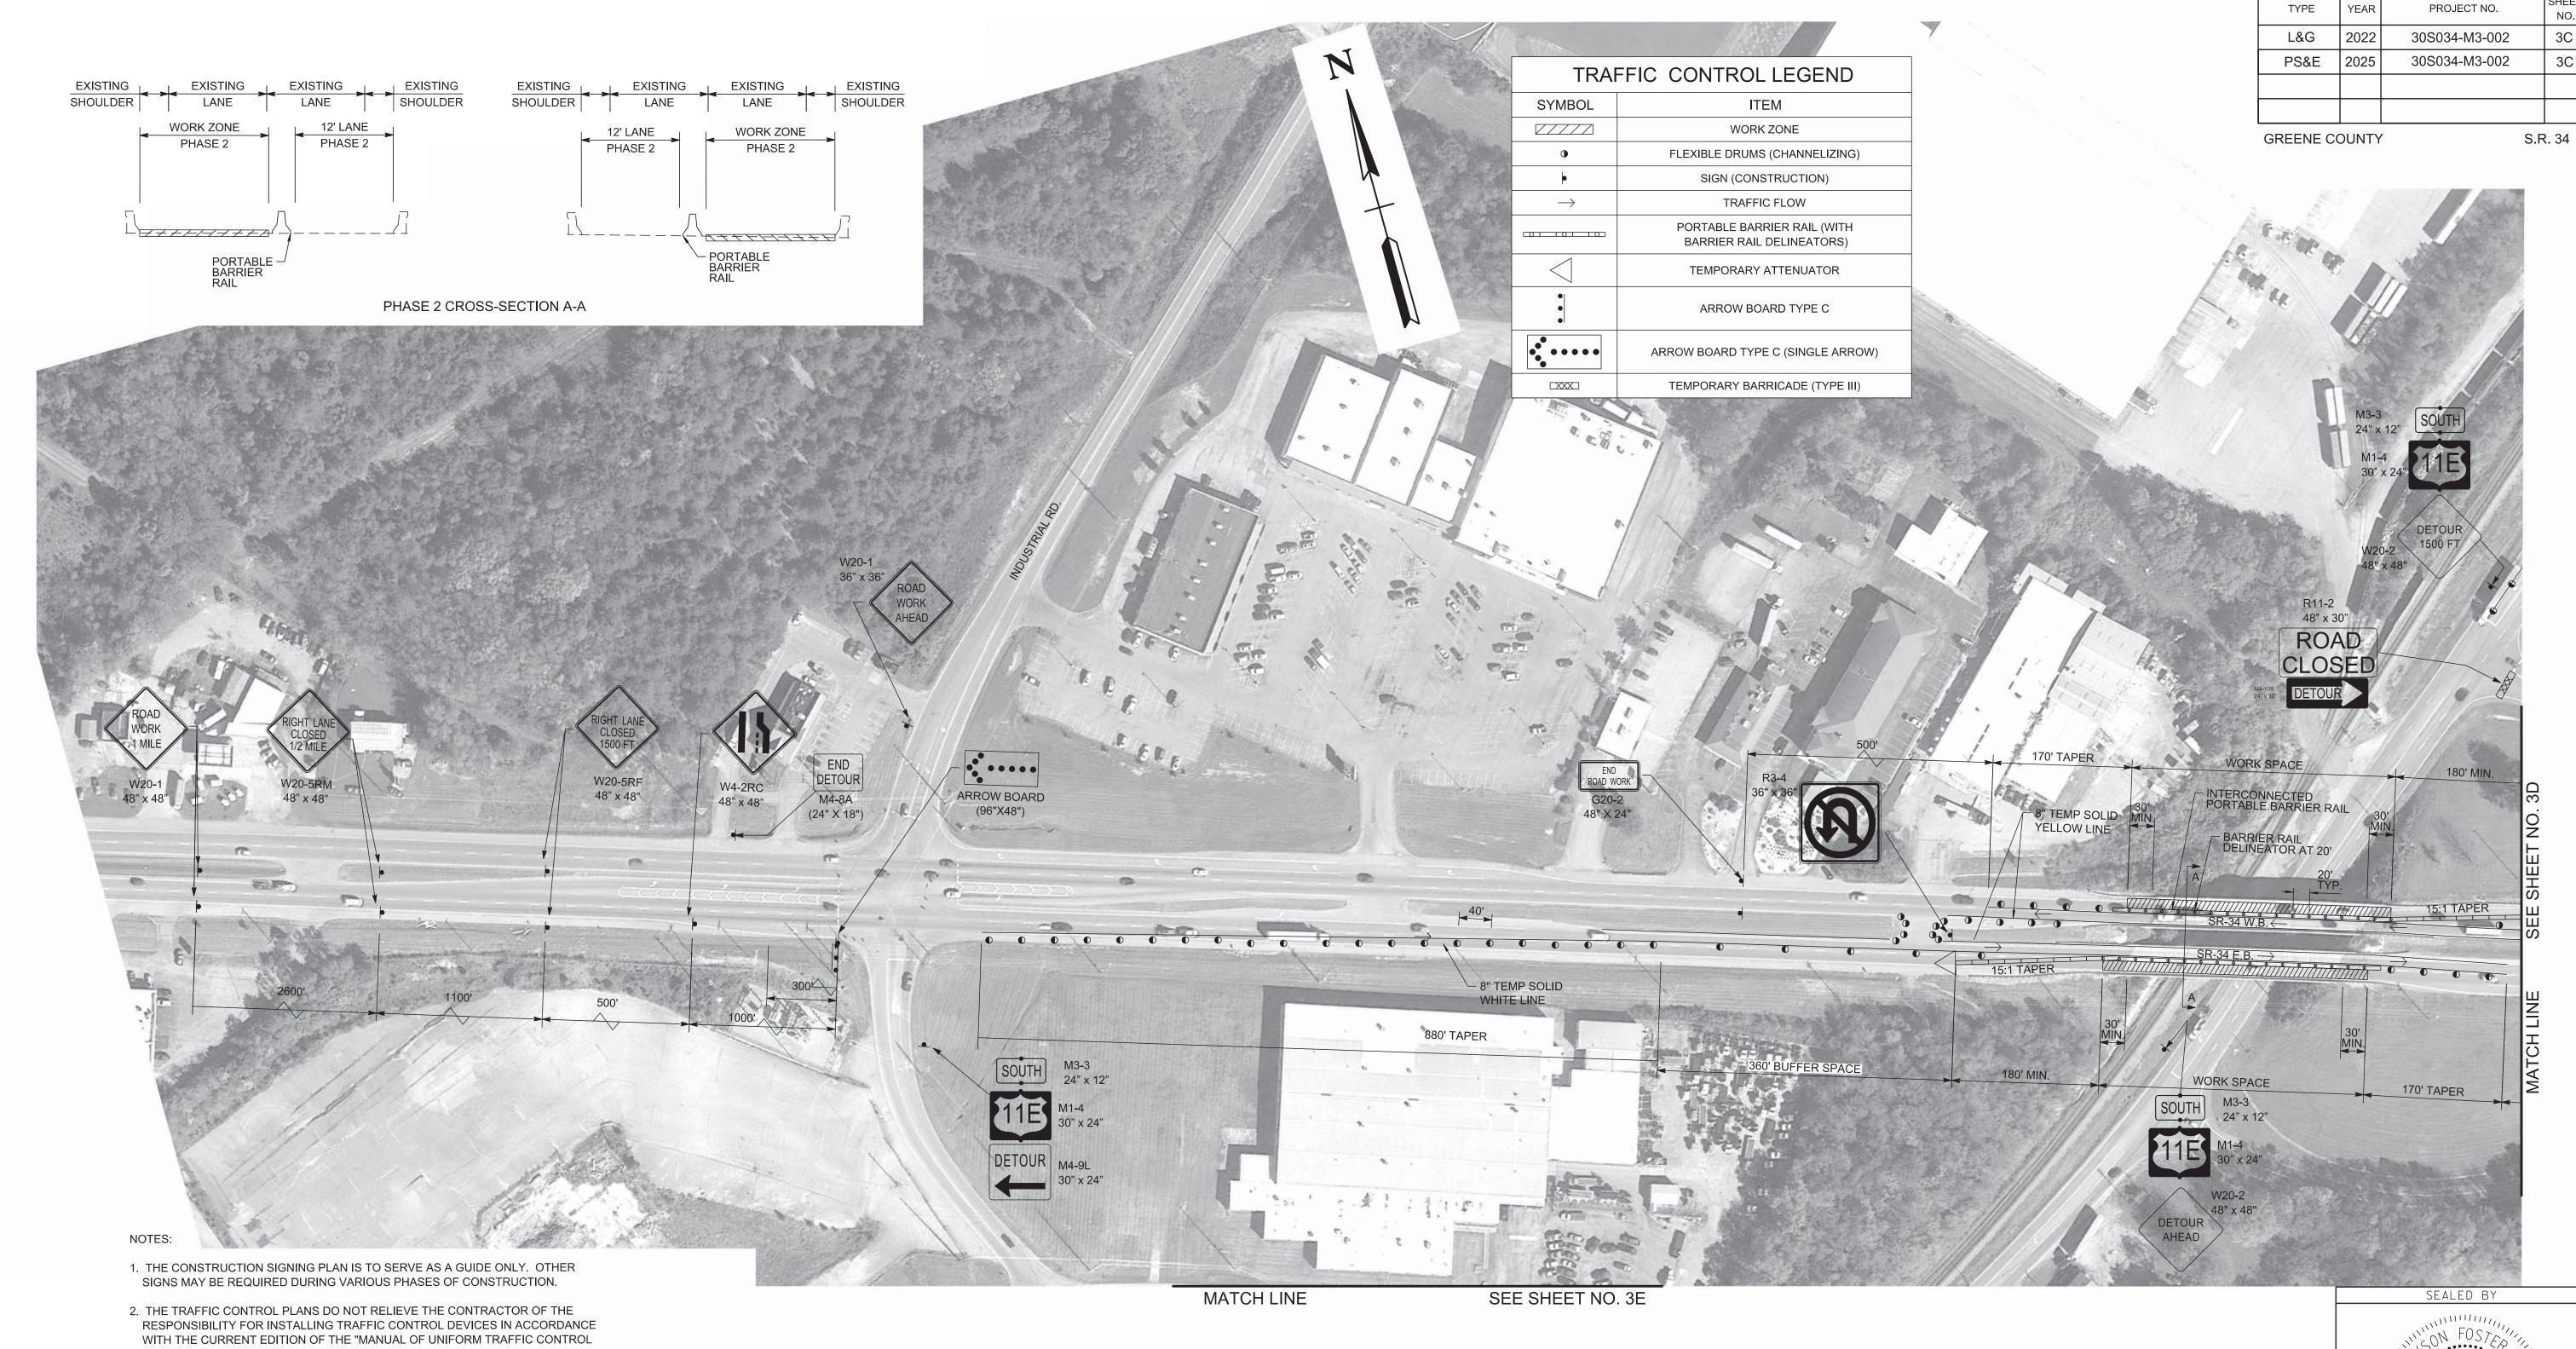

3. THIS TRAFFIC CONTROL PLAN CAN BE USED FOR THE CLOSURE OF THE INSIDE OR OUTSIDE LANES OF SR-34 WITH LANE SHIFT. USE APPROPRIATE LANE CLOSURE SIGNS.

4. IF ADDITIONAL SIGNS ARE DEEMED NECESSARY BY THE ENGINEER, THEY SHALL BE FURNISHED AND INSTALLED AT THE UNIT PRICE BID FOR ITEM NO. 712-06, SIGNS (CONSTRUCTION), SQ. FT.

5. FOR ADDITIONAL NOTES AND DETAILS, SEE STD DWG. T-WZ-12 AND MUTCD FIGURE 6H-44.

6. SEE SHEET 2A FOR QUANTITIES.

7. OVERSIZE LOAD VEHICLES THAT CANNOT BE ACCOMMODATED WITHIN THE WORK ZONE SHALL BE DETOURED AROUND THE PROJECT AREA WITH APPROPRIATE SIGNAGE. DETOUR SHALL OCCUR WHEN ALL LANES ON SNAPPS FERRY ROAD ARE OPEN. SEE SHEETS 3F-H FOR DETAILS.

8. PAVEMENT MARKINGS THAT CONFLICT WITH TRAVEL LANES SHALL BE COVERED WITH BLACK OUT TAPE DURING CONSTRUCTION AND REMOVED WHEN WORK IS NO LONGER CONDUCTED.




STATE OF TENNESSEE DEPARTMENT OF TRANSPORTATION

> TRAFFIC CONTROL PLAN

BR. NO. 30-SR34-17.25 (LEFT & RIGHT) SCALE: 1"=200'


S.R. 34 OVER SNAPPS FERRY RD. PHASE 2 TRAFFIC CONTROL PLAN

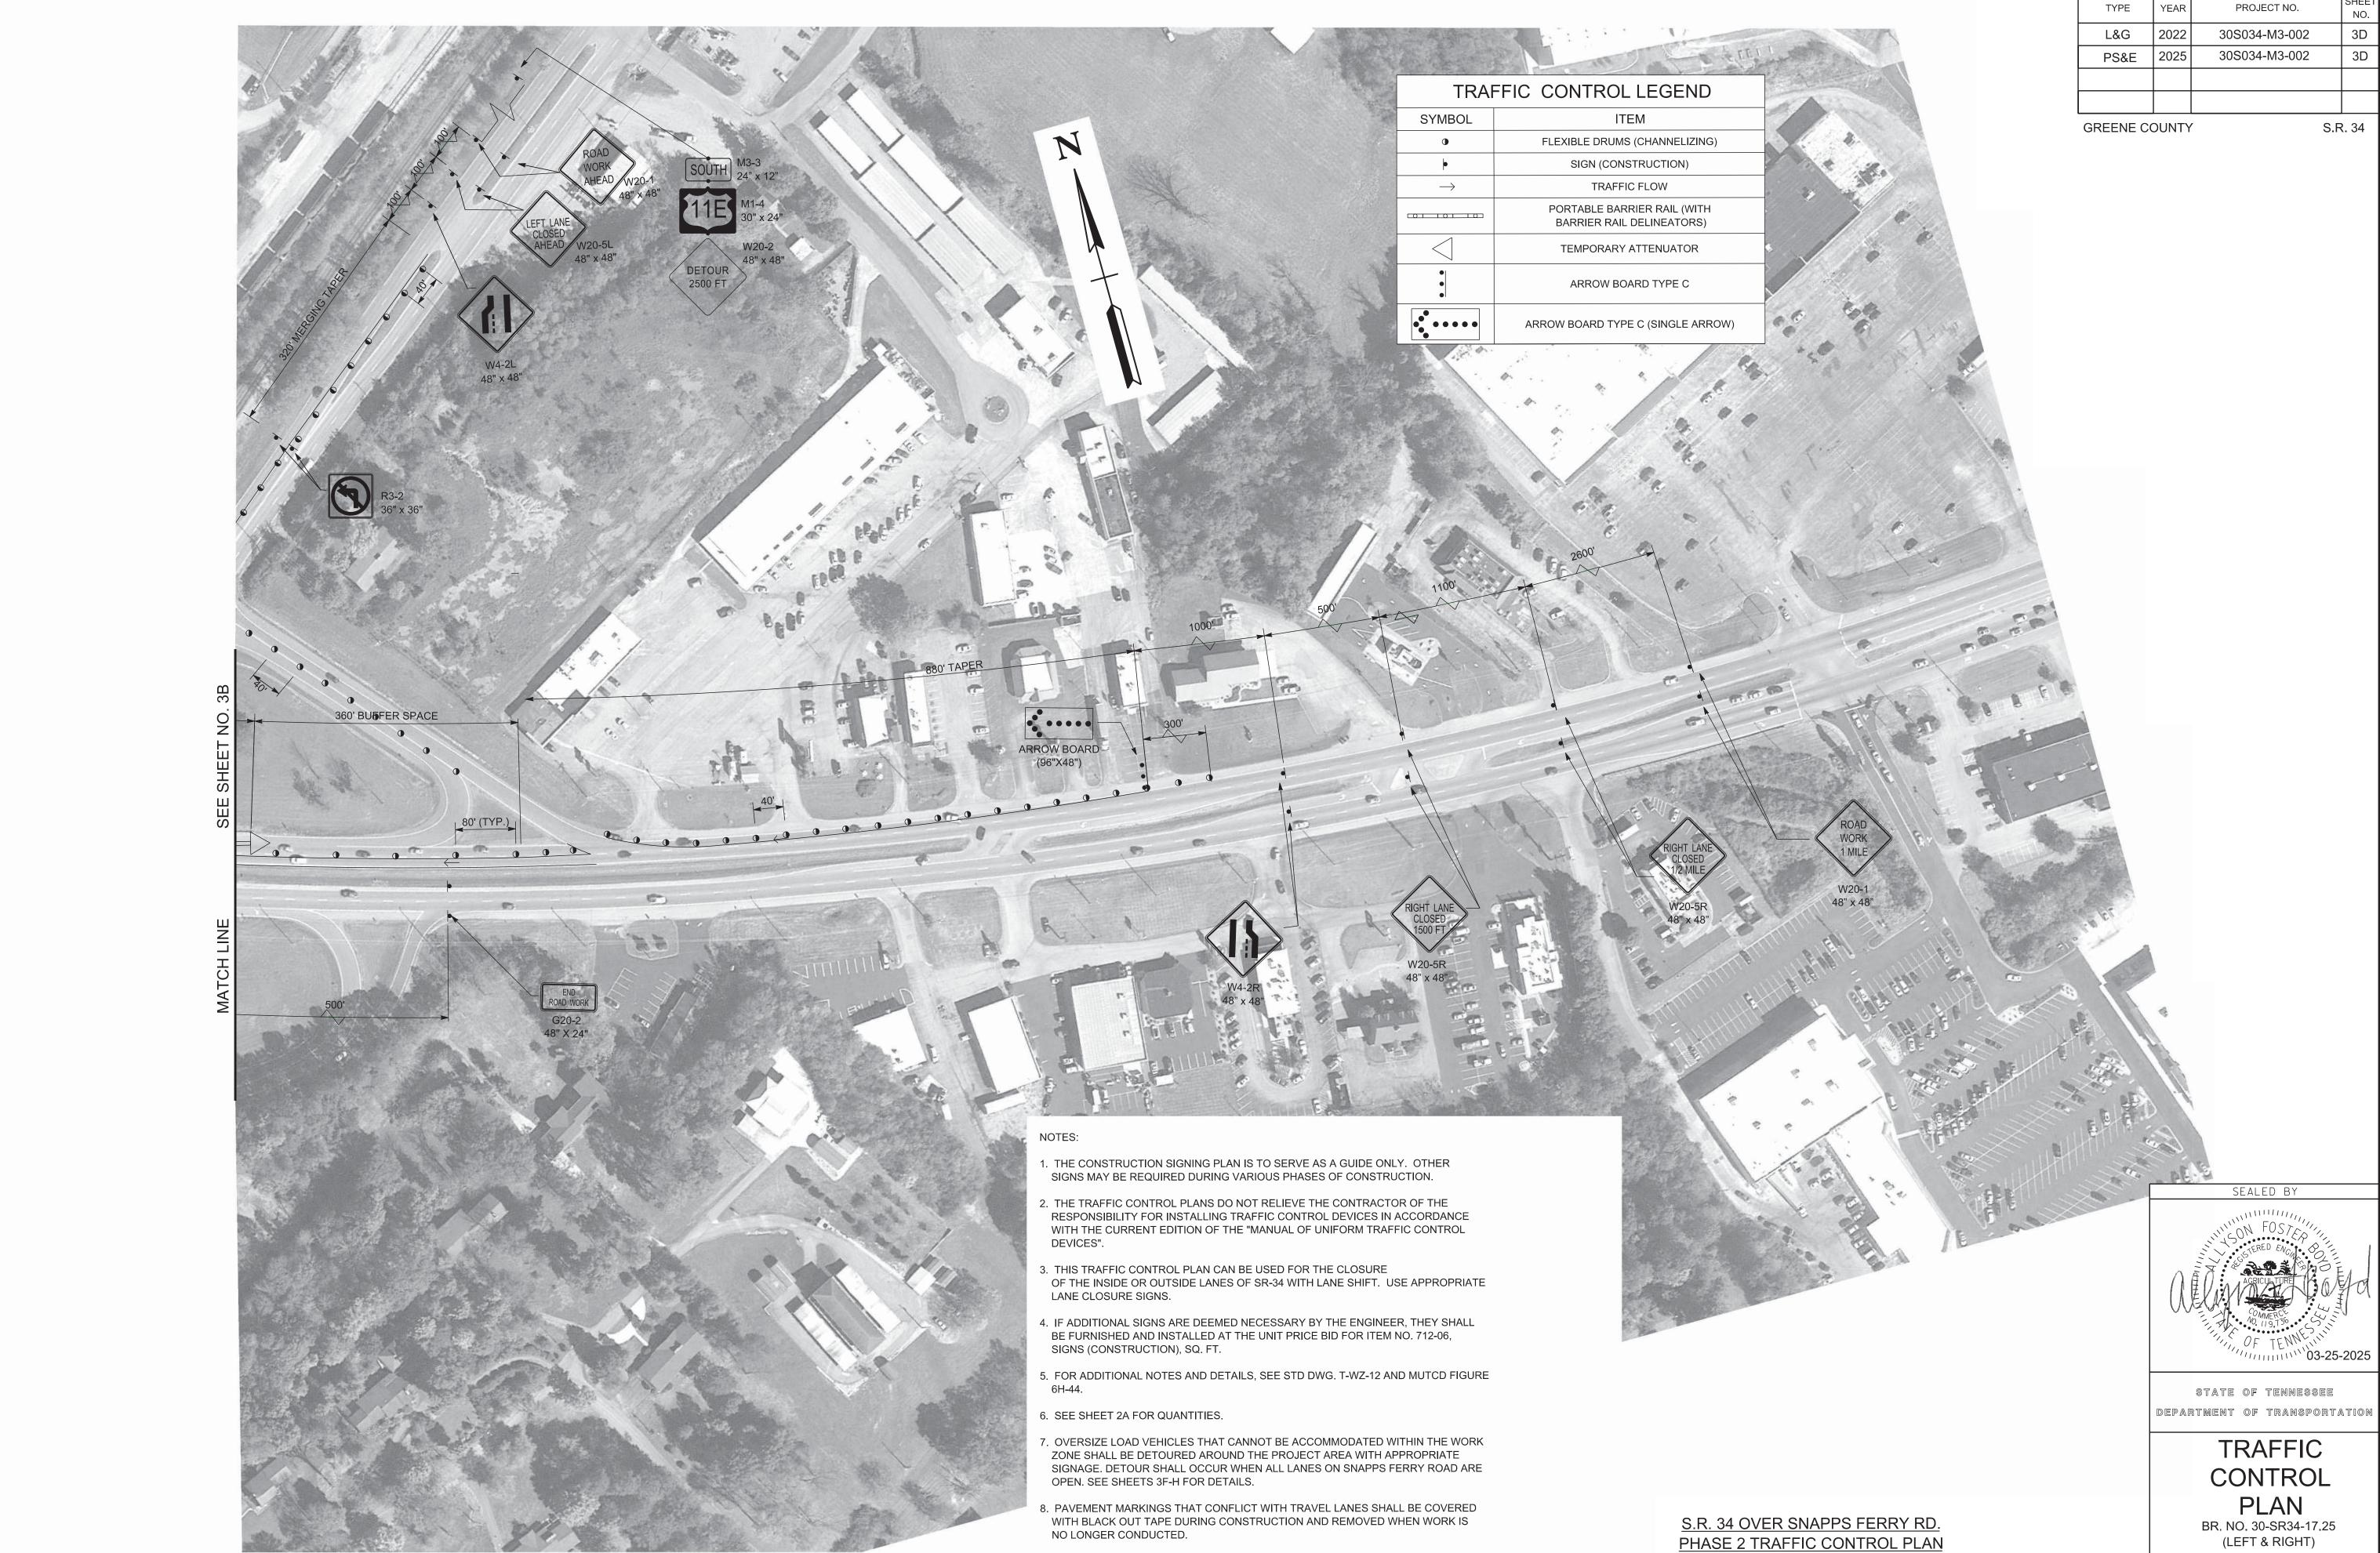

(LEFT & RIGHT) SCALE: 1"=200'

TYPE	YEAR	PROJECT NO.	SHEET NO.
L&G	2022	30S034-M3-002	3E
PS&E	2025	30S034-M3-002	3E

S.R. 34

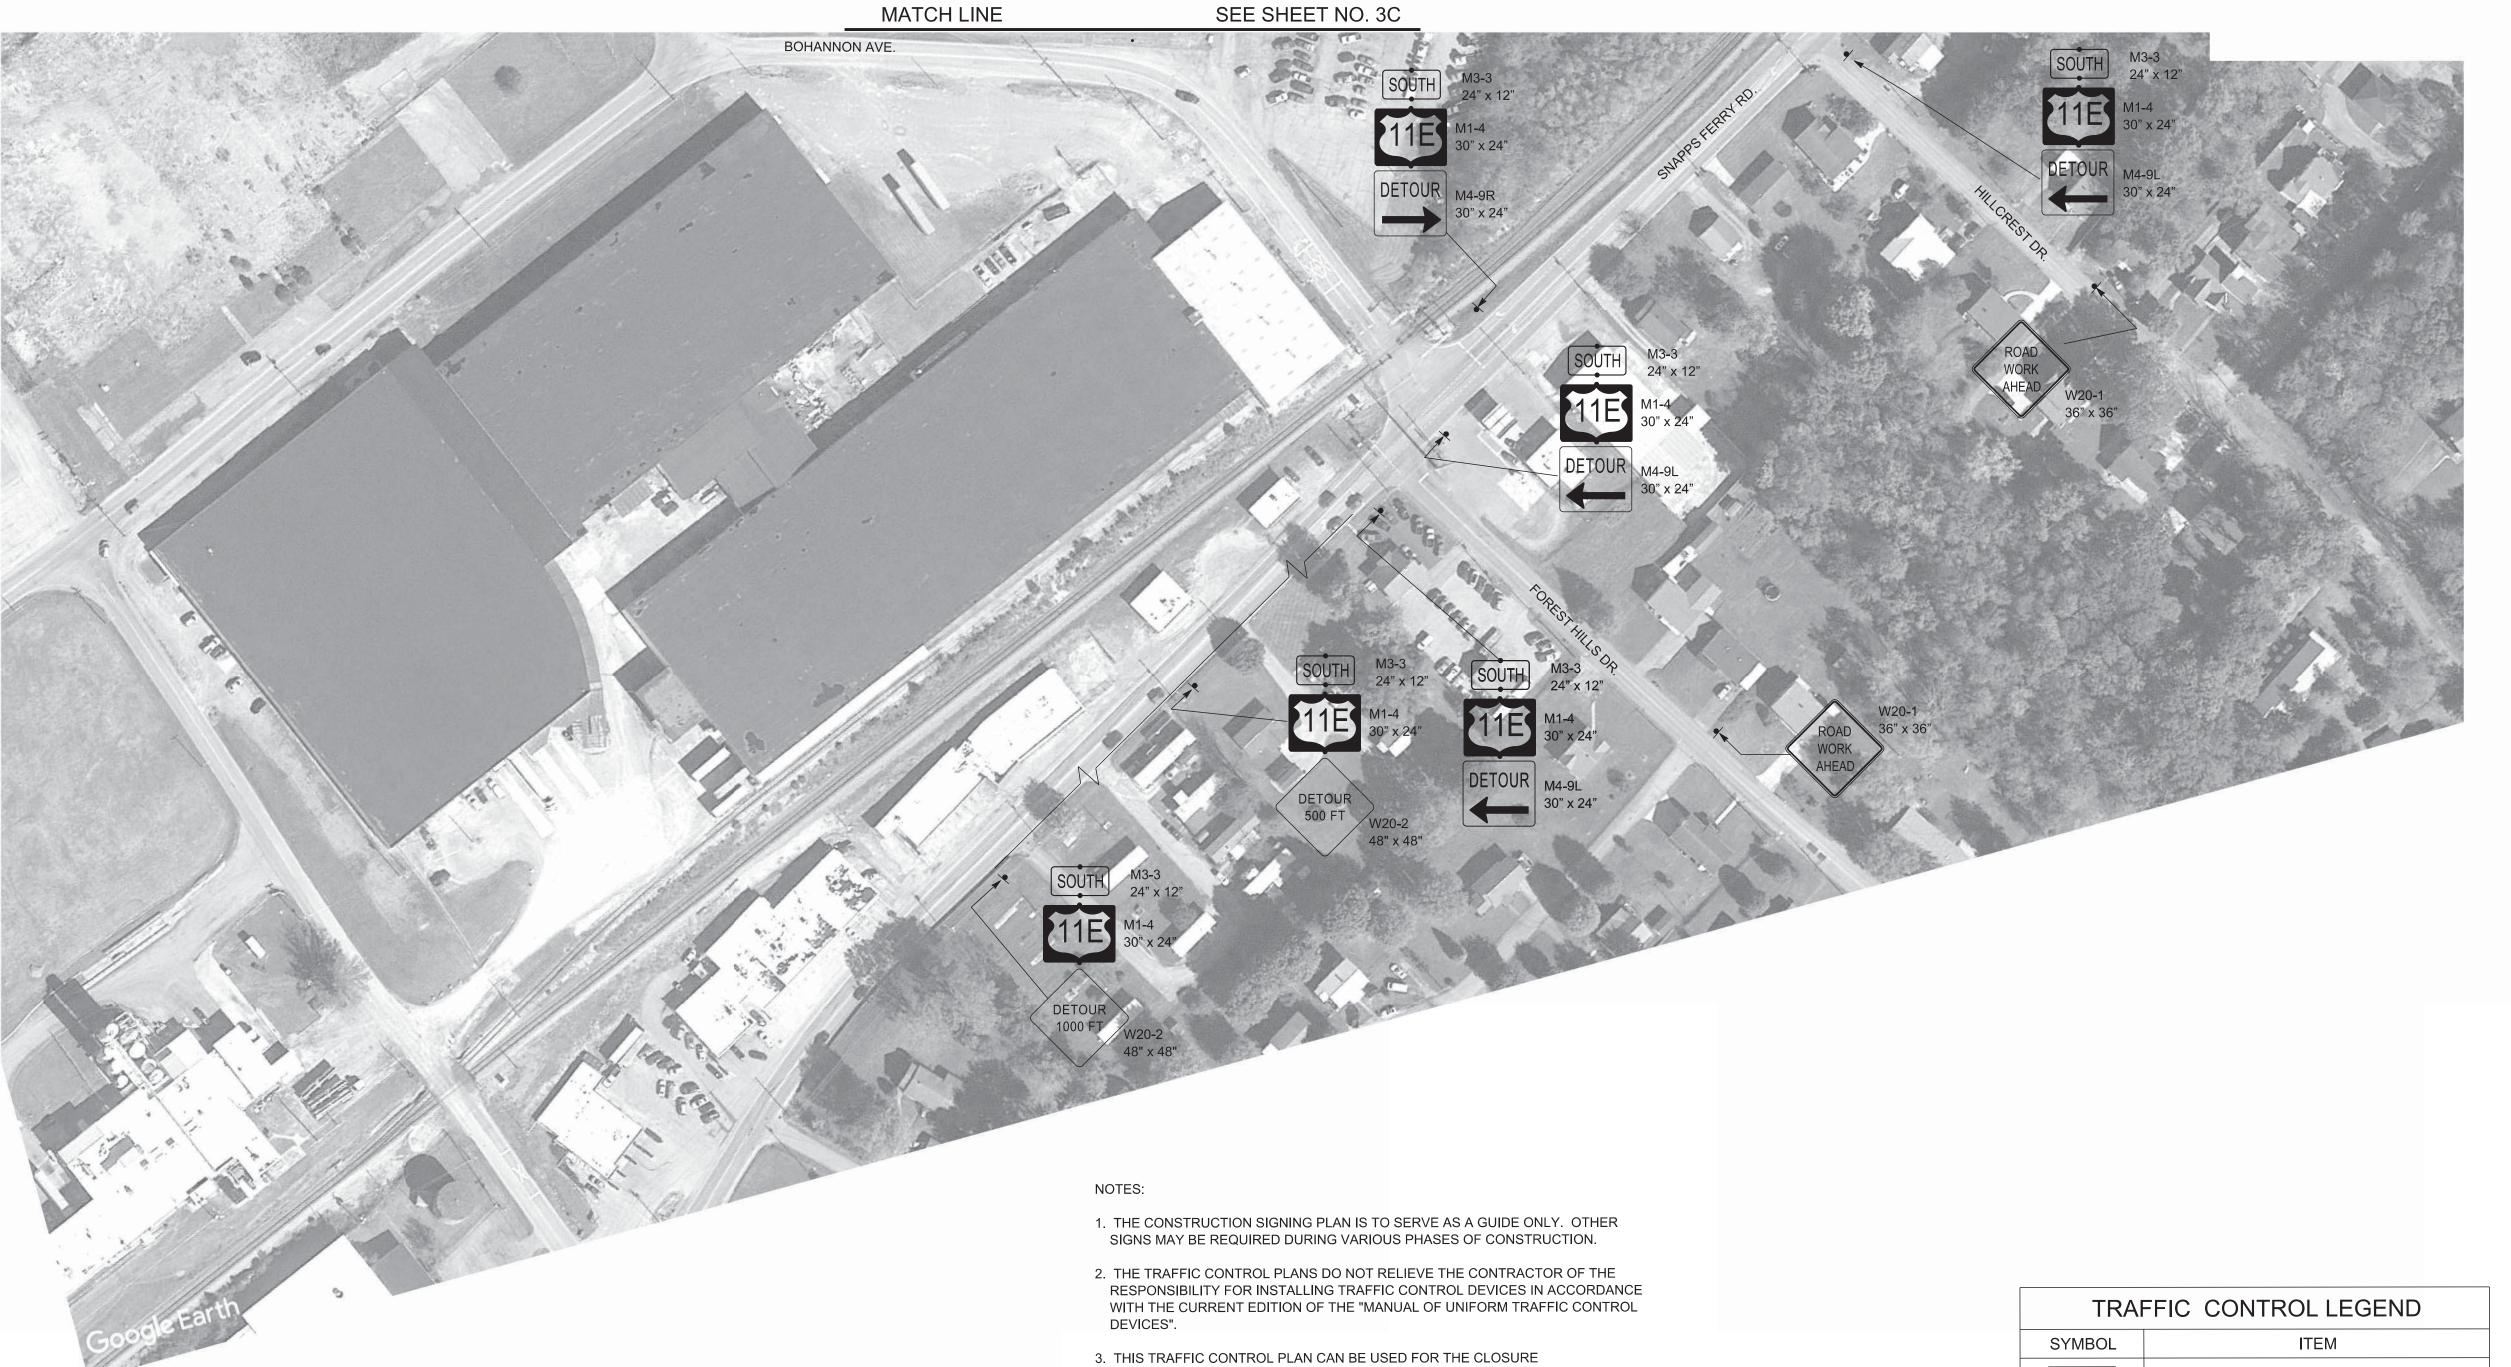

OF THE INSIDE OR OUTSIDE LANES OF SR-34 WITH LANE SHIFT. USE APPROPRIATE

4. IF ADDITIONAL SIGNS ARE DEEMED NECESSARY BY THE ENGINEER, THEY SHALL BE FURNISHED AND INSTALLED AT THE UNIT PRICE BID FOR ITEM NO. 712-06,

7. OVERSIZE LOAD VEHICLES THAT CANNOT BE ACCOMMODATED WITHIN THE WORK

ZONE SHALL BE DETOURED AROUND THE PROJECT AREA WITH APPROPRIATE SIGNAGE. DETOUR SHALL OCCUR WHEN ALL LANES ON SNAPPS FERRY ROAD ARE

8. PAVEMENT MARKINGS THAT CONFLICT WITH TRAVEL LANES SHALL BE COVERED

WITH BLACK OUT TAPE DURING CONSTRUCTION AND REMOVED WHEN WORK IS

5. FOR ADDITIONAL NOTES AND DETAILS, SEE STD DWG. T-WZ-12 AND MUTCD

LANE CLOSURE SIGNS.

FIGURE 6H-44.

SIGNS (CONSTRUCTION), SQ. FT.

6. SEE SHEET 2A FOR QUANTITIES.

NO LONGER CONDUCTED.

OPEN. SEE SHEETS 3F-H FOR DETAILS.

TRAFFIC CONTROL LEGEND				
SYMBOL	ITEM			
	WORK ZONE			
•	FLEXIBLE DRUMS (CHANNELIZING)			
þ	SIGN (CONSTRUCTION)			
\rightarrow	TRAFFIC FLOW			
	PORTABLE BARRIER RAIL (WITH BARRIER RAIL DELINEATORS)			
	TEMPORARY ATTENUATOR			
•	ARROW BOARD TYPE C			
	ARROW BOARD TYPE C (SINGLE ARROW)			



STATE OF TENNESSEE DEPARTMENT OF TRANSPORTATION


> TRAFFIC CONTROL PLAN

BR. NO. 30-SR34-17.25 (LEFT & RIGHT) SCALE: 1"=200'

S.R. 34 OVER SNAPPS FERRY RD. PHASE 2 TRAFFIC CONTROL PLAN

TYPE	YEAR	PROJECT NO.	SHEET NO.
L&G 2022		30S034-M3-002	3F
PS&E	2025	30S034-M3-002	3F

S.R. 34

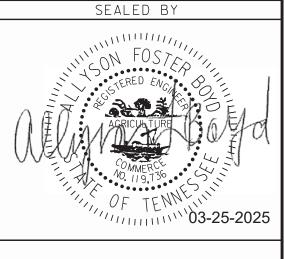

STATE OF TENNESSEE


DEPARTMENT OF TRANSPORTATION

TRAFFIC CONTROL PLAN

SNAPPS FERRY ROAD

SCALE: 1"=100'

DUNTY S.R. 34

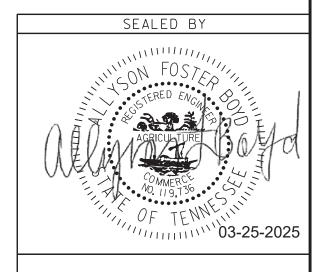

STATE OF TENNESSEE

DEPARTMENT OF TRANSPORTATION

TRAFFIC CONTROL PLAN

SNAPPS FERRY ROAD

SCALE: 1"=100'

TYPE	YEAR	PROJECT NO.	SHEET NO.
L&G	2022	30S034-M3-002	3H
PS&E	2025	30S034-M3-002	3H

M1-4.3

M4-8a

30" x 15"

S.R. 34

1 MILE W16-3aP 30" x 12"

DETOUR

M3-3

24" x 12"

CUSTOM

36" x 18"

30" x 15"

M4-8

30" x 21"

SOUTH

WIDE LOAD

DETOUR NETWORK NOTES

1 MILE

1 MILE

NEXT


RIGHT

1. CONTRACTOR TO INSTALL DETOUR SIGNS ALONG CITY STREETS PENDING COORDINATION AND APPROVAL FROM THE TOWN OF GREENEVILLE CITY MANAGER, TODD SMITH (TSMITH@GREENEVILLETN.GOV, 423.639.7105 (WORK), 423-787-6184 (MOBILE)).

NEXT

LEFT

- 2. WIDE LOAD DETOUR TO OCCUR DURING LANE CLOSURES ON SR-34 AND WHEN ALL TRAVEL LANES ON SNAPPS FERRY ROAD ARE OPEN. SEE BRIDGE SHEETS BR-01 & 03 AND TRAFFIC CONTROL PLANS FOR PHASING AND LANE RESTRICTIONS.
- 3. ADVANCE WARNING SIGNS TO BE PLACED PRIOR TO CONSTRUCTION AND TO REMAIN IN PLACE UNTIL THE COMPLETION OF THIS PROJECT. ADVANCED WARNING SIGNS SHALL NOT BE DISPLAYED MORE THAN FORTY-EIGHT (48) HOURS BEFORE PHYSICAL CONSTRUCTION BEGINS. SIGNS MAY BE ERECTED UP TO ONE WEEK BEFORE NEEDED, IF THE SIGN FACE IS FULLY COVERED.
- 4. MESSAGE BOARDS IN ADVANCE OF THE DETOUR AREA MAY BE OPERATIONAL PRIOR TO LANE CLOSURE TO INFORM PUBLIC OF DATES OF LANE CLOSURES.
- 5. THE TRAFFIC CONTROL PLAN DOES NOT RELIEVE THE CONTRACTOR OF THE RESPONSIBILITY OF INSTALLING TRAFFIC CONTROL DEVICES IN ACCORDANCE WITH THE CURRENT EDITION OF THE MANUAL ON UNIFORM TRAFFIC CONTROL DEVICES.
- 6. THE LOCATION OF ALL TRAFFIC CONTROL DEVICES ARE TO BE APPROVED BY THE ENGINEER PRIOR TO INSTALLATION. TRAFFIC CONTROL DEVICES SHALL NOT BE DISPLAYED OR ERECTED UNLESS RELATED CONDITIONS ARE PRESENT NECESSITATING WARNING. CONTRACTOR TO INSTALL WIDE LOAD DETOUR SIGNS AND MESSAGE BOARDS IN TENNESSEE PENDING COORDINATION AND APPROVAL FROM TDOT.
- 7. IF THE CONTRACTOR MOVES OFF THE PROJECT, THEY SHALL COVER OR REMOVE ALL UN-NEEDED SIGNS AS DIRECTED BY THE ENGINEER. COSTS OF REMOVAL, COVERING, AND REINSTALLING SIGNS SHALL NOT BE MEASURED AND PAID FOR DIRECTLY, BUT ALL COSTS SHALL BE INCLUDED IN THE ORIGINAL UNIT PRICE BID FOR ITEM NO. 712-06, SIGNS (CONSTRUCTION) PER SQUARE FOOT.
- 8. SPECIAL DETOUR SIGNING SHALL BE BLACK COPY ON ORANGE BACKGROUND EXCEPT THAT CARDINAL DIRECTIONS AND INTERSTATE SHIELDS SHALL BE STANDARD INTERSTATE SIGNS.

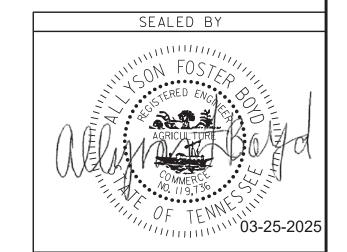

STATE OF TENNESSEE DEPARTMENT OF TRANSPORTATION

TRAFFIC
CONTROL
PLAN
WIDE LOAD DETOUR
NOT TO SCALE

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c:/pw

140


SYMBOL ITEM

WORK ZONE

SIGN (CONSTRUCTION) (2-POST)

TRAFFIC CONTROL LEGEND

CHANGEABLE MESSAGE SIGN

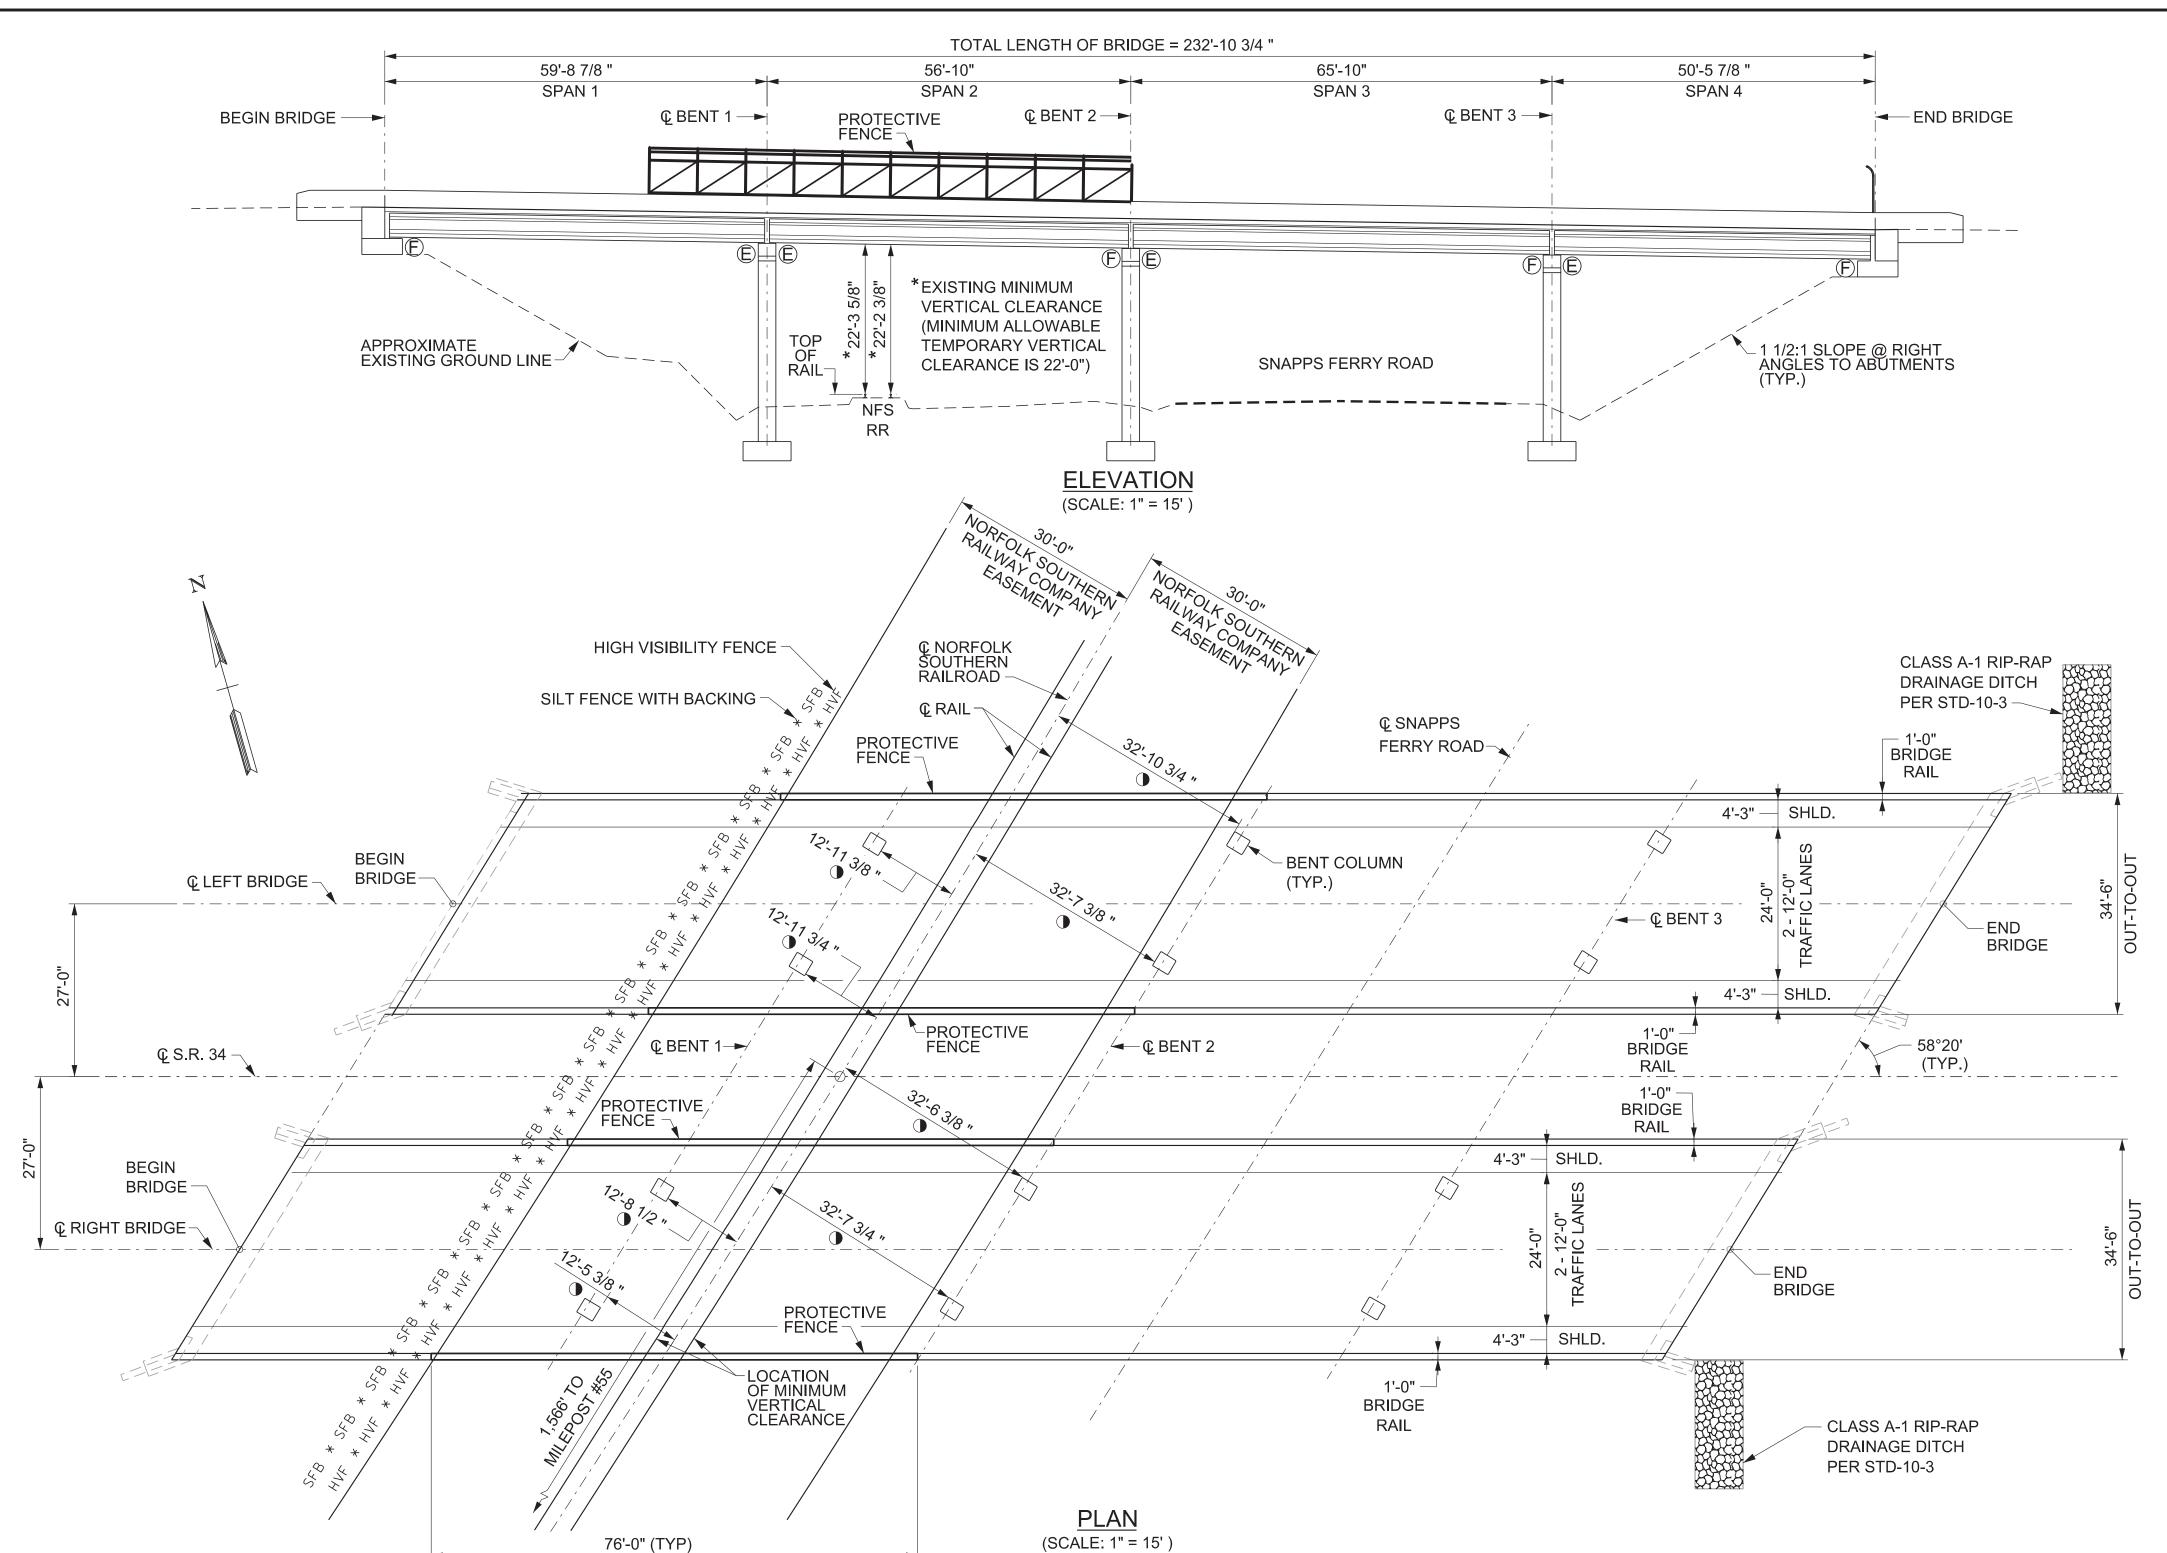

PROJECT NO. YEAR SHEET NO. 30S034-M3-002 2025 REVISIONS NO. DATE BRIEF DESCRIPTION (E) - DENOTES EXPANSION

(F) - DENOTES FIXED

LIST OF BRIDGE DRAWINGS

<u>DRAWING</u>	<u>DRAWING</u> <u>NO.</u>	LATEST REV. DATE
LAYOUT OF BRIDGES TO BE REPAIRED	_ BR-131-902	
GENERAL NOTES AND ESTIMATED BRIDGE QUANTITIES _	_ BR-131-903	
PHASE CONSTRUCTION	_ BR-131-904	
SUPERSTRUCTURE REPAIRS	_ BR-131-905	
ABUTMENT REPAIRS LEFT BRIDGE	_ BR-131-906	
ABUTMENT REPAIRS RIGHT BRIDGE	_ BR-131-907	
BENT REPAIRS BENT 1 - LEFT BRIDGE	_ BR-131-908	
BENT REPAIRS BENT 2 - LEFT BRIDGE	_ BR-131-909	
BENT REPAIRS BENT 3 - LEFT BRIDGE	_ BR-131-910	
BENT REPAIRS BENT 1 - RIGHT BRIDGE	_ BR-131-911	
BENT REPAIRS BENT 2 - RIGHT BRIDGE	_ BR-131-912	
BENT REPAIRS BENT 3 - RIGHT BRIDGE	_ BR-131-913	
REPAIR DETAILS	_ BR-131-914	
CONCRETE REPAIR DETAILS	_ BR-131-915	

LIST OF BRIDGE REFERENCE DRAWINGS

(TO BE PRINTED WITH PLANS) BR-16-74, BR-16-76 THRU BR-16-81, K-27-108 THRU K-27-112 AND K-15-65

STANDARD BRIDGE DRAWINGS


DRAWING <u>LATEST</u>

ROAD

REV. DATE <u>DRAWING</u>

STD-8-5 STANDARD PROTECTIVE FENCE DETAILS STD-10-3 STANDARD FLUME DETAILS 01/10/2024

TRAFFIC DATA			
S.R. 34	POSTED SPEED LIMIT = 45 M.P.H. ADT (2025) = 30,630		
SNAPPS FERRY	POSTED SPEED LIMIT = 40 M.P.H.		

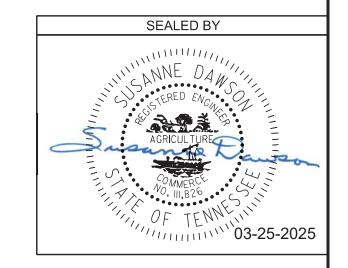

STATE OF TENNESSEE DEPARTMENT OF TRANSPORTATION LAYOUT OF BRIDGES TO BE REPAIRED

ADT (2025) = 6,359

BRIDGE NO. 30-SR34-17.25 (L & R) FEDERAL BRIDGE ID NOS. 30FA0343003 & 30FA0343004 BRIDGES OVER SNAPPS FERRY RD. & NFS RAILWAY, LM 17.25 **GREENE COUNTY**

2025

BR-131-902

LOCATION OF MINIMUM HORIZONTAL CLEARANCE (MINIMUM ALLOWABLE TEMPORARY HORIZONTAL CLEARANCE IS 14'-0")

EXISTING SUBSTANDARD CLEARANCES SHALL NOT BE FURTHER REDUCED FOR THE TEMPORARY CONSTRUCTION CONDITION WITHOUT WRITTEN PERMISSION FROM NS.

PIN NO.: 082699.01 **DESIGN BY:** SUSANNE DAWSON DATE: AUGUST 2021 DATE: AUGUST 2021 DRAWN BY: DONNIE PICKEL SUPERVISED BY: SUSANNE DAWSON DATE: AUGUST 2021 CHECKED BY: FRANK BALE DATE: AUGUST 2021

- 1. PROVIDE REQUIRED TRAFFIC CONTROL AND PHASE CONSTRUCTION MAINTAINING ONE 12 FOOT LANE OF TRAFFIC IN EACH DIRECTION ALONG SR 34 AT ALL TIMES.
- 2. SHOTBLAST BRIDGE DECKS TO REMOVE ANY OIL, DIRT, RUBBER, TRAFFIC STRIPPING, OR ANY OTHER DETRIMENTAL MATERIAL.
- 3. RECONSTRUCT THE CONCRETE BRIDGE DECKS IN AREAS OF FULL AND PARTIAL DEPTH DECK REPAIRUTILIZING 18 HOUR HIGH EARLY STRENGTH CONCRETE.
- 4. SEAL REMAINING CRACKS ON CONCRETE BRIDGE DECKS WITH HMWM. COST TO BE INCLUDED IN TYPE 1 THIN EPOXY OVERLAY.
- 5. REMOVE THE EXISTING JOINT SEAL SYSTEM AT BENT 1, LEFT AND RIGHT LANES AND REPLACE WITH A COMPRESSION JOINT SEAL SYSTEM.
- 6. PLACE TYPE 1 THIN EPOXY OVERLAY SYSTEM OVER ENTIRE DECKS.
- 7. PLACE DELINEATORS ON TOP OF PARAPETS WITHIN LIMITS OF BRIDGE (COST TO BE INCLUDED IN ITEMS BID ON).
- 8. INSTALL PROTECTIVE FENCING ON PARAPETS OVER RAILROAD.

SCOPE OF WORK

9. CONSTRUCT RIP-RAP DRAINAGE DITCH IN ACCORDANCE WITH STD-10-3 AT END OF BRIDGES ON RIGHT SIDE, RIGHT LANE AND LEFT SIDE, LEFT LANE.

- 10. CLEAN AND MAINTAIN END OF BRIDGE DRAINS (COST TO BE INCLUDED IN ITEMS BID ON).
- 11. REPAIR DETERIORATED AREAS OF CONCRETE ON PRESTRESSED PRECAST CONCRETE GIRDERS, AND SUBSTRUCTURE UNITS.
- 12. EPOXY INJECT CRACKS ON PRESTRESSED PRECAST CONCRETE GIRDERS, SUBSTRUCTURE UNITS,
- 13. REMOVE BAGS AT LEFT LANE, BEGIN BRIDGE AND RIGHT LANE, BEGIN BRIDGE AND ENCASE EXPOSED PILINGS AT ABUTMENTS.
- 14. HIGH PRESSURE WATER WASH AND TEXTURE COAT ALL EXPOSED CONCRETE SURFACES OF BENTS, WINGWALLS, PARAPETS, DECK OVERHANGS, AND OUTSIDE FACE AND BOTTOM FLANGE OF EXTERIOR GIRDERS. TOP AND INSIDES FACE OF PARAPET SHALL BE WHITE. ALL OTHER SURFACES SHALL BE MOUNTAIN GREY.
- 15. REPLACE DAMAGED GUARDRAIL ENDS AT LEFT LANE, BEGIN BRIDGE AND RIGHT LANE, END BRIDGE.
- 16. PLACE NEW STRIPING AND SIGNING AS APPROPRIATE.

SPECIFICATIONS & LOADING

SPECIFICATIONS: STANDARD ROAD AND BRIDGE SPECIFICATIONS OF THE TENNESSEE DEPARTMENT OF TRANSPORTATION (JANUARY 1, 2021 EDITION), AND THE 4TH EDITION (2017) AASHTO LRFD BRIDGE CONSTRUCTION SPECIFICATIONS WITH INTERIMS.

DESIGN SPECIFICATIONS: 9TH EDITION (2020) AASHTO LRFD BRIDGE DESIGN SPECIFICATIONS WITH INTERIMS, AND THE 2ND EDITION (2011) AASHTO GUIDE SPECIFICATIONS FOR LRFD SEISMIC BRIDGE DESIGN WITH INTERIMS.

STEEL, CONCRETE, REINFORCING, AND FORMING

REINFORCING STEEL: SHALL BE ASTM A615 GRADE 60 UNLESS NOTED OTHERWISE. SEE SECTION 604 AND 907 OF THE STANDARD SPECIFICATIONS.

HIGH EARLY STRENGTH CONCRETE: THE MIX IS TO MEET THE REQUIREMENTS OF THE STANDARD SPECIFICATIONS, CLASS "X". THE CEMENT CONTENT SHALL BE A MINIMUM OF 714 LBS. THE WATER-CEMENT RATIO SHALL BE A MAXIMUM OF 0.40. DESIGN AIR CONTENT SHALL BE 6% WITH ±2% ACCEPTANCE RANGE IN THE FIELD. SLUMP SHALL BE 3±1 INCHES. IF USING A TYPE A, F, OR G WATER REDUCER, THE SLUMP SHALL BE MAXIMUM OF 8 INCHES. NO FLY ASH REPLACEMENT WILL BE PERMITTED. THE MINIMUM 28 DAY COMPRESSIVE STRENGTH SHALL BE 3,500 PSI. TRAFFIC SHALL NOT BE PERMITTED ON ANY OF THE REPAIRED AREAS UNTIL TEST SPECIMENS ATTAIN A MINIMUM COMPRESSIVE STRENGTH OF 3,000 PSI AND THE CONCRETE HAS BEEN IN PLACE A MINIMUM OF TEN (10) DAYS.

CONCRETE CURING: ALL CONCRETE IN REPAIR AREAS SHALL BE CURED ACCORDING TO THE STANDARD SPECIFICATIONS.

MISCELLANEOUS GENERAL NOTES

SHOP DRAWINGS: REFER TO SECTION 105.02 OF THE STANDARD SPECIFICATIONS. IF USING PAPER COPIES. SHOP DRAWINGS ARE TO BE SENT TO THE BRIDGE REPAIR OFFICE IN THE DIVISION OF STRUCTURES, FOR ELECTRONIC SUBMITTALS, SEE SECTION 105.02 OF THE STANDARD SPECIFICATIONS. EACH SHOP DRAWING SHALL CONTAIN IN THE TITLE BLOCK THE FOLLOWING: THE STATE PROJECT NUMBER, COUNTY, BRIDGE NAME, BRIDGE NUMBER (OR STRUCTURE TYPE AND NUMBER), STATION, AND CONTRACT NUMBER. SHOP DRAWINGS WITH TITLE BLOCKS NOT INCLUDING THE FOREGOING IDENTIFICATION WILL BE RETURNED FOR CORRECTION BEFORE ANY REVIEWS FOR APPROVAL ARE CONDUCTED.

EXPANSION JOINTS: FOR ADDITIONAL GENERAL NOTES APPLICABLE TO STRIP SEAL EXPANSION JOINTS, SEE STANDARD DRAWING NOS. SBR-2-115 AND SBR-2-116, ALSO SEE SECTION 623 OF THE STANDARD SPECIFICATIONS.

SPECIAL NOTE FOR RAILROAD CROSSINGS: THE CONTRACTOR SHALL CONDUCT HIS WORK SO AS TO PROTECT THE RAILROAD TRACKS AND PROPERTIES FROM ANY DAMAGE. THE WORK SHALL BE DONE IN ACCORDANCE WITH REGULATIONS STIPULATED BY THE NORFOLK SOUTHERN RAILROAD SO AS TO MAINTAIN CLEARANCE AND NOT INTERRUPT TRAFFIC.

DEMOLITION: THE CONTRACTOR SHALL TAKE SPECIAL CARE TO PROTECT ANY PARTS OF THE STRUCTURE THAT ARE NOT TO BE REMOVED SPECIFICALLY. FOR FULL DEPTH SLAB REMOVAL, EXCEPT OVER BEAMS, THE MAXIMUM HAMMER SIZE IS 90 POUND CLASS. FOR PARTIAL DEPTH SLAB REMOVAL AND ANY WORK OVER THE BEAMS, THE MAXIMUM HAMMER SIZE IS 60 POUND CLASS: CHIPPING HAMMERS OF THE 15 POUND CLASS SHALL BE USED TO REMOVE CONCRETE FROM BENEATH ANY REINFORCING STEEL. SAWING OR CUTTING OF THE CONCRETE IS ACCEPTABLE AS LONG AS ANY SPECIFIED PROJECTION OF THE EXISTING REINFORCING STEEL IS MAINTAINED. EXPANSION JOINT REMOVAL SHALL FOLLOW THE SAME RESTRICTIONS AS FULL DEPTH SLAB REMOVAL. ALL DEVICES PROPOSED FOR CONCRETE DEMOLITION SHALL MEET THE APPROVAL OF THE ENGINEER

THE CONTRACTOR IS NOT ALLOWED TO USE A HYDRAULIC RAM MOUNTED ON A BACKHOE (COMMONLY CALLED A HOE RAM), MINI EXCAVATOR, OR OTHER EQUIPMENT FOR ANY CONCRETE REMOVAL.

QUICK-SET PATCHING MATERIAL: QUICK-SET PATCHING MATERIAL SHALL BE A POLYMER MODIFIED CEMENTITIOUS PATCHING MATERIAL. SEE TDOT QUALIFIED PRODUCTS LIST 13.009 POLY MOD CEMENT STRUCT PATCH VERT & OVER FOR ACCEPTABLE PATCHING MATERIALS.

FORMS AND FALSEWORK: CONCRETE FORM WORK, FALSEWORK AND TEMPORARY SUPPORTS SHALL BE REMOVED FROM THE JOB SITE AFTER WORK IS COMPLETED. COST OF FORMS. FALSEWORK AND TEMPORARY SUPPORTS SHALL BE INCLUDED IN ITEMS BID ON. THIS WORK SHALL BE COMPLETED BEFORE FINAL PAYMENT IS APPROVED.

PROTECTIVE FENCE: RAILROAD PROTECTIVE FENCE IS REQUIRED TO BE BUILT IN ACCORDANCE with STANDARD DRAWING STD-8-5. DIMENSION "H"AS SHOWN ON STANDARD DRAWING STD-8-5 SHALL BE 10'-0".

THE CONTRACTOR SHALL BE SOLELY RESPONSIBLE FOR THE STABILITY OF THE STRUCTURE DURING REPAIRS.

ANY AREA THAT IS DISTURBED OUTSIDE THE LIMITS OF THE CONSTRUCTION DURING THE LIFE OF THE PROJECT SHALL BE REPAIRED BY THE CONTRACTOR AT THE CONTRACTOR'S EXPENSE.

DATE: AUGUST 2021

DATE: AUGUST 2021

DATE: AUGUST 2021

DATE: AUGUST 2021

	ESTIMATED BRIDGE QUANTITIES							
	ITEM NO.	DESCRIPTION	UNIT	30-SR034-17.25 L	30-SR034-17.25 R	TOTAL		
1	604-04.02	APPLIED TEXTURE FINISH (EXISTING STRUCTURES)	S.Y.	1054	1056	2110		
(2)	604-10.05	CONCRETE	S.F.	214	288	502		
*	604-10.30	BRIDGE DECK REPAIR (FULL DEPTH OF SLAB)	S.Y.	5	5	10		
*	604-10.34	CONCRETE OVERLAYED BRIDGE DECK REPAIR (FULL DEPTH)	S.Y.	150	150	300		
4	604-10.44	EXPANSION JOINT REPAIRS	L.F.	41	41	82		
k	604-10.50	BRIDGE DECK REPAIR (PARTIAL DEPTH OF SLAB)	S.Y.	5	5	10		
3	604-10.54	CONCRETE REPAIRS	S.F.	46	63	109		
•	604-10.55	CONCRETE (FOUNDATION REPAIRS)	C.Y.	4	1	5		
*	604-10.56	CONCRETE OVERLAYED BRIDGE DECK REPAIR (PARTIAL DEPTH)	S.Y.	20	20	40		
	604-10.58	EPOXY INJECTION (INJECTION)	GAL.	2	3	5		
•	604-10.62	EPOXY INJECTION REPAIR (COMPLETE AND IN PLACE)	L.F.	46	57	103		
	617-04.01	TYPE 1 THIN OVERLAY (EPOXY URETHANE)	S.Y.	802	802	1604		
	707-07.01	CHAIN-LINK FENCE (BRIDGES)	S.F.	1115	1115	2230		
L								

^{*} DENOTES ITEM CAN BE INCREASED, DECREASED, OR ELIMINATED AS DIRECTED BY THE ENGINEER.

FOOTNOTES

- 1 INCLUDES ALL LABOR AND MATERIALS NECESSARY FOR THE APPLICATION OF ALL TEXTURE COATING FOR THE FULL LENGTH OF THE BRIDGE AS SHOWN IN THE TEXTURE COATING DETAIL ON THIS SHEET. ALSO INCLUDES SURFACE PREPARATION USING A HIGH PRESSURE WASH TO REMOVE ALL LOOSE COATINGS, FLAKING, AND OTHER FOREIGN SUBSTANCES TO THE FULL SATISFACTION OF THE ENGINEER.
- (2) INCLUDES ALL LABOR AND MATERIALS NECESSARY TO PLACE HIGH EARLY STRENGTH CONCRETE FOR REPAIR OF INDICATED AREAS.
- (3) INCLUDES THE COST OF ALL LABOR AND MATERIALS NECESSARY TO PLACE A POLYMER MODIFIED CEMENTITIOUS STRUCTURAL PATCHING MATERIAL FOR REPAIR OF INDICATED AREAS.
- (4) INCLUDES ALL LABOR AND MATERIALS NECESSARY TO REPLACE EXPANSION JOINT SEALS AT BENT 1

RAILROAD NOTES

THE CONTRACTOR SHALL CONDUCT HIS WORK SO AS TO PROTECT THE RAILROAD'S TRACKS AND PROPERTIES FROM ANY DAMAGE. THE WORK SHALL BE DONE IN ACCORDANCE WITH REGULATIONS STIPULATED BY EACH INDIVIDUAL RAILROAD BEING AFFECTED BY THIS PROJECT AT THE PRECONSTRUCTION MEETING SO AS TO MAINTAIN CLEARANCE AND NOT INTERRUPT TRAFFIC IN ANY MANNER.

FOR A GENERAL LIST OF ANTICIPATED CONSTRUCTION SUBMISSIONS, PLEASE REVIEW SECTION 6.A.2 OF THE NORFOLK SOUTHERN SPECIAL PROVISIONS FOR PROTECTION OF RAILWAYS INTERESTS. A LIST OF REQUIRED SUBMISSIONS WILL BE PROVIDED AT THE PRECONSTRUCTION MEETING.

THE CONTRACTOR SHALL PROVIDE INFORMATION REGARDING SITE ACCESS, INCLUDING ANY NECESSARY TEMPORARY CROSSING TO PERFORM CONSTRUCTION ACTIVITIES WITHIN NS ROW TO NS FOR REVIEW AND APPROVAL

THE CONTRACTOR SHALL USE EXTREME CARE AND TAKE ANY MEASURE NECESSARY TO PREVENT DEBRIS FROM FALLING ONTO THE RAILROAD'S RIGHT-OF-WAY. THE METHOD PROPOSED TO ACCOMPLISH THIS MUST BE SUBMITTED TO NORFOLK SOUTHERN FOR REVIEW AND APPROVAL PRIOR TO USE AND MUST NOT INFRINGE ON THE VERTICAL AND/OR HORIZONTAL CLEARANCES IN THESE PLANS. THE TEMPORARY MINIMUM VERTICAL AND HORIZONTAL CONSTRUCTION CLEARANCES THAT THE CONTRACTOR MUST MEET AT ALL TIMES ARE LISTED IN SECTION 5,A OF THE NORFOLK SOUTHERN SPECIAL PROVISIONS FOR PROTECTION OF RAILWAYS INTERESTS. WHICH CRITERIA ARE INCLUDED IN THE SPECIAL PROVISION 105C. NORFOLK SOUTHERN CORPORATION WILL NOT ALLOW TRACK OR TRACKS TO BE OBSTRUCTED WITH AT GRADE CRANE MAT PROTECTION. COMPLETE AND FULL ENCLOSURE OF STRUCTURE DEMOLITION WITHIN ALLOWABLE CLEARANCES WILL BE REQUIRED. THE COST OF REMOVING AND DISPOSING OF DEBRIS. AND THE COMPLETE AND FULL PROTECTION OF THE CONTRACTOR'S WORK AREA FOR DEMOLITION SHALL BE INCLUDED IN UNIT ITEMS BID ON.

CONTRACTOR PROTECTIVE SERVICES SHALL BE ONSITE ANYTIME CONSTRUCTION ACTIVITIES ARE TAKING PLACE ON OR ADJACENT TO THE RAILROAD PROPERTY AND/OR HAVE THE POTENTIAL TO FOUL THE RAILROAD'S TRACK OR OPERATIONS. SEE SECTION 8 OF THE NORFOLK SOUTHERN SPECIAL PROVISIONS FOR PROTECTION OF RAILWAY INTERESTS - DIRECT HIRE FOR ADDITIONAL CLARIFICATIONS AND REQUIREMENTS REGARDING CONTRACTOR PROTECTIVE SERVICES.

PER SECTION H.1.5.J OF THE NS PUBLIC PROJECTS MANUAL, NO DRAINAGE IS PERMITTED TO DRAIN ONTO RAILROAD PROPERTY. THIS INCLUDES ANY WASH WATER FROM THE CLEANING OF EXPOSED CONCRETE SURFACES. HOWEVER, EXISTING DRAINS MAY REMAIN WITHOUT MODIFICATIONS. THE CONTRACTOR SHALL MAKE PROVISIONS TO COLLECT AND CONTAIN ALL WASH WATER TO ENSURE IT DOES NOT FALL ON TO RAILROAD PROPERTY. THE CONTRACTOR SHALL NOT DISCHARGE WASH WATER ON TO RAILROAD PROPERTY.

ALL WORK ON, OVER, UNDER, OR ADJACENT TO NORFOLK SOUTHERN (NS) RIGHT-OF-WAY SHALL BE DONE IN ACCORDANCE WITH THE NORFOLK SOUTHERN "SPECIAL PROVISIONS FOR THE PROTECTION OF RAILWAY INTERESTS" (NS SPECIAL PROVISIONS).

THE CONTRACTOR SHALL SUBMIT UNDER SEPARATE COVER A DEMOLITION DEBRIS SHIELD INSTALLATION PLAN.

CONTRACTOR WILL NOT BE PERMITTED TO STORE ANY EQUIPMENT ON NS PROPERTY WITHOUT PERMISSION FROM THE NS RAILROAD ENGINEER IN ACCORDANCE WITH SECTION E.5.K.1 OF THE NS PUBLIC PROJECTS MANUAL.

ALL UTILITY INSTALLATIONS OR RELOCATIONS THAT ARE REQUIRED IN CONJUNCTION WITH THIS PROJECT CAN BE INSTALLED OR RELOCATED AS PART OF THE PROJECT PROVIDED THE CONSTRUCTION IS PERFORMED BY THE PROJECT CONTRACTOR OR PROJECT CONTRACTOR'S SUB-CONTRACTOR. HOWEVER, THE UTILITY MUST SUBMIT AN APPLICATION FOR THE INSTALLATION OR RELOCATION TO NS PIPE AND WIRE FOR APPROPRIATE HANDLING FOR LICENSE AGREEMENT AND APPLICABLE FEES. FOR UTILITY APPLICATIONS GO TO: http://www.nscorp.com/content/nscorp/en/real-estate/norfolk-southern-services/wire-pipeline-fiber-optic-projects.html. NOTE: LICENSE AGREEMENT MUST BE EXECUTED PRIOR TO UTILITY BEING INSTALLED OR RELOCATED.

NORFOLK SOUTHERN CORP. CONTACT ADDRESSES:

SHAWN STARLING, P.E. SENIOR ENGINEER PUBLIC IMPROVEMENTS NORFOLK SOUTHERN RAILWAY COMPANY ENGINEERING - DESIGN & CONSTRUCTION 650 WEST PEACHTREE STREET NW - BOX 45 ATLANTA, GA 30308 PHONE (470) 463-6721 EMAIL douglas.starling@nscorp.com

PAUL A ANDERSON, DIVISION ENGINEER 1400 NORFOLK SOUTHERN DRIVE BIRMINGHAM, AL 35210 PHONE (304) 266-1558 EMAIL paul.anderson@nscorp.com

30S034-M3-002			2025	
			REVISIONS	
NO.	DATE	BY	BRIEF	DESCRIPTION
	PROTE FENCE			
			FED. SPEC	EXTURE FINISH, WHITE, . NO. 37886

YEAR

SHEET NO.

PROJECT NO.

APPLIED TEXTURE FINISH SKETCH

LEFT SIDE ONLY SHOWN, SKETCH IS SYMMETRIC ABOUT © BRIDGE.

IN ADDITION TO SURFACES SHOWN, ALL EXPOSED CONCRETE SURFACES ON THE ABUTMENT BEAMS, WINGWALLS, BENTS, AND ALL CAP BEAMS AND COLUMNS ARE TO RECEIVE AN APPLIED TEXTURE FINISH, (GREY, AMS-STD-595A, COLOR NO. 36440).

COST OF TEXTURE COATING SHALL BE INCLUDED IN ITEM NO. 604-04.02.


APPLIED TEXTURE FINISH.

GREY, FED. SPEC. NO. 36440 -

THE CONTRACTOR SHALL USE CONTAINMENT SCREENS OR OTHER MEASURES AS NECESSARY TO PREVENT ANY TEXTURE COATING FROM ENTERING THE ENVIRONMENT. CONTAINMENT MEASURES SHALL BE APPROVED BY THE ENGINEER AND COST SHALL BE INCLUDED IN ITEMS BID ON.

THE EXISTING SURFACES THAT ARE TO RECEIVE A TEXTURE FINISH SHALL BE FREE OF ALL FLAKING TEXTURE COATING, RUST, DIRT, OIL, AND OTHER FOREIGN SUBSTANCES PRIOR TO THE APPLICATION OF THE TEXTURE FINISH. THE SURFACE SHALL BE CLEANED TO THE COMPLETE SATISFACTION OF THE ENGINEER USING A HIGH PRESSURE WATER WASH, COST TO BE INCLUDED IN ITEM NO. 604-04.02.

THE WASH WATER IS TO BE FILTERED AND PAINT CHIPS AND DEBRIS COLLECTED PRIOR TO RELEASE OF WATER.

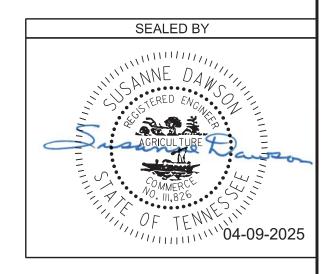


STATE OF TENNESSEE **DEPARTMENT OF TRANSPORTATION GENERAL NOTES AND ESTIMATED BRIDGE QUANTITIES** BRIDGE NO. 30-SR34-17.25 (L & R) FEDERAL BRIDGE ID NOS. 30FA0343003 & 30FA0343004 BRIDGES OVER SNAPPS FERRY RD. & NFS RAILWAY, LM 17.25 GREENE COUNTY

2025

BR-131-903

PIN NO.:	082699.01
DESIGN BY:	SUSANNE DAWSON
DRAWN BY:	DONNIE PICKEL
SUPERVISED BY:	SUSANNE DAWSON
CHECKED BY:	FRANK BALE

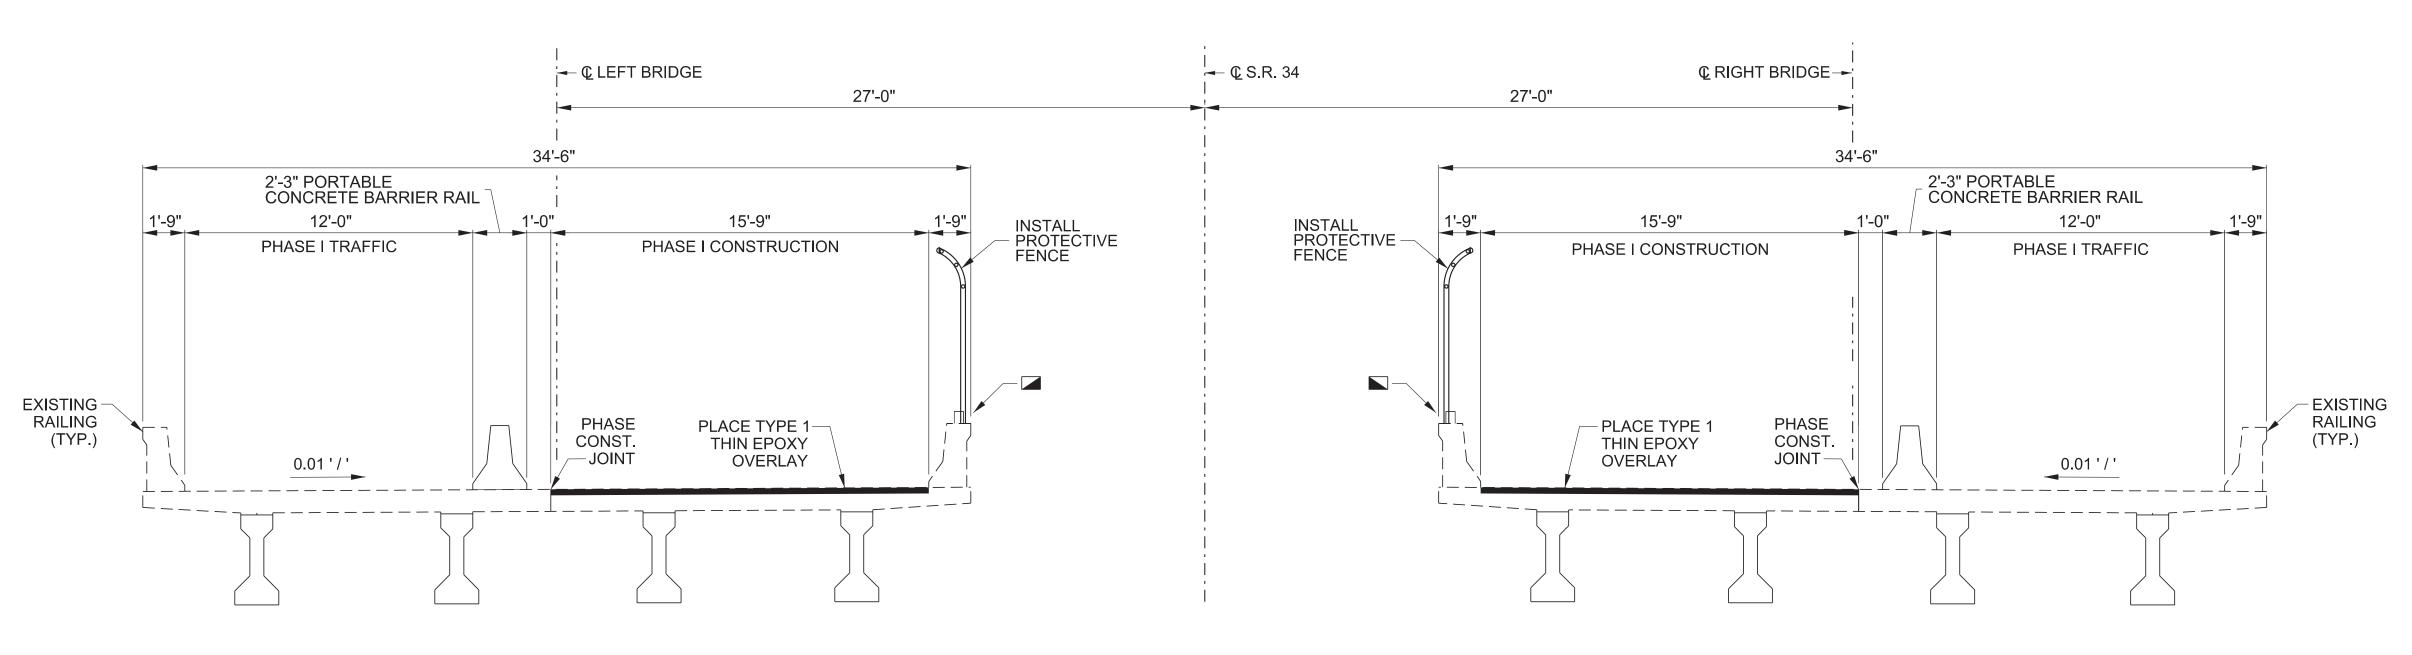

PROJECT NO. YEAR SHEET NO.


30S034-M3-002 2025

REVISIONS

NO. DATE BY BRIEF DESCRIPTION

PHASE I CONSTRUCTION (LOOKING AHEAD ON SURVEY)

✓ INSTALL PARAPET DELINEATORS (COST TO BE INCLUDED IN ITEMS BID ON)

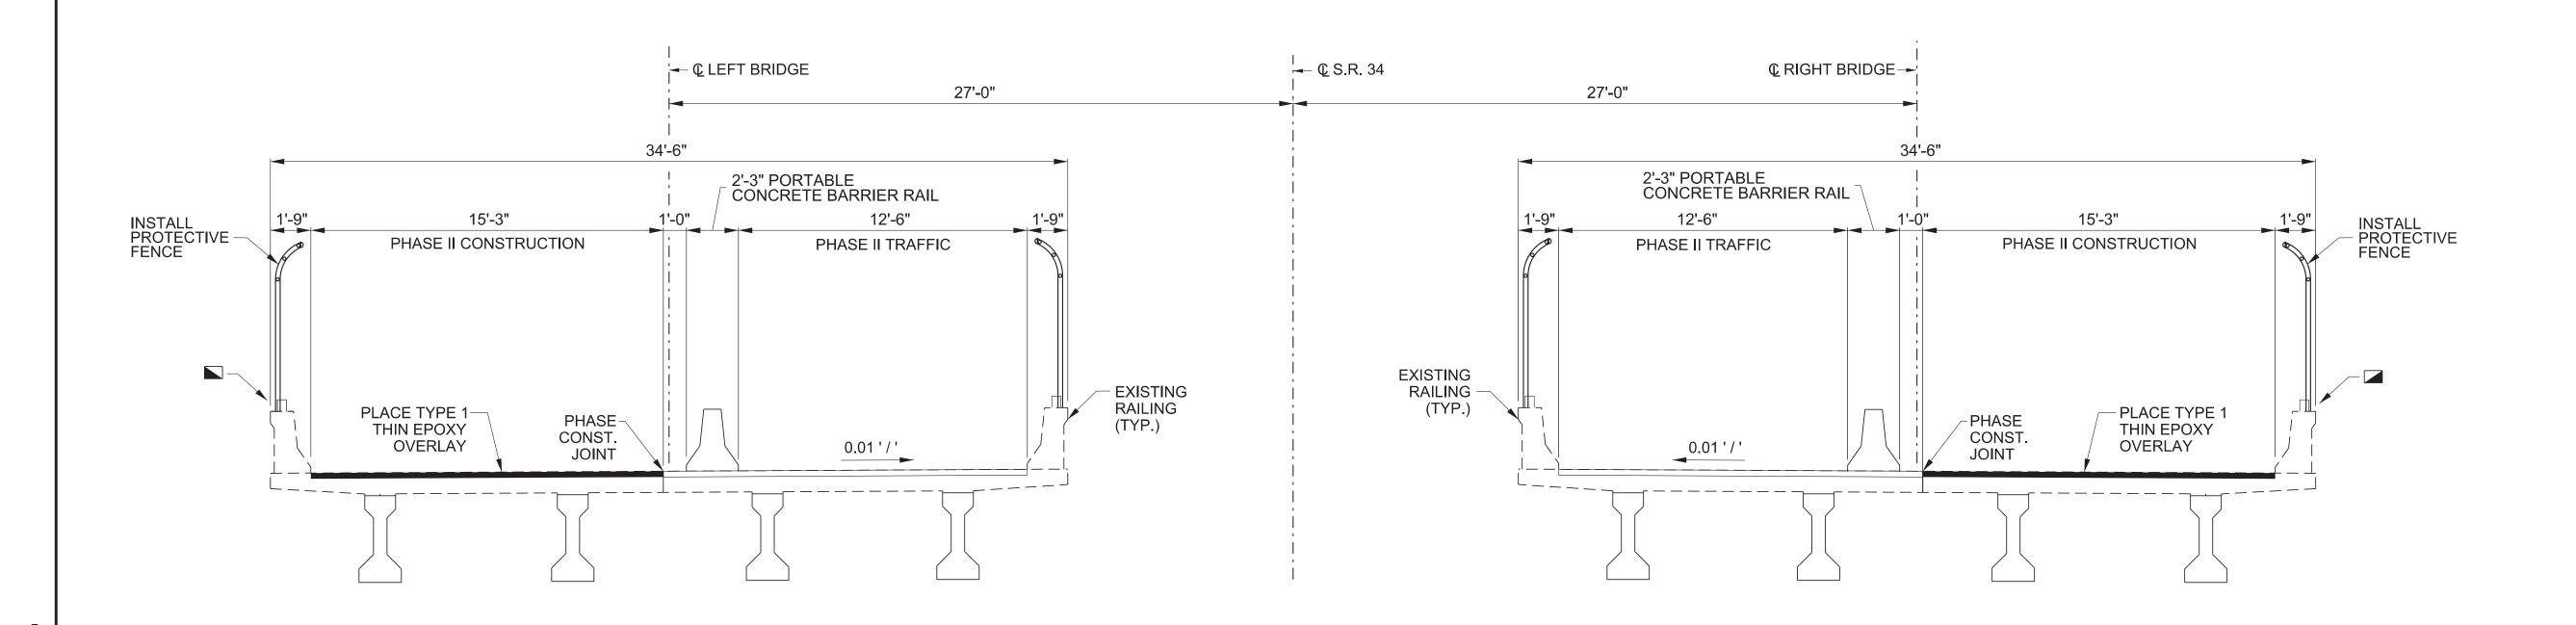

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OF TENNE

03-25-2025

PHASE II CONSTRUCTION (LOOKING AHEAD ON SURVEY)

✓ INSTALL PARAPET DELINEATORS (COST TO BE INCLUDED IN ITEMS BID ON)

DESIGN BY: SUSANNE DAWSON DATE: AUGUST 2021

DRAWN BY: DONNIE PICKEL DATE: AUGUST 2021

SUPERVISED BY: SUSANNE DAWSON DATE: AUGUST 2021

CHECKED BY: FRANK BALE DATE: AUGUST 2021

082699.01

STATE OF TENNESSEE DEPARTMENT OF TRANSPORTATION

PHASE CONSTRUCTION

BRIDGE NO. 30-SR34-17.25 (L & R)
FEDERAL BRIDGE ID NOS.
30FA0343003 & 30FA0343004
BRIDGES OVER SNAPPS FERRY RD.
& NFS RAILWAY, LM 17.25
GREENE COUNTY

2025 F

BR-131-904

PIN NO.:

2025

BR-131-905

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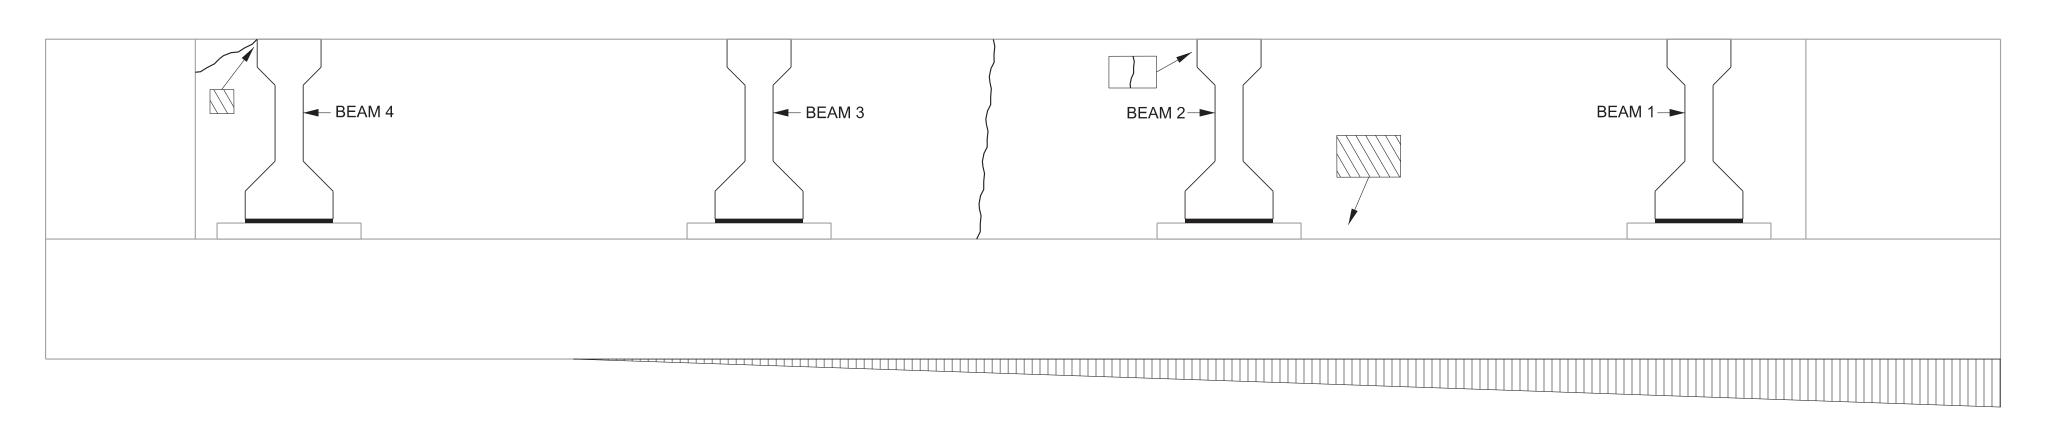
FRANK BALE

	DENOTES CRACK TO BE EPOXY INJECTED. QUANTITIES AND LOCATIONS SHOWN ARE APPROXIMATE AND MAY BE INCREASED, DECREASED OR ELIMINATED BY THE ENGINEER. SEE EPOXY INJECTION NOTES ON DWG. NO. BR-131-915.
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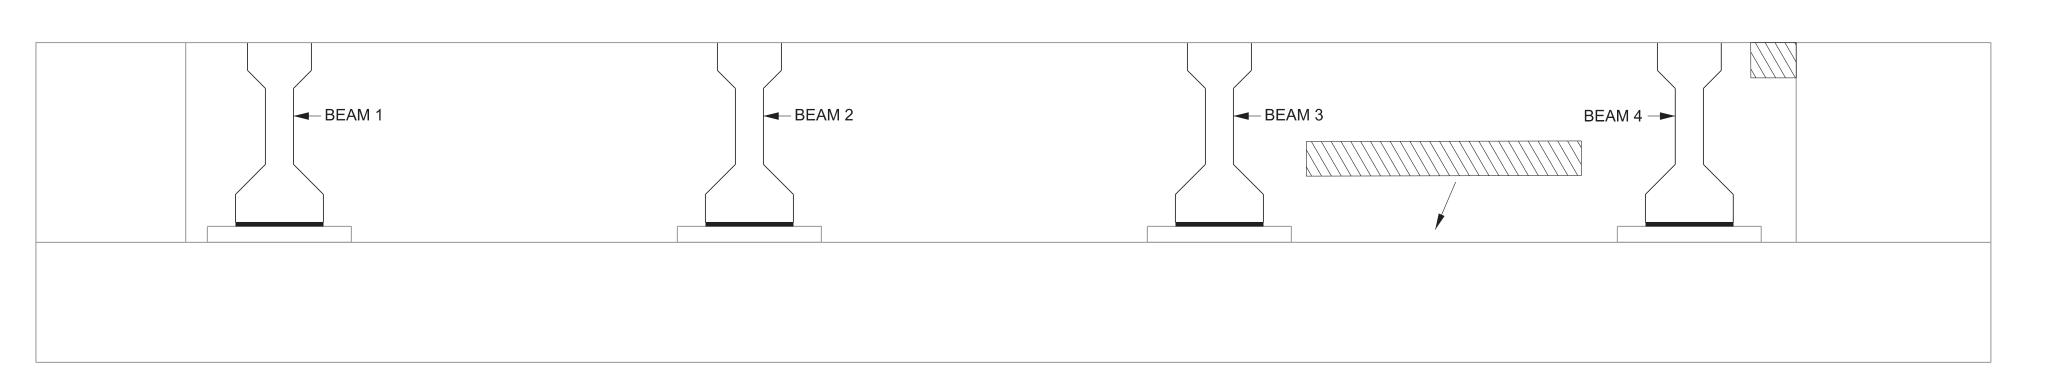
DENOTES AREA TO BE REPAIRED UNDER ITEM NO. 604-10.05 AND/OR 604-10.54. SEE REPAIR DETAILS ON DWG. NO. BR-131-915.
AND/OR 604-10.54, SEE REPAIR DETAILS ON DWG. NO. BR-131-915.

П	DENOTES LOCATION TO BE REPAIRED BY PLACEMENT OF CONCRETE
	UNDER ITEM NO. 604-10.55, CONCRETE (FOUNDATION REPAIRS), C.Y.
	SEE FILL SETTLEMENT DETAIL (THIS SHEET).

THE CONTRACTOR SHALL BE SOLELY RESPONSIBLE FOR
THE STABILITY OF THE STRUCTURE DURING REPAIRS.




LEFT BRIDGE **ABUTMENT 1 ELEVATION** (LOOKING BACK ON SURVEY) (NOT TO SCALE)



RIDGE ELEVATION ON SURVEY) CALE)


ESTIMATED QUANTITIES			
LOCATION OF REPAIR	ITEM NO. 604-10.05, CONCRETE, AND/OR 604-10.54, CONCRETE REPAIRS	ITEM NO. 604-10.55 CONCRETE (FOUNDATION REPAIRS)	ITEM NO. 604-10.62 EPOXY INJECTION REPAIR (COMPLETE AND IN PLACE)
LEFT BRIDGE	APPROX. REPAIR AREAS (S.F.)	APPROX. REPAIR AREAS (L.F.)	APPROX. REPAIR AREAS (L.F.)
ABUTMENT 1	2	4	6
ABUTMENT 2	5	-	-

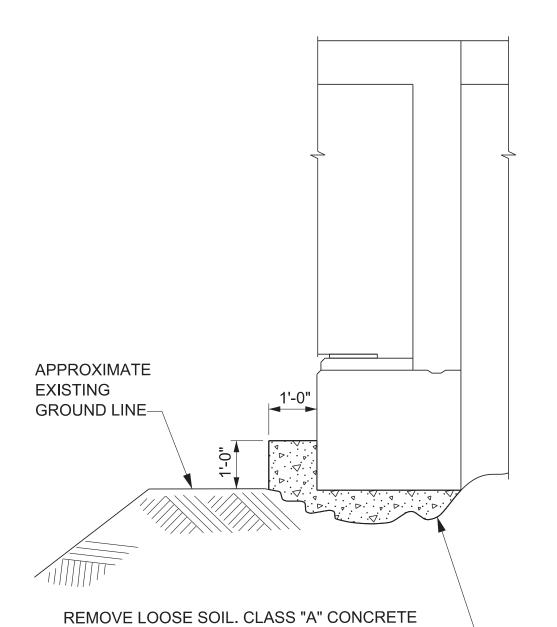

TO BE PLACED FROM FRONT SIDE OF ABUTMENT, FORMED AND FULLY CONSOLIDATED INTO PLACE.

FILL SETTLEMENT REPAIR DETAIL

ALL COST ASSOCIATED WITH REPAIR OF SETTLEMENT AREA, INCLUDING ALL LABOR AND MISCELLANEOUS MATERIALS, SHALL BE INCLUDED IN ITEM NO. 604-10.55, CONCRETE (FOUNDATION REPAIRS), C.Y.

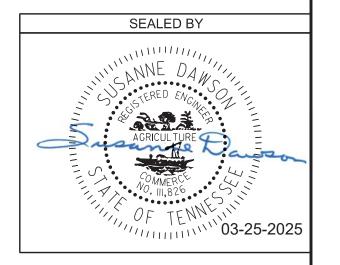

STATE OF TENNESSEE DEPARTMENT OF TRANSPORTATION ABUTMENT REPAIRS LEFT BRIDGE

BRIDGE NO. 30-SR34-17.25 (L & R) FEDERAL BRIDGE ID NOS. 30FA0343003 & 30FA0343004 BRIDGES OVER SNAPPS FERRY RD. & NFS RAILWAY, LM 17.25

GREENE COUNTY 2025

BR-131-906

LEFT BRID ABUTMENT 2 EL
ABOTMENT 2 LL
(LOOKING AHEAD C
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PIN NO.:	082699.01	
DESIGN BY:	SUSANNE DAWSON	DATE: AUGUST 2021
DRAWN BY:	DONNIE PICKEL	DATE: AUGUST 2021
SUPERVISED BY:	SUSANNE DAWSON	DATE: AUGUST 2021
CHECKED BY:	FRANK BALE	DATE: AUGUST 2021


DENOTES CRACK TO BE EPOXY INJECTED. QUANTITIES AND
LOCATIONS SHOWN ARE APPROXIMATE AND MAY BE INCREASED,
DECREASED OR ELIMINATED BY THE ENGINEER. SEE EPOXY
INJECTION NOTES ON DWG. NO. BR-131-915.
DENOTES AREA TO BE REPAIRED UNDER ITEM NO. 604-10.05

AND/OR 604-10.54. SEE REPAIR DETAILS ON DWG. NO. BR-131-915.

DENOTES LOCATION TO BE REPAIRED BY PLACEMENT OF CONCRETE UNDER ITEM NO. 604-10.55, CONCRETE (FOUNDATION REPAIRS), C.Y. SEE FILL SETTLEMENT DETAIL (THIS SHEET).

THE CONTRACTOR SHA	ALL BE SOLELY RESPONSIBLE FOR
THE STABILITY OF THE	STRUCTURE DURING REPAIRS.

PROJECT NO. 30S034-M3-002		YEAR	SHEET NO.	
		2025		
REVISIONS				
NO.	DATE	BY	BRIEF DESCRIPTION	

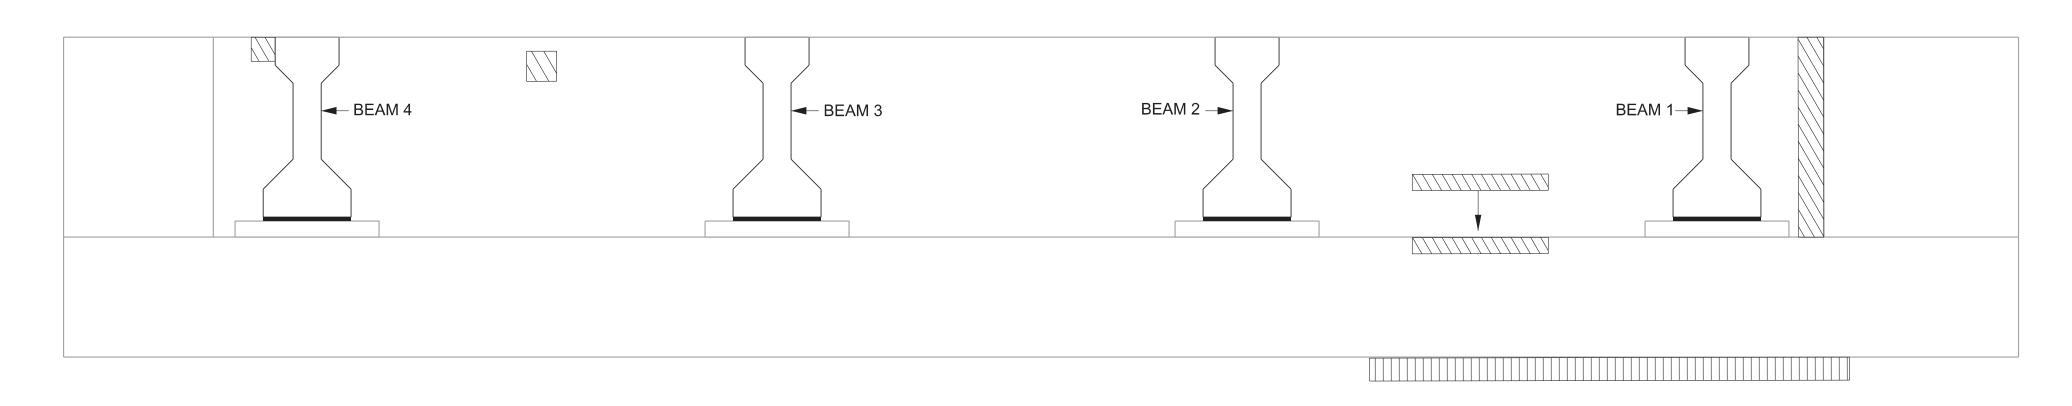

RIGHT BRIDGE


ABUTMENT 1 ELEVATION

(LOOKING BACK ON SURVEY)

(NOT TO SCALE)


■ BEAM 2

■ BEAM 1

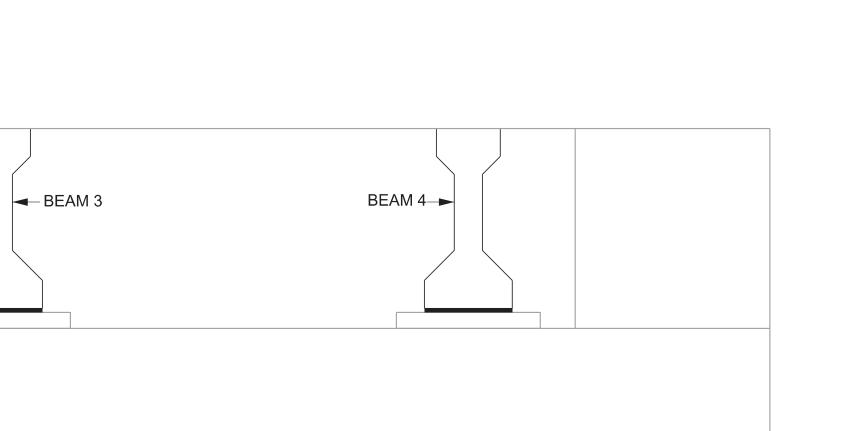

RIGHT BRIDGE
ABUTMENT 2 ELEVATION
(LOOKING AHEAD ON SURVEY)
(NOT TO SCALE)


	ESTIMATED QUANTITIES					
LOCATION OF REPAIR	ITEM NO. 604-10.05, CONCRETE, AND/OR 604-10.54, CONCRETE REPAIRS	ITEM NO. 604-10.55 CONCRETE (FOUNDATION REPAIRS)	ITEM NO. 604-10.62 EPOXY INJECTION REPAIR (COMPLETE AND IN PLACE)			
RIGHT BRIDGE	APPROX. REPAIR AREAS (S.F.)	APPROX. REPAIR AREAS (L.F.)	APPROX. REPAIR AREAS (L.F.)			
ABUTMENT 1	5	1	-			
ABUTMENT 2	1	-	1			

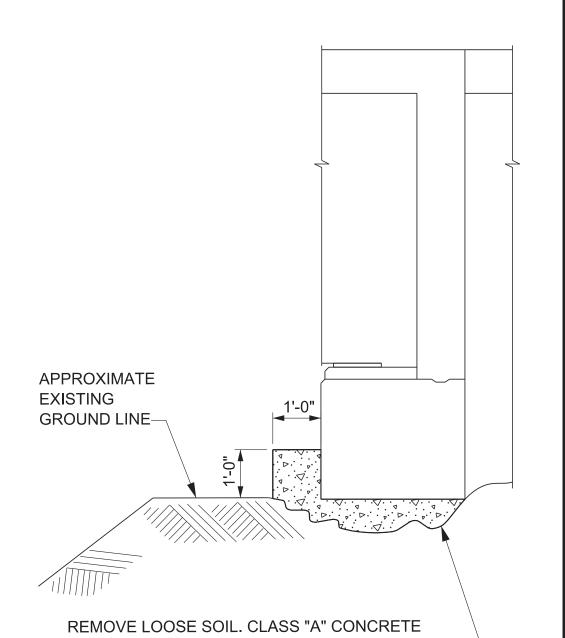

TO BE PLACED FROM FRONT SIDE OF ABUTMENT, FORMED AND FULLY CONSOLIDATED INTO PLACE.

FILL SETTLEMENT REPAIR DETAIL

ALL COST ASSOCIATED WITH REPAIR OF SETTLEMENT AREA, INCLUDING ALL LABOR AND MISCELLANEOUS MATERIALS, SHALL BE INCLUDED IN ITEM NO. 604-10.55, CONCRETE (FOUNDATION REPAIRS),C.Y.

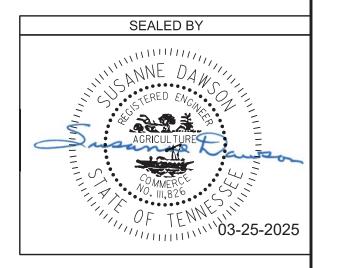



STATE OF TENNESSEE
DEPARTMENT OF TRANSPORTATION
ABUTMENT REPAIRS
RIGHT BRIDGE

BRIDGE NO. 30-SR34-17.25 (L & R)
FEDERAL BRIDGE ID NOS.
30FA0343003 & 30FA0343004
BRIDGES OVER SNAPPS FERRY RD.
& NFS RAILWAY, LM 17.25
GREENE COUNTY

2025 BR-131-907

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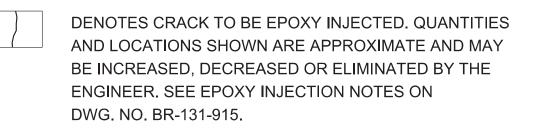


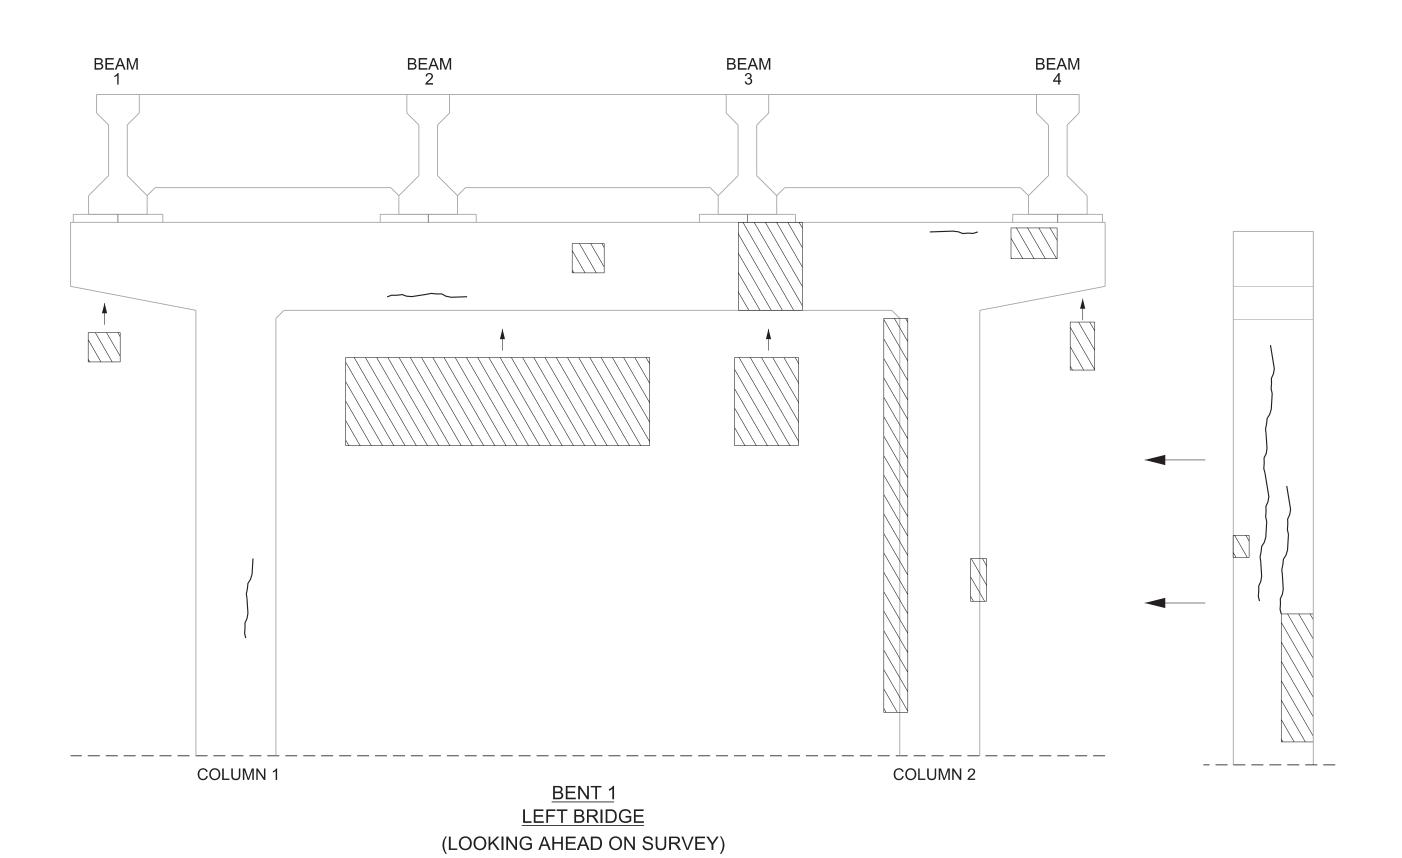
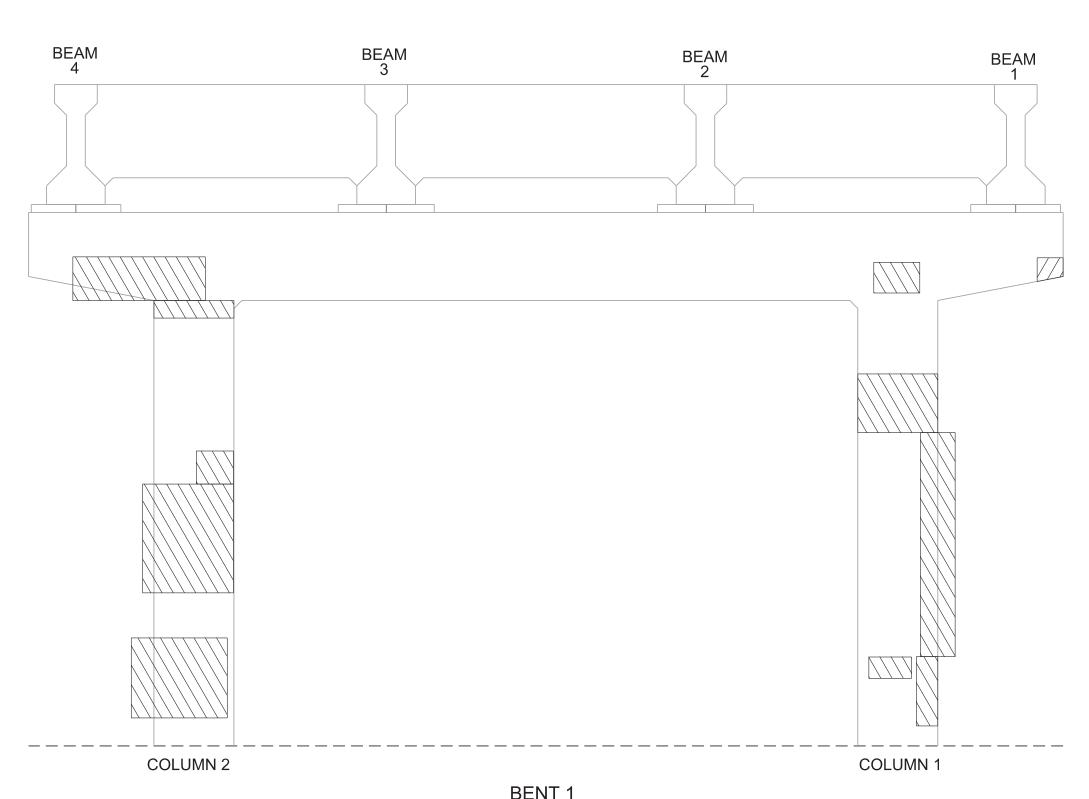
<u>DLIVI</u>
LEFT BRIDGE
(LOOKING BACK ON SURVEY)

	ESTIMATED QUANTITIES					
LOCATION OF REPAIR	ITEM NO. 604-10.05, CONCRETE, AND/OR 604-10.54, CONCRETE REPAIRS	ITEM NO. 604-10.62 EPOXY INJECTION REPAIR (COMPLETE AND IN PLACE)				
LEFT BRIDGE	APPROX. REPAIR AREAS (S.F.)	APPROX. REPAIR AREAS (L.F.)				
BENT 1	97	19				


PROJECT NO.			YEAR	SHEET NO.
30S034-M3-002		2025		
			REVISIONS	
NO.	DATE	BY	BRIEF	DESCRIPTION
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DENOTES AREA TO BE REPAIRED UNDER ITEM NO. 604-10.05 AND/OR 604-10.54. SEE REPAIR DETAILS ON DWG. NO. BR-131-915.

THE CONTRACTOR SHALL BE SOLELY RESPONSIBLE FOR THE STABILITY OF THE STRUCTURE DURING REPAIRS.



STATE OF TENNESSEE DEPARTMENT OF TRANSPORTATION BENT REPAIRS BENT 1 - LEFT BRIDGE

BRIDGE NO. 30-SR34-17.25 (L & R) FEDERAL BRIDGE ID NOS. 30FA0343003 & 30FA0343004 BRIDGES OVER SNAPPS FERRY RD. & NFS RAILWAY, LM 17.25 GREENE COUNTY

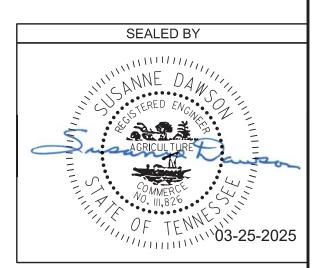2025

BR-131-908


PIN NO.: DESIGN BY: DRAWN BY:

CHECKED BY:_

082699.01 SUSANNE DAWSON DATE: AUGUST 2021 DATE: AUGUST 2021 DONNIE PICKEL SUSANNE DAWSON DATE: AUGUST 2021 SUPERVISED BY:

DATE: AUGUST 2021

FRANK BALE

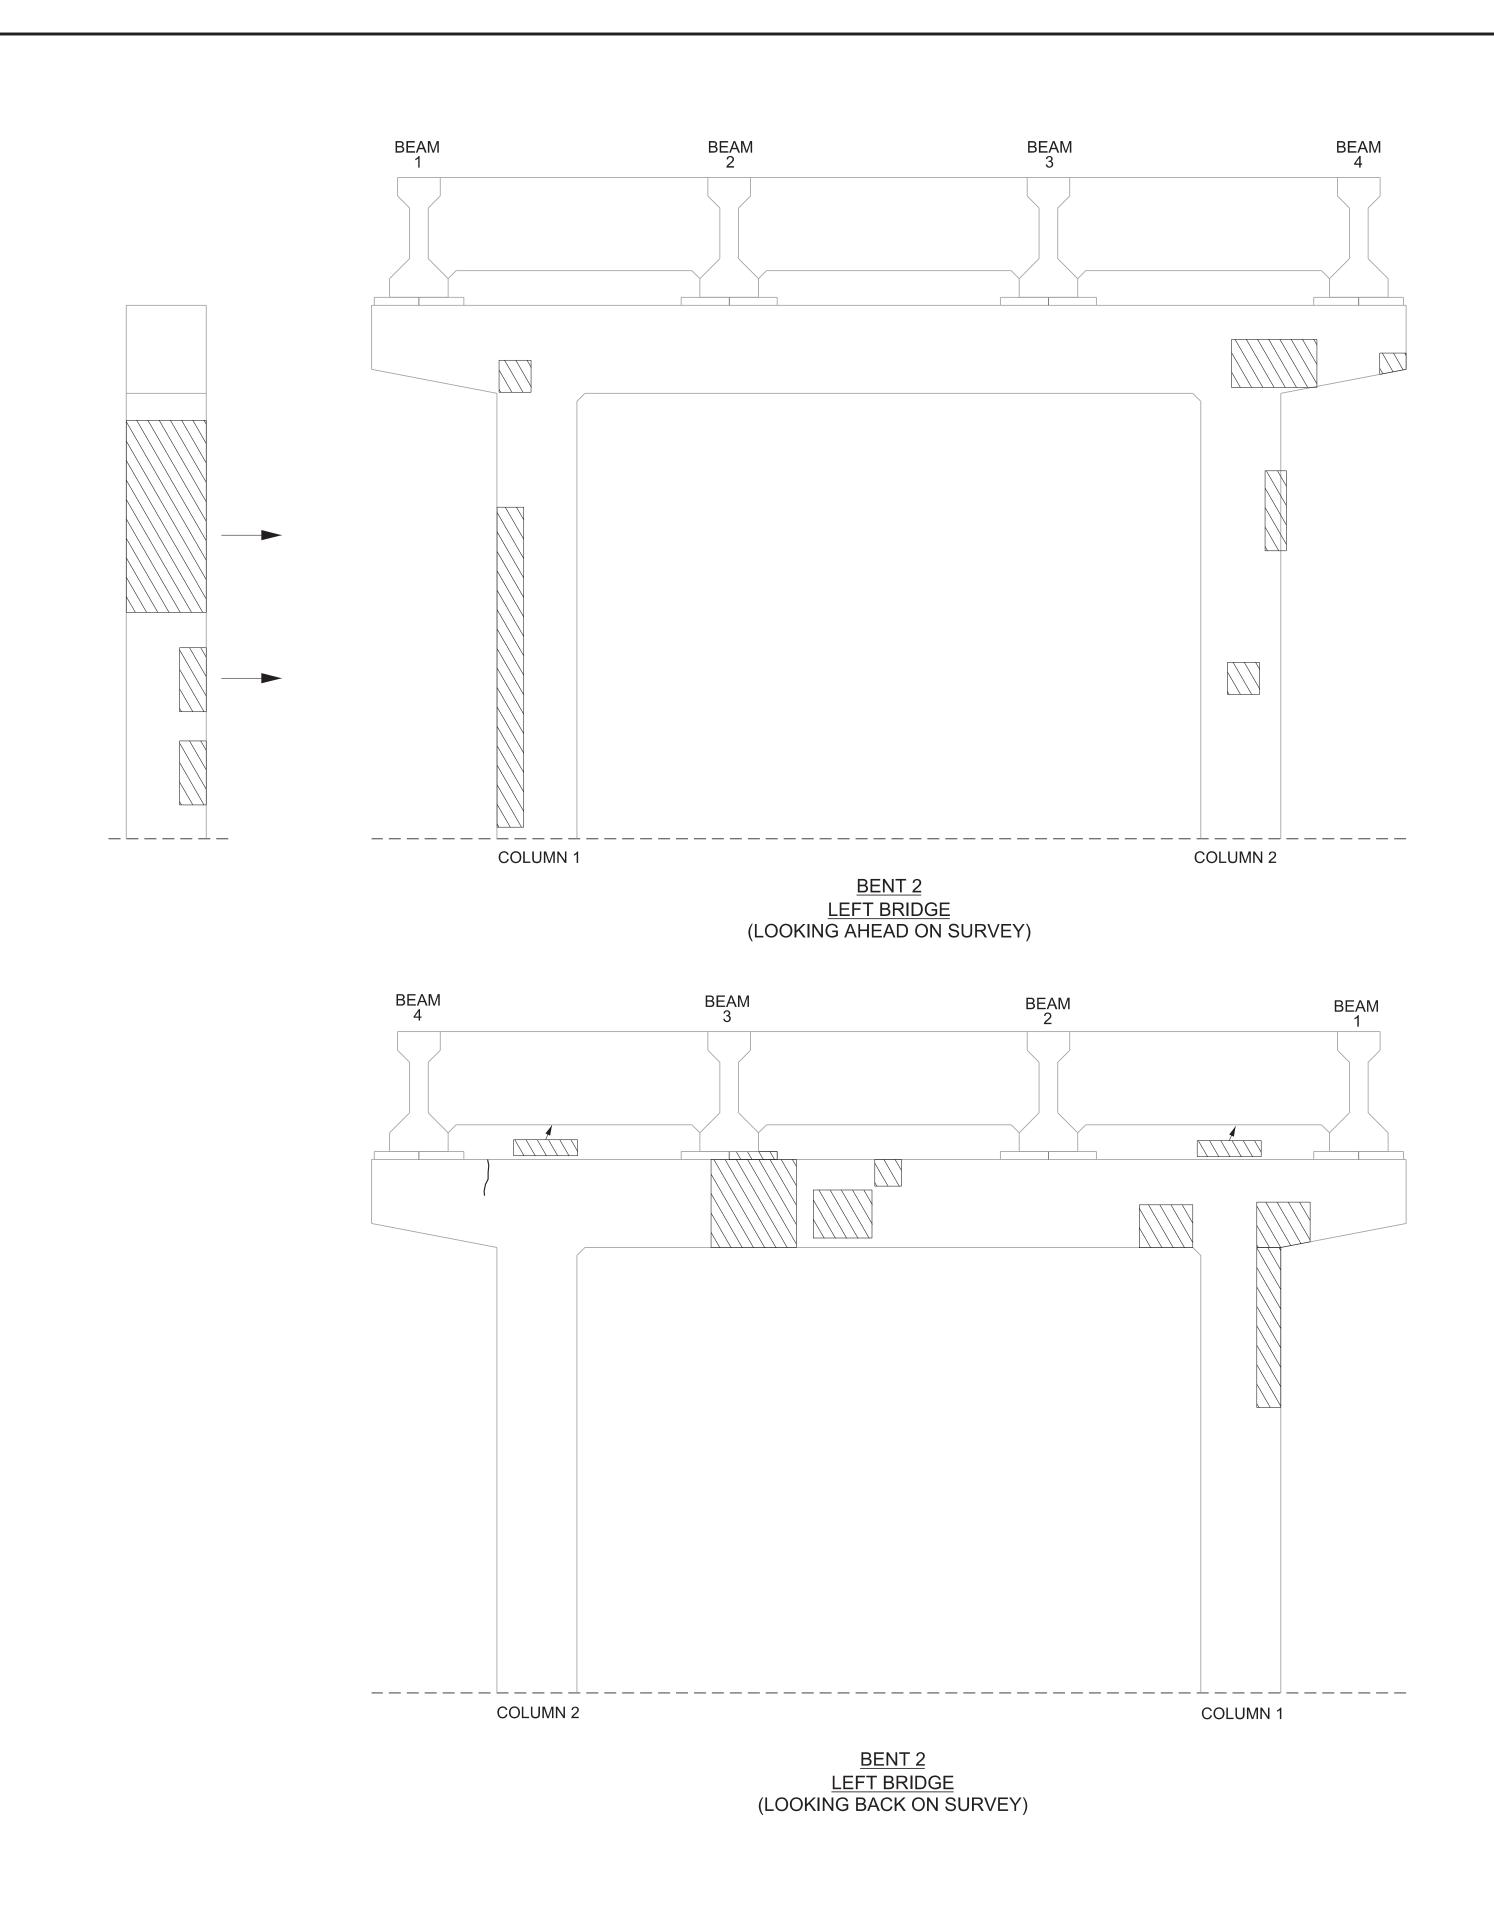


PROJECT NO.		YEAR	SHEET NO.	
30S034-M3-002		2025		
			REVISIONS	
NO.	DATE	BY	BRIEF DESCRIPTION	

DENOTES CRACK TO BE EPOXY INJECTED. QUANTITIES AND LOCATIONS SHOWN ARE APPROXIMATE AND MAY BE INCREASED, DECREASED OR ELIMINATED BY THE ENGINEER. SEE EPOXY INJECTION NOTES ON DWG. NO. BR-131-915.

DENOTES AREA TO BE REPAIRED UNDER ITEM NO. 604-10.05 AND/OR 604-10.54.
SEE REPAIR DETAILS ON DWG. NO. BR-131-915.

THE CONTRACTOR SHALL BE SOLELY RESPONSIBLE FOR THE STABILITY OF THE STRUCTURE DURING REPAIRS.

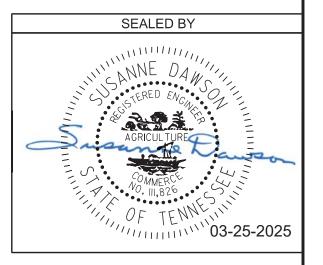

ESTIMATED QUANTITIES ITEM NO. 604-10.05, CONCRETE, ITEM NO. 604-10.62 LOCATION AND/OR **EPOXY INJECTION REPAIR** OF 604-10.54, CONCRETE REPAIRS (COMPLETE AND IN PLACE) REPAIR APPROX. REPAIR AREAS APPROX. REPAIR AREAS LEFT BRIDGE (L.F.) (S.F.) BENT 2 55

STATE OF TENNESSEE
DEPARTMENT OF TRANSPORTATION
BENT REPAIRS
BENT 2 - LEFT BRIDGE

BRIDGE NO. 30-SR34-17.25 (L & R) FEDERAL BRIDGE ID NOS. 30FA0343003 & 30FA0343004 BRIDGES OVER SNAPPS FERRY RD. & NFS RAILWAY, LM 17.25

GREENE COUNTY 2025

BR-131-909

PIN NO.:

DESIGN BY:

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SUPERVISED BY:

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SUSANNE DAWSON

SUSANNE DAWSON


DONNIE PICKEL

FRANK BALE

DATE: AUGUST 2021

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DATE: AUGUST 2021

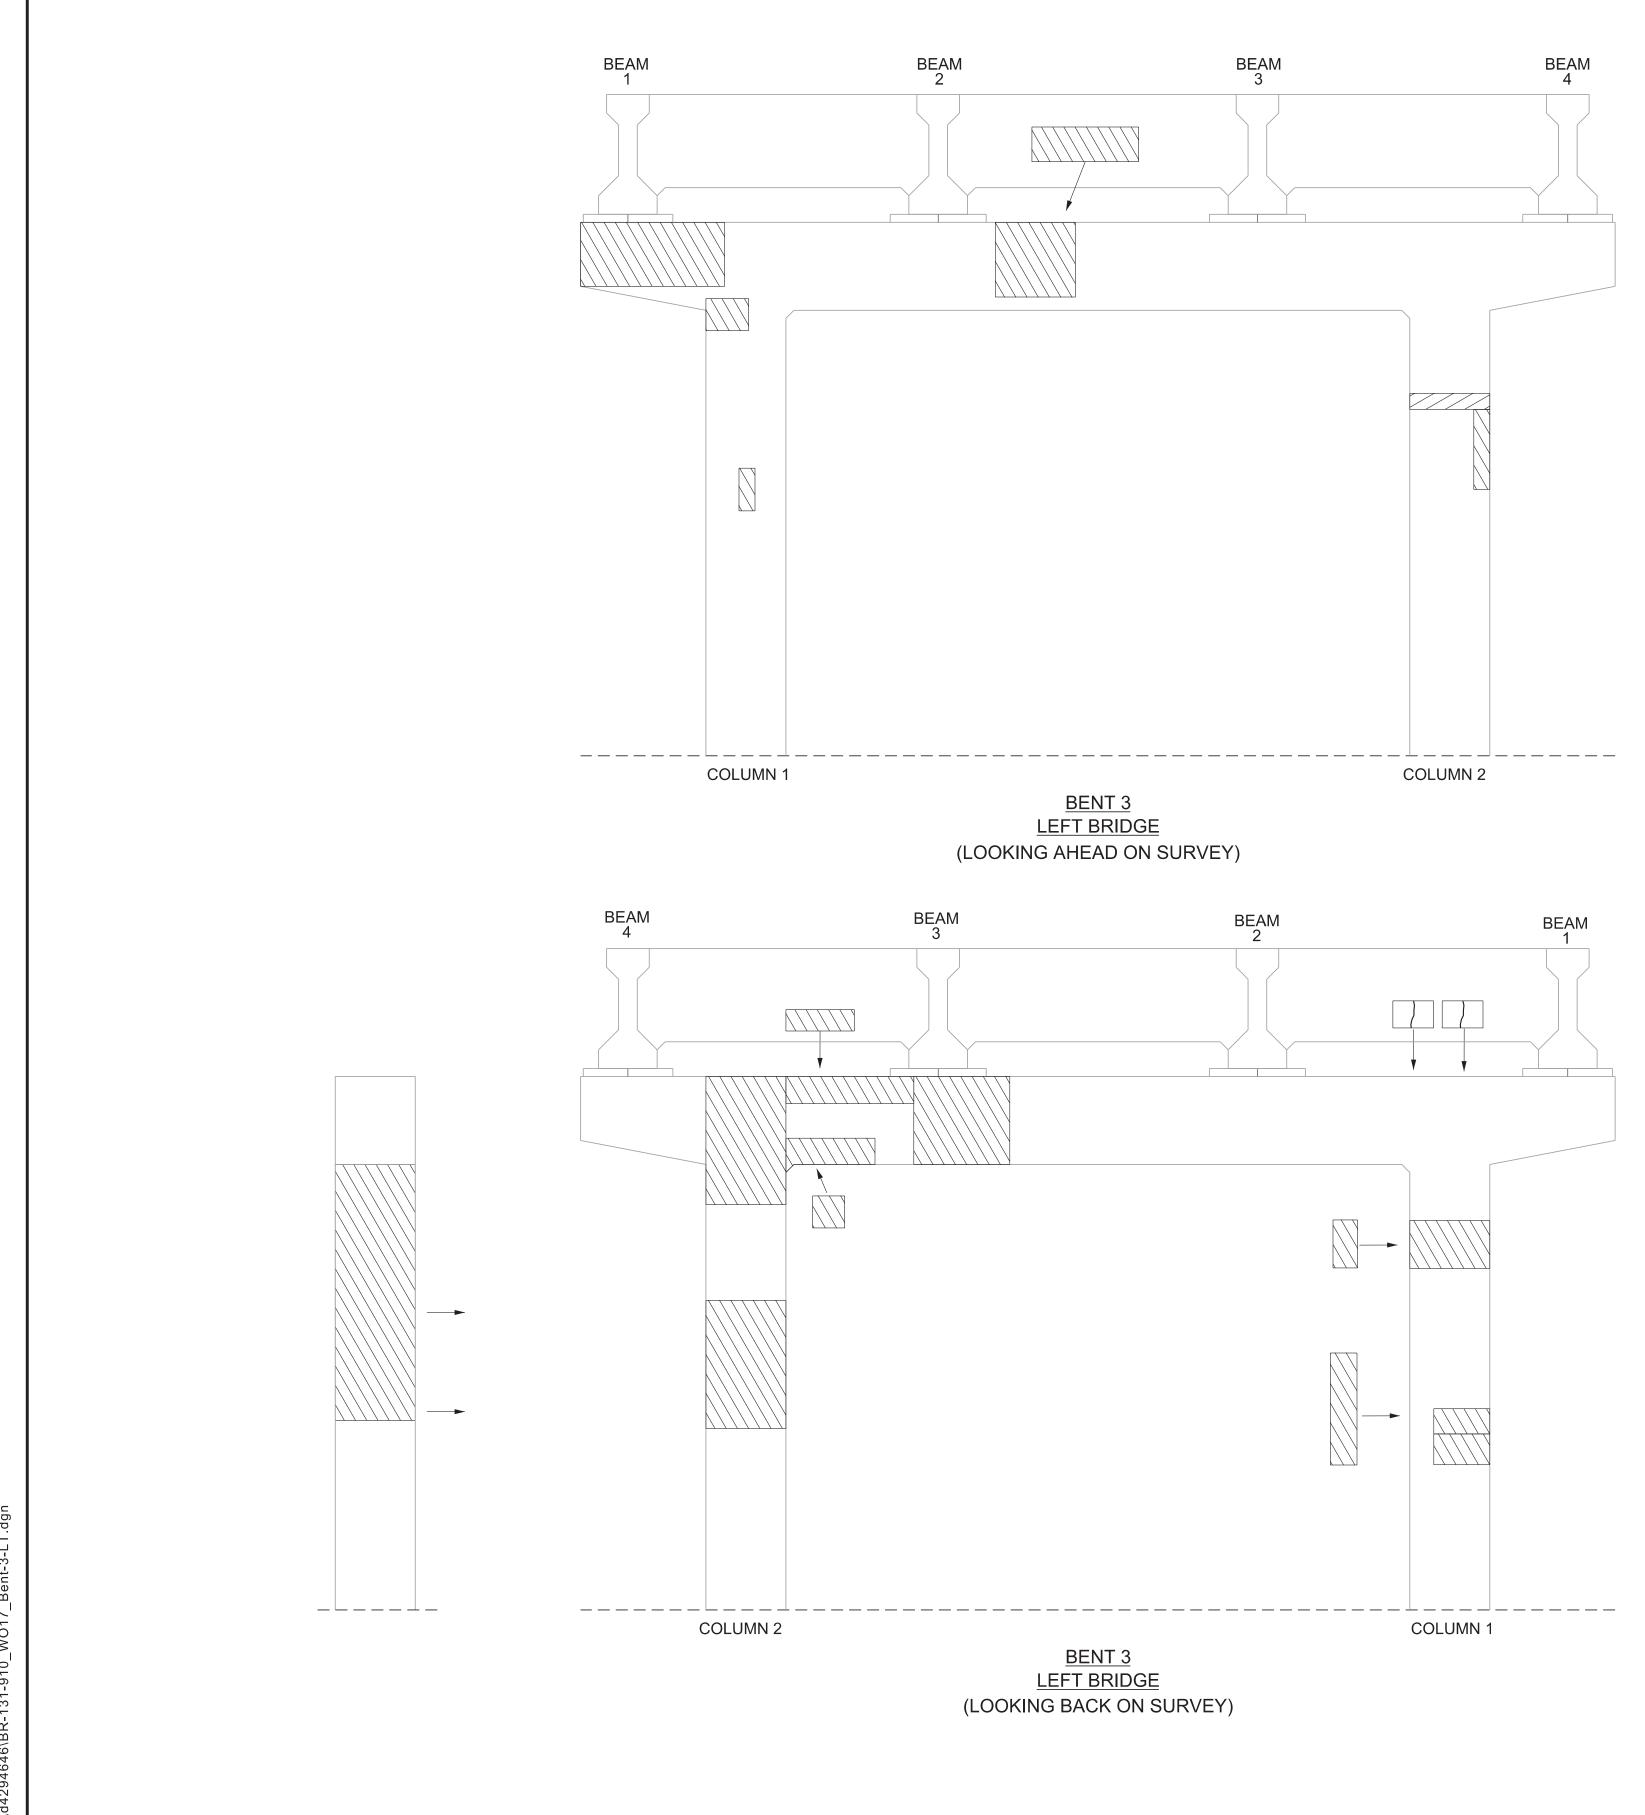


PROJECT NO.	YEAR	SHEET NO.			
30S034-M3-002	2025				
REVISIONS					
IO. DATE BY	BRIEF	DESCRIPTION			
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DENOTES CRACK TO BE EPOXY INJECTED. QUANTITIES AND LOCATIONS SHOWN ARE APPROXIMATE AND MAY BE INCREASED, DECREASED OR ELIMINATED BY THE ENGINEER. SEE EPOXY INJECTION NOTES ON DWG. NO. BR-131-915.

DENOTES AREA TO BE REPAIRED UNDER
ITEM NO. 604-10.05 AND/OR 604-10.54.
SEE REPAIR DETAILS ON DWG. NO. BR-131-915.

THE CONTRACTOR SHALL BE SOLELY RESPONSIBLE FOR THE STABILITY OF THE STRUCTURE DURING REPAIRS.

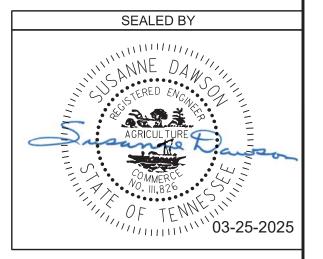

ESTIMATED QUANTITIES ITEM NO. 604-10.05, CONCRETE, ITEM NO. 604-10.62 LOCATION AND/OR **EPOXY INJECTION REPAIR** OF 604-10.54, CONCRETE REPAIRS (COMPLETE AND IN PLACE) REPAIR APPROX. REPAIR AREAS APPROX. REPAIR AREAS (S.F.) (L.F.) LEFT BRIDGE BENT 3 91

STATE OF TENNESSEE
DEPARTMENT OF TRANSPORTATION
BENT REPAIRS
BENT 3 - LEFT BRIDGE

BRIDGE NO. 30-SR34-17.25 (L & R)
FEDERAL BRIDGE ID NOS.
30FA0343003 & 30FA0343004
BRIDGES OVER SNAPPS FERRY RD.
& NFS RAILWAY, LM 17.25
GREENE COUNTY

2025

BR-131-910

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SUSANNE DAWSON

SUSANNE DAWSON


DONNIE PICKEL


FRANK BALE

DATE: AUGUST 2021

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DATE: AUGUST 2021



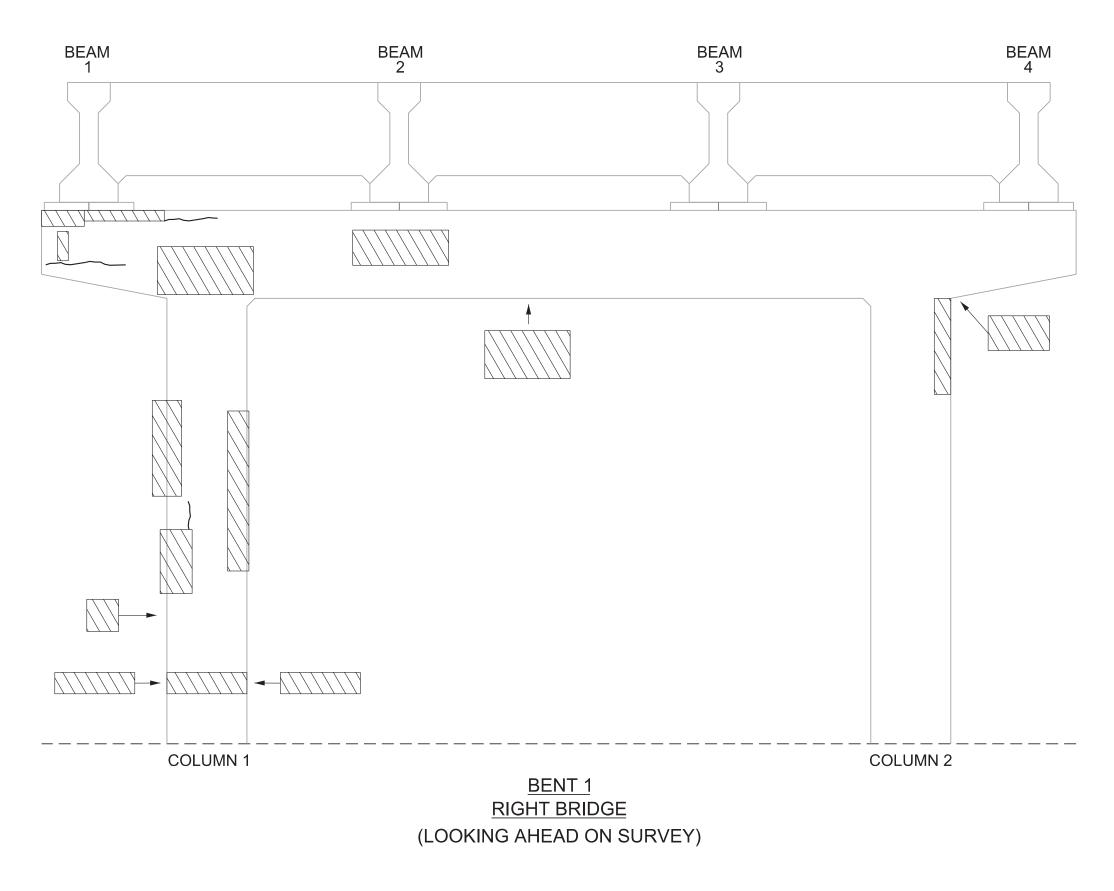
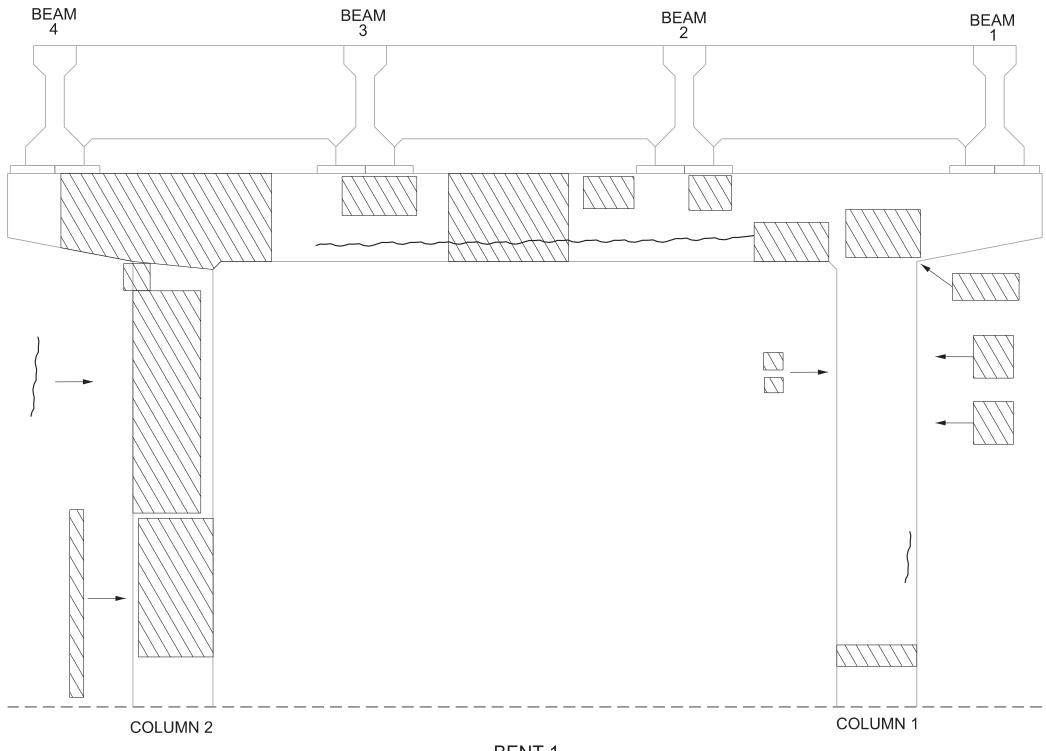
<u>BENT 1</u>
<u>RIGHT BRIDGE</u>
(LOOKING BACK ON SURVEY)


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REVISIONS

NO. DATE BY BRIEF DESCRIPTION

YEAR

SHEET NO.




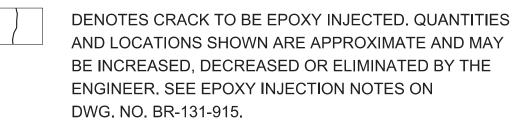

PROJECT NO.

DENOTES AREA TO BE REPAIRED UNDER ITEM NO. 604-10.05 AND/OR 604-10.54.
SEE REPAIR DETAILS ON DWG. NO. BR-131-915.

THE CONTRACTOR SHALL BE SOLELY RESPONSIBLE FOR THE STABILITY OF THE STRUCTURE DURING REPAIRS.

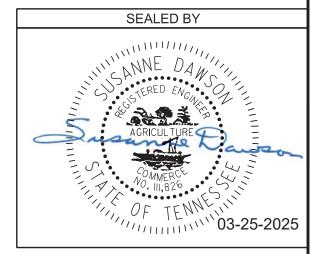

ESTIMATED QUANTITIES				
LOCATION OF REPAIR	ITEM NO. 604-10.05, CONCRETE, AND/OR 604-10.54, CONCRETE REPAIRS	ITEM NO. 604-10.62 EPOXY INJECTION REPAIR (COMPLETE AND IN PLACE)		
RIGHT BRIDGE	APPROX. REPAIR AREAS (S.F.)	APPROX. REPAIR AREAS (L.F.)		
BENT 1	96	22		

STATE OF TENNESSEE
DEPARTMENT OF TRANSPORTATION
BENT REPAIRS
BENT 1 - RIGHT BRIDGE
BRIDGE NO. 30-SR34-17.25 (L & R)

FEDERAL BRIDGE ID NOS.
30FA0343003 & 30FA0343004
BRIDGES OVER SNAPPS FERRY RD.
& NFS RAILWAY, LM 17.25
GREENE COUNTY

2025

BR-131-911

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SUPERVISED BY:

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SUSANNE DAWSON

SUSANNE DAWSON


DONNIE PICKEL


FRANK BALE

DATE: AUGUST 2021

DATE: AUGUST 2021

DATE: AUGUST 2021

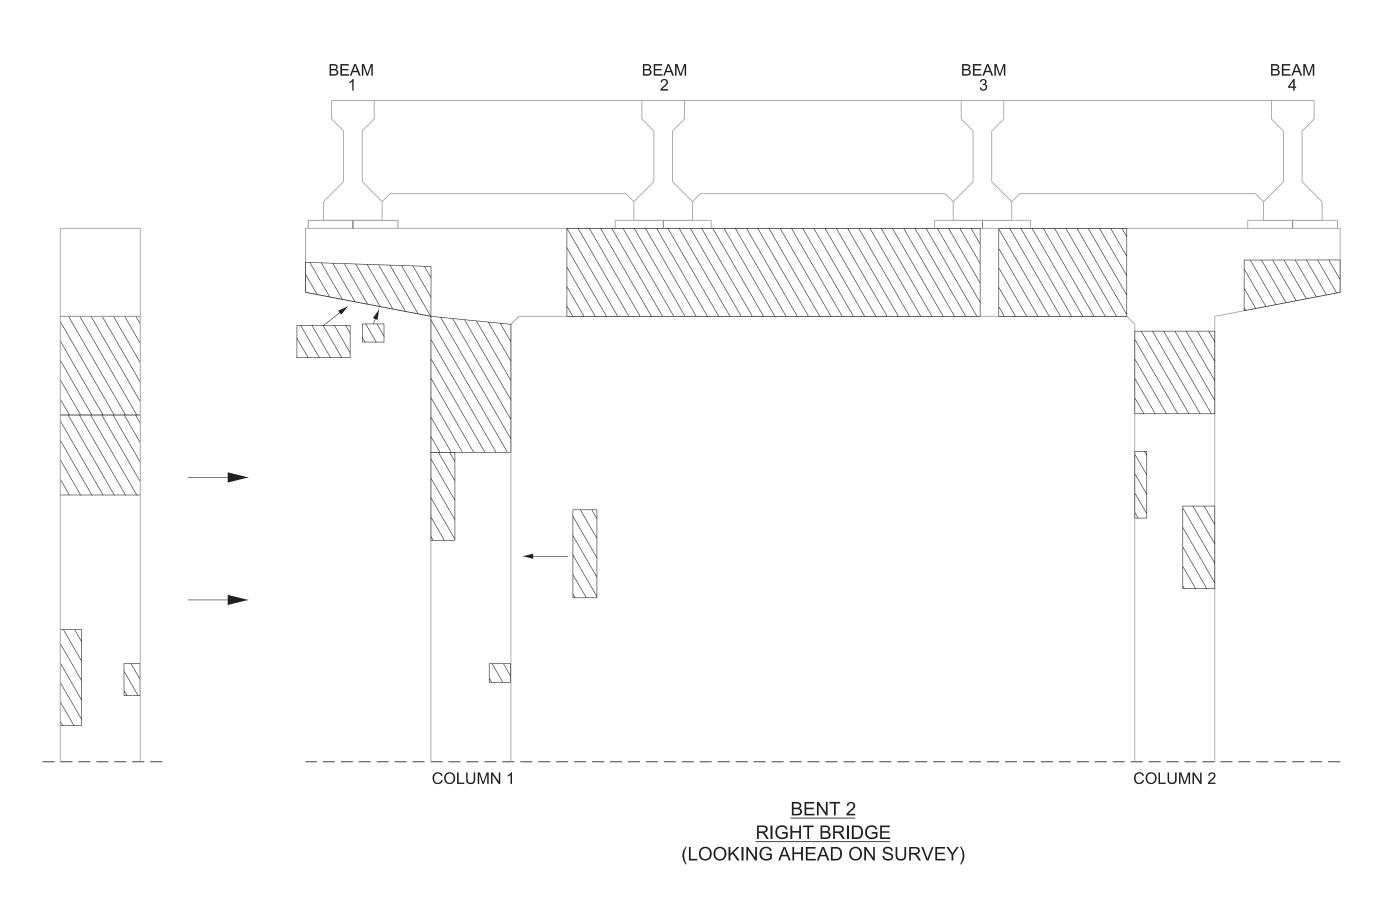

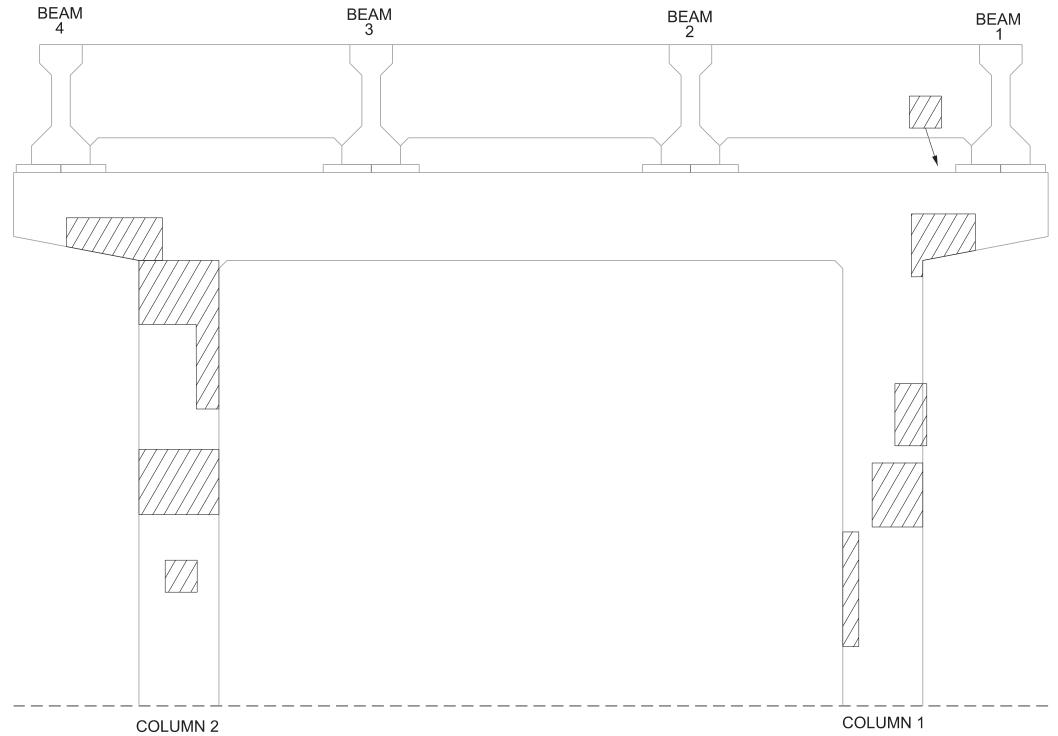

<u>BENT 2</u>
<u>RIGHT BRIDGE</u>
(LOOKING BACK ON SURVEY)

	ESTIMATED QUANTITIES						
LOCATION OF REPAIR	ITEM NO. 604-10.05, CONCRETE, AND/OR 604-10.54, CONCRETE REPAIRS	ITEM NO. 604-10.62 EPOXY INJECTION REPAIR (COMPLETE AND IN PLACE)					
RIGHT BRIDGE	APPROX. REPAIR AREAS (S.F.)	APPROX. REPAIR AREAS (L.F.)					
BENT 2	129	0					

PROJECT NO.			YEAR	SHEET NO.
30S034-M3-002		2025		
			REVISIONS	
NO.	DATE	BY	BRIEF DESCRIPTION	

DENOTES CRACK TO BE EPOXY INJECTED. QUANTITIES
AND LOCATIONS SHOWN ARE APPROXIMATE AND MAY
BE INCREASED, DECREASED OR ELIMINATED BY THE
ENGINEER. SEE EPOXY INJECTION NOTES ON
DWG. NO. BR-131-915.

DENOTES AREA TO BE REPAIRED UNDER ITEM NO. 604-10.05 AND/OR 604-10.54.
SEE REPAIR DETAILS ON DWG. NO. BR-131-915.

THE CONTRACTOR SHALL BE SOLELY RESPONSIBLE FOR THE STABILITY OF THE STRUCTURE DURING REPAIRS.

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STATE OF TENNESSEE
DEPARTMENT OF TRANSPORTATION
BENT REPAIRS
BENT 2 - RIGHT BRIDGE
RIDGE NO. 30-SR34-17.25 (L &

BRIDGE NO. 30-SR34-17.25 (L & R)
FEDERAL BRIDGE ID NOS.
30FA0343003 & 30FA0343004
BRIDGES OVER SNAPPS FERRY RD.
& NFS RAILWAY, LM 17.25

GREENE COUNTY 2025

BR-131-912

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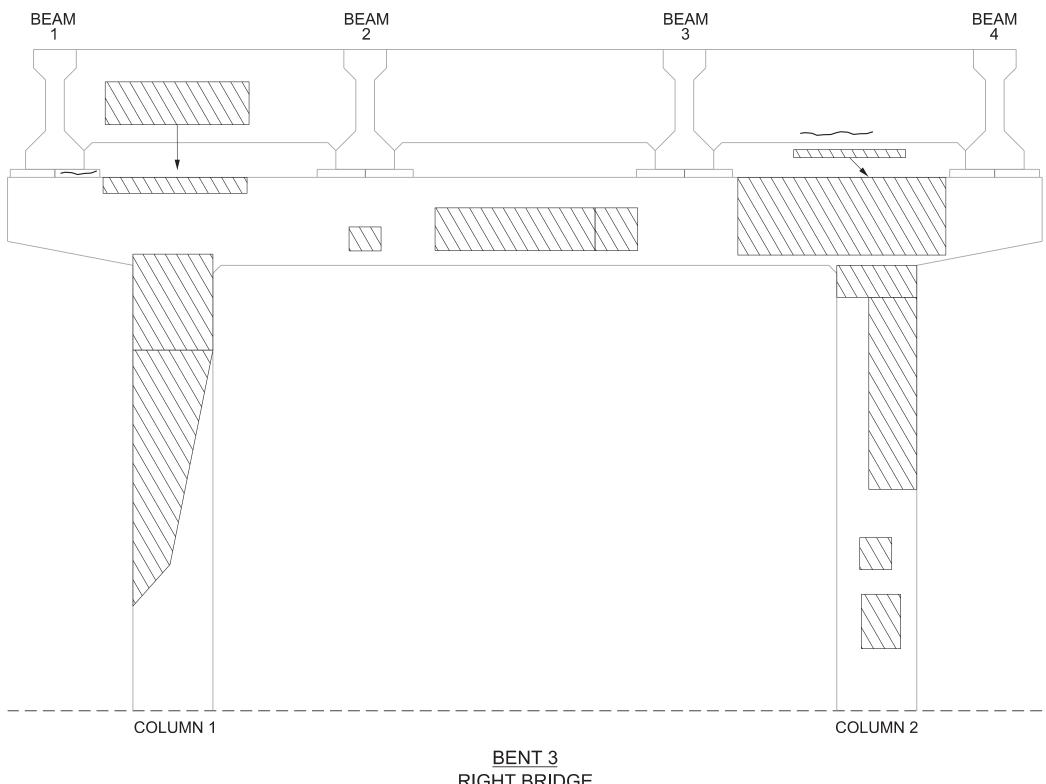
PIN NO.: 082699.01

DESIGN BY: SUSANNE DAWSON DATE: AUGUST 2021


DRAWN BY: DONNIE PICKEL DATE: AUGUST 2021

SUPERVISED BY: SUSANNE DAWSON DATE: AUGUST 2021

CHECKED BY: FRANK BALE DATE: AUGUST 2021




RIGHT BRIDGE (LOOKING AHEAD ON SURVEY)

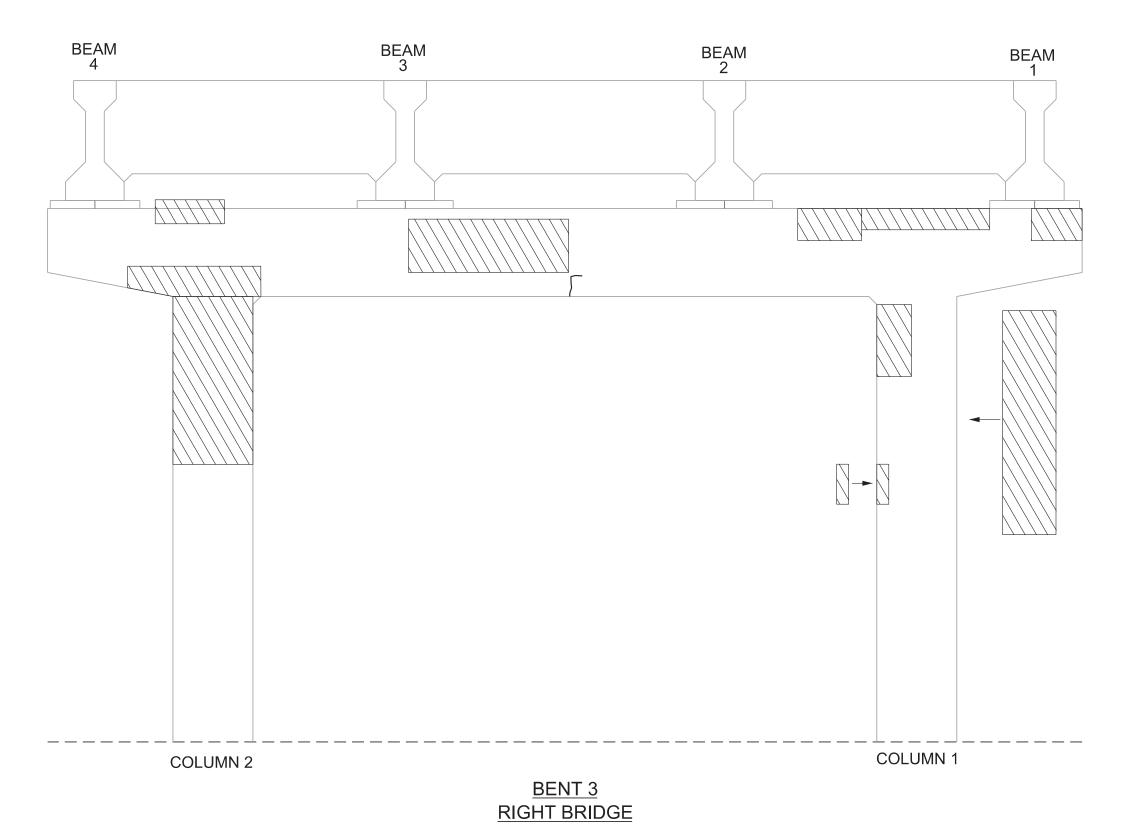

(LOOKING BACK ON SURVEY)

ESTIMATED QUANTITIES						
LOCATION OF REPAIR	ITEM NO. 604-10.05, CONCRETE, AND/OR 604-10.54, CONCRETE REPAIRS	ITEM NO. 604-10.62 EPOXY INJECTION REPAIR (COMPLETE AND IN PLACE)				
	APPROX. REPAIR AREAS	APPROX. REPAIR AREAS				
RIGHT BRIDGE	(S.F.)	(L.F.)				
BENT 3	110	4				


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30	30S034-M3-002		2025	
			REVISIONS	
NO.	DATE	BY	BRIEF	DESCRIPTION

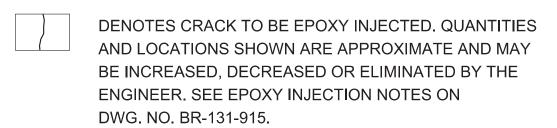



DENOTES AREA TO BE REPAIRED UNDER ITEM NO. 604-10.05 AND/OR 604-10.54. SEE REPAIR DETAILS ON DWG. NO. BR-131-915.

THE CONTRACTOR SHALL BE SOLELY RESPONSIBLE FOR THE STABILITY OF THE STRUCTURE DURING REPAIRS.

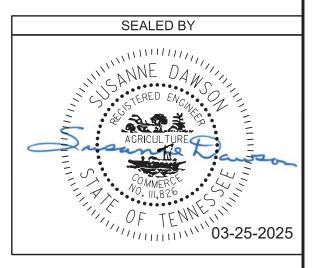

STATE OF TENNESSEE DEPARTMENT OF TRANSPORTATION BENT REPAIRS BENT 3 - RIGHT BRIDGE

BRIDGE NO. 30-SR34-17.25 (L & R) FEDERAL BRIDGE ID NOS. 30FA0343003 & 30FA0343004 BRIDGES OVER SNAPPS FERRY RD. & NFS RAILWAY, LM 17.25

GREENE COUNTY 2025

BR-131-913

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DATE: AUGUST 2021

DATE: AUGUST 2021

DATE: AUGUST 2021

DETAIL SHOWING FULL AND PARTIAL DEPTH DECK REPAIR

CONCRETE FOR FULL AND PARTIAL DEPTH DECK REPAIRS SHALL BE HIGH EARLY STRENGTH CONCRETE WITH A COMPRESSIVE STRENGTH OF 3,500 P.S.I. @ 28 DAYS. TRAFFIC SHALL NOT BE PERMITTED ON ANY REPAIR AREA UNTIL TEST SPECIMENS ATTAIN A COMPRESSIVE STRENGTH OF 3,000 P.S.I. MINIMUM AND THE CONCRETE HAS BEEN IN PLACE A MINIMUM OF TEN (10) DAYS.


REMOVE CONCRETE IN ALL DELAMINATED AREAS TO A DEPTH OF 3/4" BELOW THE TOP BAR OF THE TOP MAT OF THE ORIGINAL SLAB REINFORCING STEEL. ALL REINFORCING STEEL IN AREAS OF DECK REPAIR SHALL BE COMPLETELY CLEANED. AREAS OF CONCRETE REMOVAL SHALL BE DESIGNATED BY PERSONNEL FROM THE BRIDGE REPAIR OFFICE. INSPECTIONS TO DETERMINE AREAS OF DECK REPAIR SHALL BE SCHEDULED WITH THE BRIDGE REPAIR OFFICE AT LEAST THREE (3) DAYS IN ADVANCE.

DECK REPAIR WILL BE PAID FOR UNDER ITEM NO. 604-10.56, CONCRETE OVERLAYED BRIDGE DECK REPAIR (PARTIAL DEPTH), AND ITEM NO.604-10.34, CONCRETE OVERLAYED BRIDGE DECK REPAIR (FULL DEPTH). DURING PARTIAL DEPTH REPAIRS, SHOULD DETERIORATED CONCRETE BE ENCOUNTERED WHICH APPEARS TO RUN FULL DEPTH IN THE SLAB, THE ENGINEER MAY DESIGNATE THESE AREAS TO BE REPAIRED UNDER ITEM NO. 604-10.34. POWER DRIVEN HAND TOOLS USED FOR THE REMOVAL OF UNSOUND CONCRETE IN MAKING PARTIAL AND FULL DEPTH REPAIRS ARE SUBJECT TO THE FOLLOWING RESTRICTIONS:

(PARTIAL DEPTH REPAIRS) PNEUMATIC HAMMERS HEAVIER THAN NOMINAL 60 POUND CLASS SHALL NOT BE USED.
 (FULL DEPTH REPAIRS) PNEUMATIC HAMMERS HEAVIER THAN NOMINAL 90 POUND CLASS SHALL NOT BE USED.
 ALSO ALL DECK REPAIR OVER BEAMS WILL BE RESTRICTED TO 60 POUND PNEUMATIC HAMMERS.
 CHIPPING HAMMERS OF THE 15 POUND CLASS SHALL BE USED TO REMOVE CONCRETE FROM BENEATH ANY REINFORCING STEEL.

ITEM NOS. 604-10.34 AND 604-10.56 MAY BE INCREASED, DECREASED, OR ELIMINATED AS DIRECTED BY THE ENGINEER.

EXTREME CARE SHALL BE TAKEN WHEN REMOVING DETERIORATED CONCRETE SO AS NOT TO DAMAGE THE EXISTING REINFORCING STEEL. ALL EXPOSED REINFORCING STEEL SHALL BE COMPLETELY CLEANED TO THE SATISFACTION OF THE ENGINEER BEFORE REPOURING.

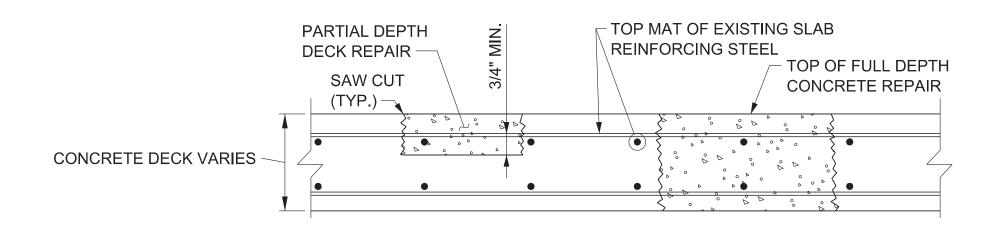

DETAILS SHOWING FULL AND PARTIAL DEPTH DECK REPAIR OVERHANGS OF LEFT AND RIGHT BRIDGES

CONCRETE FOR FULL AND PARTIAL DEPTH DECK REPAIRS SHALL BE HIGH EARLY STRENGTH CONCRETE WITH A COMPRESSIVE STRENGTH OF 3,500 P.S.I. @ 28 DAYS. TRAFFIC SHALL NOT BE PERMITTED ON ANY REPAIR AREA UNTIL TEST SPECIMENS ATTAIN A COMPRESSIVE STRENGTH OF 3,000 P.S.I. MINIMUM AND THE CONCRETE HAS BEEN IN PLACE A MINIMUM OF TEN (10) DAYS.

REMOVE CONCRETE IN ALL DELAMINATED AREAS TO A DEPTH OF 3/4" BELOW THE TOP BAR OF THE TOP MAT OF THE ORIGINAL SLAB REINFORCING STEEL. ALL REINFORCING STEEL IN AREAS OF DECK REPAIR SHALL BE COMPLETELY CLEANED. AREAS OF CONCRETE REMOVAL SHALL BE DESIGNATED BY PERSONNEL FROM THE BRIDGE REPAIR OFFICE. INSPECTIONS TO DETERMINE AREAS OF DECK REPAIR SHALL BE SCHEDULED WITH THE BRIDGE REPAIR OFFICE AT LEAST THREE (3) DAYS IN ADVANCE.


DECK REPAIR WILL BE PAID FOR UNDER ITEM NO. 604-10.50, BRIDGE DECK REPAIRS (PARTIAL DEPTH OF SLAB), AND 604-10.30, BRIDGE DECK REPAIRS (FULL DEPTH OF SLAB). DURING PARTIAL DEPTH REPAIRS, SHOULD DETERIORATED CONCRETE BE ENCOUNTERED WHICH APPEARS TO RUN FULL DEPTH IN THE SLAB, THE ENGINEER MAY DESIGNATE THESE AREAS TO BE REPAIRED UNDER ITEM NO. 604-10.30. POWER DRIVEN HAND TOOLS USED FOR THE REMOVAL OF UNSOUND CONCRETE IN MAKING PARTIAL AND FULL DEPTH REPAIRS ARE SUBJECT TO THE FOLLOWING RESTRICTIONS:

(PARTIAL DEPTH REPAIRS) PNEUMATIC HAMMERS HEAVIER THAN NOMINAL 60 POUND CLASS SHALL NOT BE USED.
 (FULL DEPTH REPAIRS) PNEUMATIC HAMMERS HEAVIER THAN NOMINAL 90 POUND CLASS SHALL NOT BE USED.
 ALSO ALL DECK REPAIR OVER BEAMS WILL BE RESTRICTED TO 60 POUND PNEUMATIC HAMMERS.
 CHIPPING HAMMERS OF THE 15 POUND CLASS SHALL BE USED TO REMOVE CONCRETE FROM BENEATH ANY REINFORCING STEEL.

ITEM NOS. 604-10.30 AND 604-10.50 MAY BE INCREASED, DECREASED, OR ELIMINATED AS DIRECTED BY THE ENGINEER.

EXTREME CARE SHALL BE TAKEN WHEN REMOVING DETERIORATED CONCRETE SO AS NOT TO DAMAGE THE EXISTING REINFORCING STEEL. ALL EXPOSED REINFORCING STEEL SHALL BE COMPLETELY CLEANED TO THE SATISFACTION OF THE ENGINEER BEFORE REPOURING.

PIN NO.:	082699.01	
DESIGN BY:	SUSANNE DAWSON	DATE: AUGUST 2021
DRAWN BY:	DONNIE PICKEL	DATE: AUGUST 2021
SUPERVISED BY:	SUSANNE DAWSON	DATE: AUGUST 2021
CHECKED BY:	FRANK BALE	DATE: AUGUST 2021

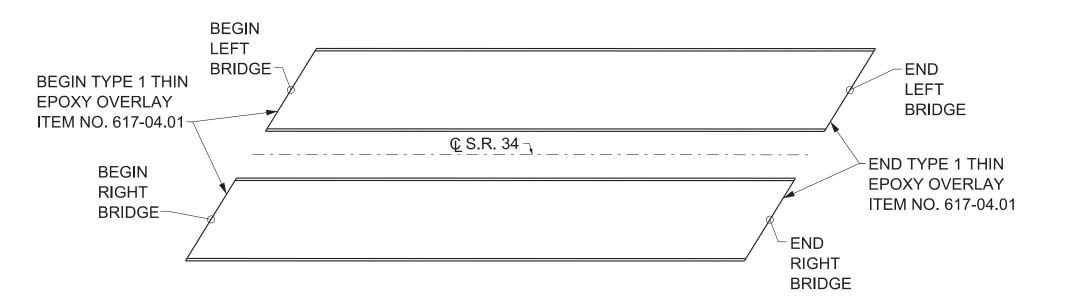

	30S034-M3-002		ILAN	STILLT NO.
30			2025	
			REVISIONS	
NO.	DATE	BY	BRIEF	DESCRIPTION

YFAR

SHEET NO

PROJECT NO

PLAN - THIN EPOXY OVERLAY

THIN EPOXY OVERLAY NOTES

TYPE 1 THIN EPOXY OVERLAY SYSTEM USE DECK PRETREATMENT/PRIMER PER MANUFACTURER'S RECOMMENDATION, AND 2 LIFTS OF AN EPOXY-URETHANE COPOLYMER AND AGGREGATE. TYPE 1 OVERLAY SHALL BE APPLIED MECHANICALLY USING METERED EQUIPMENT; HAND MIXING OF MATERIAL IS NOT PERMITTED. THIN OVERLAY SYSTEM SHALL BE FROM THE QUALIFIED PRODUCTS LIST 23.005 TYPE 1 THIN OVERLAY (EPOXY URETHANE). MINIMUM OVERLAY THICKNESS SHALL BE 3/8 INCH.

APPLICATION EQUIPMENT SHOULD:

- A) BE CAPABLE OF METERING, MIXING AND DISTRIBUTING THE POLYMER AND PRETREATMENT TO MANUFACTURER'S RECOMMENDATION.
- B) USE AN APPLICATION MACHINE THAT FEATURES POSITIVE DISPLACEMENT VOLUMETRIC METERING PUMPS CONTROLLED BY A HYDRAULIC POWER UNIT.
- C) STORE COMPONENTS IN TEMPERATURE CONTROLLED RESERVOIRS CAPABLE OF MAINTAINING 100 DEGREES FAHRENHEIT (PLUS OR MINUS 10 DEGREES) TO INSURE OPTIMAL MIXING.
- D) CHECK MIXING RATIO AT THE PUMP OUTLETS AS WELL AS CYCLE COUNTING CAPABILITIES TO
- MONITOR OUTPUT ON STANDARD FEATURES.

 E) USE MOTIONLESS IN-LINE MIXING SO AS TO NOT OVERLY SHEAR THE MATERIAL TO ENTRAP AIR IN THE MIX.
- F) MAXIMIZE MATERIAL WORKING TIME BY MIXING IT IMMEDIATELY BEFORE DISPENSING.

AGGREGATE SHALL BE ANGULAR, HAVING LESS THAN 0.2% MOISTURE AND FREE OF DIRT, CLAY, ASPHALT AND OTHER FOREIGN OR ORGANIC MATERIALS. AGGREGATE FOR ALL LAYERS SHALL BE BAUXITE OR FLINT ROCK PRODUCTS FLINT AND MEETS THE FOLLOWING GRADATION:

SIEVE SIZE	% PASSING
NO. 6	95-100
NO. 10	10-35
NO. 20	0-3

FULL AND PARTIAL DEPTH DECK REPAIR SHALL CURE A MINIMUM OF 28 DAYS BEFORE THE OVERLAY IS PLACED.

THE 28 DAYS MAY BE WAIVED IF THE OVERLAY MANUFACTURER PROVIDES A METHOD OF TESTING THE REPAIRED AREAS AND APPROVES THE PLACEMENT BY LETTER. TRAFFIC SHALL BE ALLOWED TO USE THE BRIDGE DURING THE CURING PERIOD OF THE PATCHES BUT NOT AFTER SHOTBLASTING. MAGNESIUM PHOSPHATE BASED MATERIALS WILL NOT BE ALLOWED.

THE CONCRETE DECK SURFACE SHALL BE CLEANED BY SHOTBLASTING TO REMOVE ANY OIL, DIRT, RUBBER, TRAFFIC STRIPING, OR ANY OTHER POTENTIAL DETRIMENTAL MATERIAL SUCH AS CURING COMPOUND AND LAITANCES, WHICH THE MANUFACTURER AND ENGINEER'S OPINION WOULD PREVENT PROPER BONDING AND CURING OF THE MATERIAL. IN AREAS WHERE SHOTBLASTING EQUIPMENT CAN NOT REACH (I.E., ALONG CURBS AND BRIDGE RAILS) SANDBLASTING IS PERMITTED TO AN EXTENT TO THE ENGINEER'S AND MANUFACTURER'S APPROVAL. IMMEDIATELY BEFORE APPLICATION, ALL PREPARED SURFACES SHALL BE CLEANED WITH COMPRESSED AIR OR VACUUMED TO REMOVE DUST AND DEBRIS. THE CONTRACTOR IS TO PREVENT THE TRACKING OF TACK COAT AND CONSTRUCTION DEBRIS ACROSS THE BRIDGE DECK PRIOR TO APPLICATION OF THE THIN EPOXY OVERLAY. MILLING THE BRIDGE DECK WILL NOT BE AN OPTION FOR TACK COAT OR DEBRIS REMOVAL. REMOVAL SHALL BE AT THE CONTRACTOR'S EXPENSE.

ALL SURFACES THAT ARE TREATED SHALL BE DRY AT THE TIME OF APPLICATION. THE OVERLAY SHALL NOT BE APPLIED WHEN IT HAS RAINED 24 HOURS PRIOR TO, OR RAIN IS FORECAST WITHIN 8 HOURS AFTER, APPLICATION. THE MOISTURE CONTENT IN THE DECK SUBSTRATE SHALL BE TESTED. MOISTURE IS NOT TO EXCEED 4.5 PERCENT WHEN MEASURED BY ELECTRONIC METER. IF THE TEST SHOWS EXCESS MOISTURE, THE DECK SHALL CONTINUE TO DRY BEFORE APPLICATION PROCEEDS.

BLUSHING (A WAXY SURFACE COATING ON THE EPOXY) IS CAUSED BY THE REACTION OF MOISTURE WITH THE HARDENING AGENT. BLUSHING CREATES A SURFACE THAT MAKES FUTURE LAYERS DIFFICULT TO ADHERE. LIFTS THAT SHOW SIGNS OF BLUSHING SHALL BE REMOVED AND REPLACED PRIOR TO APPLICATION OF THE NEXT. THE COST TO REMOVE AND REPLACE THESE AREAS SHALL BE AT THE CONTRACTOR'S EXPENSE.


TRAFFIC, OTHER THAN APPLICATION EQUIPMENT, SHALL NOT BE ALLOWED ON ANY PORTION OF THE DECK THAT HAS BEEN SHOTBLASTED OR WHERE PART OF THE APPLICATION HAS BEEN PLACED.

SEE MANUFACTURER'S RECOMMENDATIONS FOR REQUIRED AMBIENT AND SURFACE TEMPERATURES AND HUMIDITY LIMITS FOR APPLICATION.

THE MANUFACTURER SHALL HAVE A REPRESENTATIVE ON THE JOB SITE AT ALL TIMES DURING APPLICATION AND CURE TIME. THE REPRESENTATIVE, ALONG WITH CONSULTATION WITH ENGINEER, MAY SUSPEND ANY ITEM OF WORK THAT IS SUSPECT AND DOES NOT MEET THE REQUIREMENTS OF THE SPECIFICATIONS. WORK SHALL NOT RESUME UNTIL THE ENGINEER AND REPRESENTATIVE ARE SATISFIED THAT APPROPRIATE REMEDIAL ACTION HAS BEEN TAKEN BY THE CONTRACTOR.

ALL COSTS FOR AGGREGATE, EPOXY FOR MINIMUM OF TWO LIFTS, SURFACE PREPARATION, LABOR AND ANY OTHER MISCELLANEOUS MATERIALS REQUIRED TO PLACE THIN OVERLAY SHALL BE INCLUDED IN ITEM NO. 617-04.01, TYPE 1 THIN EPOXY OVERLAY (EPOXY URETHANE), SY.

THICKNESS VERIFICATION: THE PROJECT ENGINEER SHALL BE NOTIFIED OF THE NUMBER OF GALLONS USED ON THE PROJECT WITH NOTARIZED QUANTITY STATEMENTS FROM THE CONTRACTOR AND THE MANUFACTURER. THE CONTRACTOR SHALL VERIFY TO TDOT THAT THE OVERLAY IS AN AVERAGE OF AT LEAST 3/8 INCH THICK AT THREE RANDOM LOCATIONS AGREED UPON BY THE PROJECT ENGINEER AND THE MATERIAL MANUFACTURER REPRESENTATIVE. IF 3/8 INCH AVERAGE IN NOT ACHIEVED, A RETEST SHALL BE PERFORMED IN ADJOINING AREAS. THIN AREAS SHALL BE RE-COATED AS DESCRIBED ABOVE BY THE CONTRACTOR AND RE-VERIFIED AT NO ADDITIONAL COST TO TDOT. THIS VERIFICATION MAY CONSIST OF CORES, HOLES, ETC., BUT IN ALL CASES, ANY DESTRUCTIVELY TESTED AREAS SHALL BE REPAIRED BY THE CONTRACTOR BEFORE FINAL ACCEPTANCE BY THE PROJECT ENGINEER.

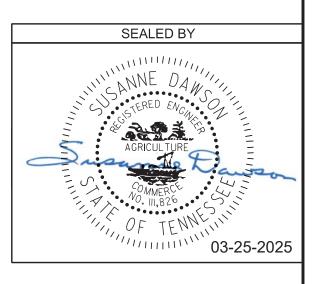

STATE OF TENNESSEE DEPARTMENT OF TRANSPORTATION

REPAIR DETAILS

BRIDGE NO. 30-SR34-17.25 (L & R)
FEDERAL BRIDGE ID NOS.
30FA0343003 & 30FA0343004
BRIDGES OVER SNAPPS FERRY RD.
& NFS RAILWAY, LM 17.25
GREENE COUNTY

2025

BR-131-914

DESIGNATED CRACKS SHALL BE INJECTED WITH AN APPROVED EPOXY RESIN ADHESIVE FILLING ALL VOIDS FOR THE CRACK DEPTH OR THICKNESS OF THE MEMBER. THE EPOXY RESIN ADHESIVE SHALL BE ON THE CURRENT QUALIFIED PRODUCTS LIST MAINTAINED BY THE DIVISION OF MATERIALS AND TEST. ALL CRACKS SHALL BE INJECTED USING AN ADHESIVE SUITABLE FOR THE FIELD CONDITIONS (CRACK WIDTH, TEMPERATURE, HUMIDITY, ETC.) RECOMMENDED BY THE ADHESIVE MANUFACTURER AS SHOWN ON MATERIAL DATA SHEETS. FOLLOWING INJECTION, ALL INJECTION PORTS AND CAPPING MATERIAL SHALL BE REMOVED FROM EXPOSED SURFACES LEAVING THE SURFACE SMOOTH AND FLUSH WITH THE SURROUNDING CONCRETE SURFACES.

THE CONTRACTOR SHALL HAVE SUFFICIENT EXPERIENCE AND TRAINING TO PERFORM THE EPOXY INJECTION IN ACCORDANCE WITH THESE PLANS. PRIOR TO PERFORMING ANY WORK, THE CONTRACTOR SHALL SUBMIT TO THE ENGINEER A WRITTEN PROCEDURE FOR PERFORMING THE EPOXY INJECTION. THE PROCEDURE SHALL DESCRIBE IN DETAIL HOW THE WORK WILL BE PERFORMED. THE PROCEDURE SHALL INCLUDE, BUT NOT BE LIMITED TO THE FOLLOWING INFORMATION.

1) DESCRIPTION OF EQUIPMENT.

- A. THE INJECTION EQUIPMENT SHALL BE OF THE TYPE THAT MIXES ADHESIVE COMPONENTS
- AT THE INJECTION HEAD.
- B. THE INJECTION EQUIPMENT SHALL BE CAPABLE OF DISCHARGING MIXED ADHESIVE AT ANY PRESSURE UP TO 300 PSI. THE INJECTION EQUIPMENT SHALL BE EQUIPPED WITH GAUGES WHICH CAN MEASURE THE INJECTION PRESSURE AND VOLUME.
- 2) EQUIPMENT CALIBRATION PROCEDURES AND SCHEDULE.
- 3) MATERIALS TO BE USED (INCLUDING MANUFACTURER DATA SHEETS)
- A. CAPPING MATERIAL
- B. EPOXY ADHESIVE (TYPE TO BE APPROPRIATE FOR CRACK SIZES TO BE INJECTED).
- 4) PORT SPACING
- A. PORT SPACING SHALL NOT BE LESS THAN THE THICKNESS OF THE CONCRETE IN THAT LOCATION.
- 5) INJECTION SEQUENCE
- A. INJECTION SHALL PROCEED FROM LOWER END OF CRACK ALONG ADJACENT PARTS.
- B. SKIPPING OF PORTS DURING INJECTION SHALL NOT BE ALLOWED.

THE CONTRACTOR SHALL HAVE THE MANUFACTURER'S INSTRUCTIONS FOR PROPORTIONING AND MIXING AVAILABLE AT THE JOB SITE AT ALL TIMES AND SHALL ENSURE THAT THE EQUIPMENT IS SUPPLYING THE MIXED ADHESIVE IN THE CORRECT PROPORTIONS.

TO ENSURE PROPER MIXING AND PROPORTIONING, SAMPLES SHALL BE TAKEN FROM THE INJECTOR HEAD AT THE START OF EACH WORKDAY AND EACH TIME THE ADHESIVE RESERVOIRS ARE REFILLED. THE SAMPLES SHALL BE IN A TEST CUP. THE SAMPLE SHALL BE MONITORED TO ENSURE THAT THE CURE TIME IS IN COMPLIANCE WITH THE MANUFACTURER'S DATA SHEETS. IF THE SAMPLES DO NOT CURE IN THE SPECIFIED TIME THEN THE EQUIPMENT USED TO PRODUCE THE SAMPLE SHALL NOT BE USED UNTIL THE PROBLEM IS CORRECTED.

CORE SAMPLES SHALL BE TAKEN AS VERIFICATION OF THE QUALITY OF WORK. THE CONTRACTOR SHALL TAKE ONE (1) ONE (1) INCH DIAMETER (FULL DEPTH OF CONCRETE AT LOCATION CORED) CORE SAMPLES STARTING WITH THE FIRST REPAIR LOCATION THEN EVERY THIRD REPAIR LOCATION AFTERWARDS. WORK SHALL NOT PROCEED UNTIL THE CORE SAMPLE IS TAKEN AND ACCEPTED. ALL CORE SAMPLES AND HOLES SHALL BE INDEXED FOR FUTURE REFERENCE. THE ENGINEER SHALL DESIGNATE ALL LOCATIONS TO BE CORED. IF ANY CORES SHOW UNACCEPTABLE RESULTS, ALL WORK SHALL BE STOPPED UNTIL THE CONTRACTOR SUBMITS A PROPOSAL FOR CORRECTING UNACCEPTABLE WORK.

THE INITIAL CORE WILL ALSO SERVE TO QUALIFY THE FOREMAN FOR THIS WORK. IF AT ANY TIME A NEW FOREMAN IS USED, HE SHALL BE QUALIFIED WITH A CORE SAMPLE.

THE CONTRACTOR, AT HIS EXPENSE, SHALL REPAIR ALL CORE HOLES WITH AN APPROVED CEMENTITIOUS PATCHING MATERIAL.

CORE SAMPLES SHALL BE VISUALLY INSPECTED TO CONFIRM THAT CRACKS ARE COMPLETELY FILLED WITH ADHESIVE. ANY CORE HAVING LESS THAN 95% OF THEM CRACK FILLED WITH ADHESIVE SHALL BE CONSIDERED UNACCEPTABLE AND BE REJECTED.

CORE SAMPLES SHALL BE TESTED FOR BOND STRENGTH. SAMPLES MAY BE FRACTURED BY HAMMER BLOW TO CRACK AREA OR THROWN AT A HARD SURFACE. IF ADHESIVE FAILURE OCCURS BEFORE CONCRETE FAILURE, THE CORE SHALL BE CONSIDERED UNACCEPTABLE AND REJECTED.

PAYMENT FOR EPOXY INJECTION CRACK REPAIR SHALL BE MADE UNDER ITEM NUMBERS 604-10.62, EPOXY INJECTION REPAIR (COMPLETE AND IN PLACE), L.F. AND 604-10.58, EPOXY INJECTION (INJECTION), GAL.


PRICE BID FOR ITEM NUMBER 604-10.62, EPOXY INJECTION REPAIR (COMPLETE AND IN PLACE), L.F. SHALL INCLUDE COST OF ALL LABOR AND MATERIALS (EXCEPT ADHESIVE) FOR GRINDING FOR SURFACE PREPARATION, CRACK PREPARATION, CAPPING, INJECTION OF ADHESIVE, ALL SAMPLES AND TESTING, REMOVAL OF CAPPING MATERIAL AND PORTS, AND OTHER INCIDENTALS. CRACKS SHALL BE MEASURED FOR PAYMENT ALONG THE LENGTH OF THE VISIBLE SURFACE CRACK.

PRICE BID FOR ITEM 604-10.58, EPOXY INJECTION (INJECTION), GAL., SHALL INCLUDE COST FOR ADHESIVE MATERIAL INJECTED ONLY.

NO PAYMENT SHALL BE MADE FOR REWORK DEEMED NECESSARY BY FAILURE OF ADHESIVE SAMPLES OR CORE SAMPLES.

ALL WORK INCLUDING SAMPLING AND TESTING SHALL BE IN THE PRESENCE OF THE ENGINEER OR HIS REPRESENTATIVE OR CONTRACT INSPECTORS. ANY WORK DONE WITHOUT INSPECTORS PRESENT SHALL NOT BE PAID FOR. THE CONTRACTOR SHALL PROVIDE THE ENGINEER WITH WEEKLY SCHEDULES OF WORK TO BE PERFORMED. SCHEDULES SHALL BE SUBMITTED AT LEAST THREE (3) DAYS IN ADVANCE OF WORK TO BE DONE. THE ENGINEER SHALL BE NOTIFIED OF ANY CHANGE IN THE SCHEDULE A MINIMUM OF TWENTY -FOUR (24) HOURS IN ADVANCE OF CHANGE.

PIN NO.:	082699.01	
DESIGN BY:	SUSANNE DAWSON	DATE: AUGUST 2021
DRAWN BY:	DONNIE PICKEL	DATE: AUGUST 2021
SUPERVISED BY:	SUSANNE DAWSON	DATE: AUGUST 2021
CHECKED BY:	FRANK BALE	DATE: AUGUST 2021

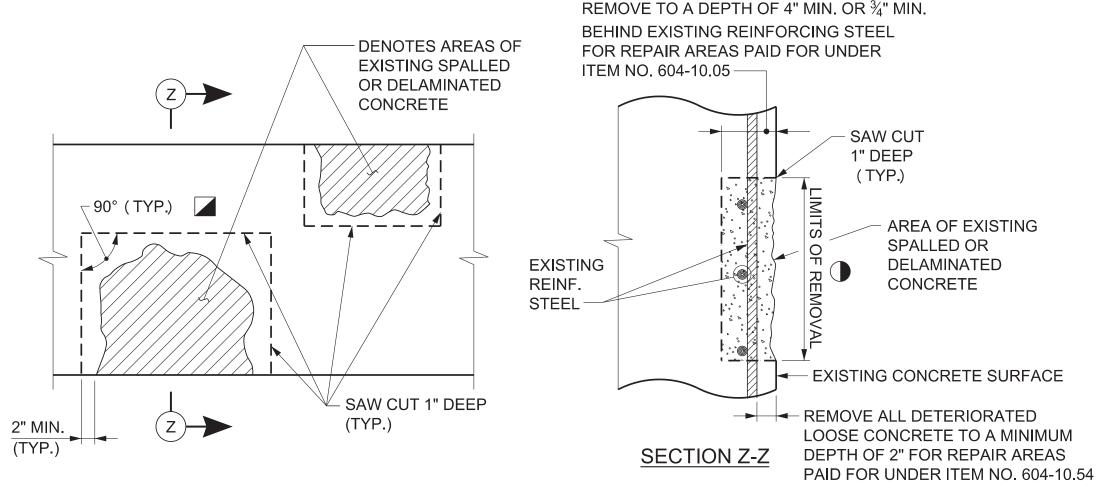

DETAILS SHOWING AREAS OF EXISTING SPALLED OR DELAMINATED CONCRETE SURFACES TO BE REMOVED AND REPAIRED

- DENOTES LIMITS AND LOCATION OF REPAIRS TO BE DESIGNATED BY THE ENGINEER

☐ - DENOTES SAW CUT EXISTING CONCRETE SURFACES SO AS TO OBTAIN SQUARED CORNERS

NOTES

EXTREME CARE SHALL BE TAKEN WHEN REMOVING THE EXISTING SPALLED OR DELAMINATED CONCRETE SO AS NOT TO DAMAGE THE EXISTING REINFORCING STEEL. ALL EXPOSED EXISTING REINFORCING STEEL SHALL RECEIVE A COMPLETE CLEANING TO REMOVE ALL RUST. ALL EXISTING REINFORCEMENT SHALL REMAIN IN PLACE AND I NCORPORATED INTO THE NEW CONSTRUCTION. ALL WORK MUST MEET WITH THE FULL APPROVAL OF THE ENGINEER.

THE ENGINEER SHALL HAVE THE OPTION OF DESIGNATING A SPALLED OR DELAMINATED AREA TO BE REPAIRED UNDER ITEM NO. 604-10.05 OR 604-10.54. PATCHING MATERIAL FOR ITEM NO. 604-10.05 SHALL BE HIGH EARLY STRENGTH CONCRETE. PATCHING MATERIAL FOR ITEM NO. 604-10.54 SHALL BE A POLYMER MODIFIED CEMENTITIOUS STRUCTURAL PATCHING MATERIAL. SEE TDOT QUALIFIED PRODUCTS LIST 13, SECTION B, MATERIAL QPL 13.009.

PNEUMATICALLY PLACED CONCRETE IS NOT ALLOWED.


ANY REINFORCING IN THE REPAIR AREA SHOWING MORE THAN 20 PERCENT SECTION LOSS SHALL BE REPLACED.

COST OF SAW CUTTING, REMOVING SPALLED OR DELAMINATED CONCRETE, CLEANING, PATCHING MATERIAL, LABOR AND ANY MISCELLANEOUS MATERIALS NECESSARY TO COMPLETE THE REPAIRS AS SHOWN TO BE INCLUDED IN ITEM NO. 604-10.54, CONCRETE REPAIRS, S.F. OR ITEM NO. 604-10.05, CONCRETE, S.F.

THE ENGINEER SHALL DESIGNATE ALL SPALLED OR DELAMINATED CONCRETE REPAIR AREAS IN THE FIELD. QUANTITIES GIVEN ARE APPROXIMATE. ITEM NO. 604-10.05 AND 604-10.54 MAY BE INCREASED, DECREASED OR ELIMINATED AS DIRECTED BY THE ENGINEER.

POWER HAND DRIVEN TOOLS USED FOR REMOVAL OF UNSOUND CONCRETE ARE SUBJECT TO THE FOLLOWING RESTRICTIONS:

- 1. PNEUMATIC HAMMERS HEAVIER THAN THE 35 LB. CLASS SHALL NOT BE USED.
- 2. CHIPPING HAMMERS OF THE 15 LB. CLASS SHALL BE USED TO REMOVE CONCRETE FROM BEHIND REINFORCING STEEL.

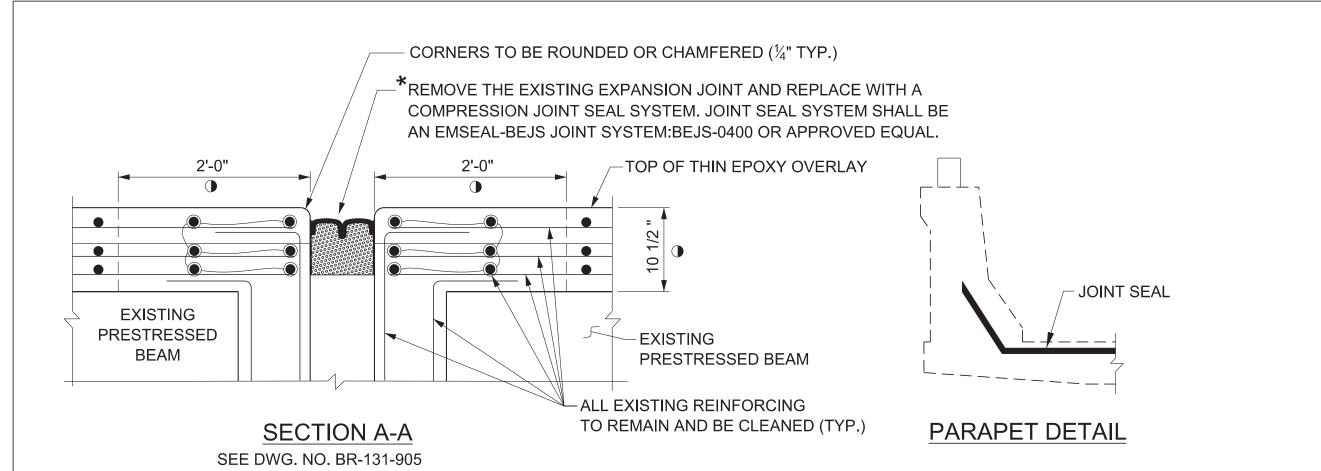

● LIMITS OF REMOVAL AND REPOURING

EXPANSION JOINT REPLACEMENT DETAILS

* THE JOINT SYSTEM SHALL BE INSTALLED UNDER THE DIRECT SUPERVISION OF AN AUTHORIZED TECHNICIAN PROVIDED BY THE EXPANSION JOINT SUPPLIER FOR EACH JOINT IN THE BRIDGE. THE TECHNICIAN MUST APPROVE ALL ASPECTS OF THE GEOMETRY AND PREPARATION, INCLUDING GRINDING AND/OR GROOVING, PRIOR TO ANY JOINT MATERIAL INSTALLATION. THE JOINT SEAL MUST BE CONTINUOUS WITH NO FIELD SPLICES AND NO FIELD CUTTING.

COST OF REMOVAL OF THE EXISTING CONCRETE, PLATES, ANGLES, ANCHORS, CLEANING AND MAINTAINING THE EXISTING REINFORCING IN THE EXPANSION JOINT REPAIR AREAS, HIGH EARLY STRENGTH CONCRETE, FORMING, AND ALL MISCELLANEOUS MATERIALS AND LABOR NECESSARY TO INSTALL THE NEW COMPRESSION JOINT SEAL SYSTEM COMPLETE AND IN PLACE TO BE PAID FOR IN THE PRICE BID FOR ITEM NO. 604-10.44. EXPANSION JOINT REPAIRS.

TABLE OF JOINT WIDTHS			
POURING	EXPANSION JOINT WIDTH		
TEMP.	BENT 1 LT	BENT 1 RT	
40° F	2¾"	23/8"	
50° F	21/8"	21/8"	
60° F	2"	2"	
70° F	1%"	1%"	
80° F	1%"	1%"	
90° F	1½"	1½"	

PROJECT NO. 30S034-M3-002 NO. DATE BY		YEAR	SHEET NO.	
		2025		
		REVISIONS		
		BRIEF DESCRIPTION		

SEALED BY

AGRICUL TURE

AGRICUL TURE

OF TENNING

03-25-2025

STATE OF TENNESSEE
DEPARTMENT OF TRANSPORTATION


CONCRETE REPAIR DETAILS


BRIDGE NO. 30-SR34-17.25 (L & R)
FEDERAL BRIDGE ID NOS.
30FA0343003 & 30FA0343004

BRIDGES OVER SNAPPS FERRY RD.
& NFS RAILWAY, LM 17.25
GREENE COUNTY

2025

BR-131-915

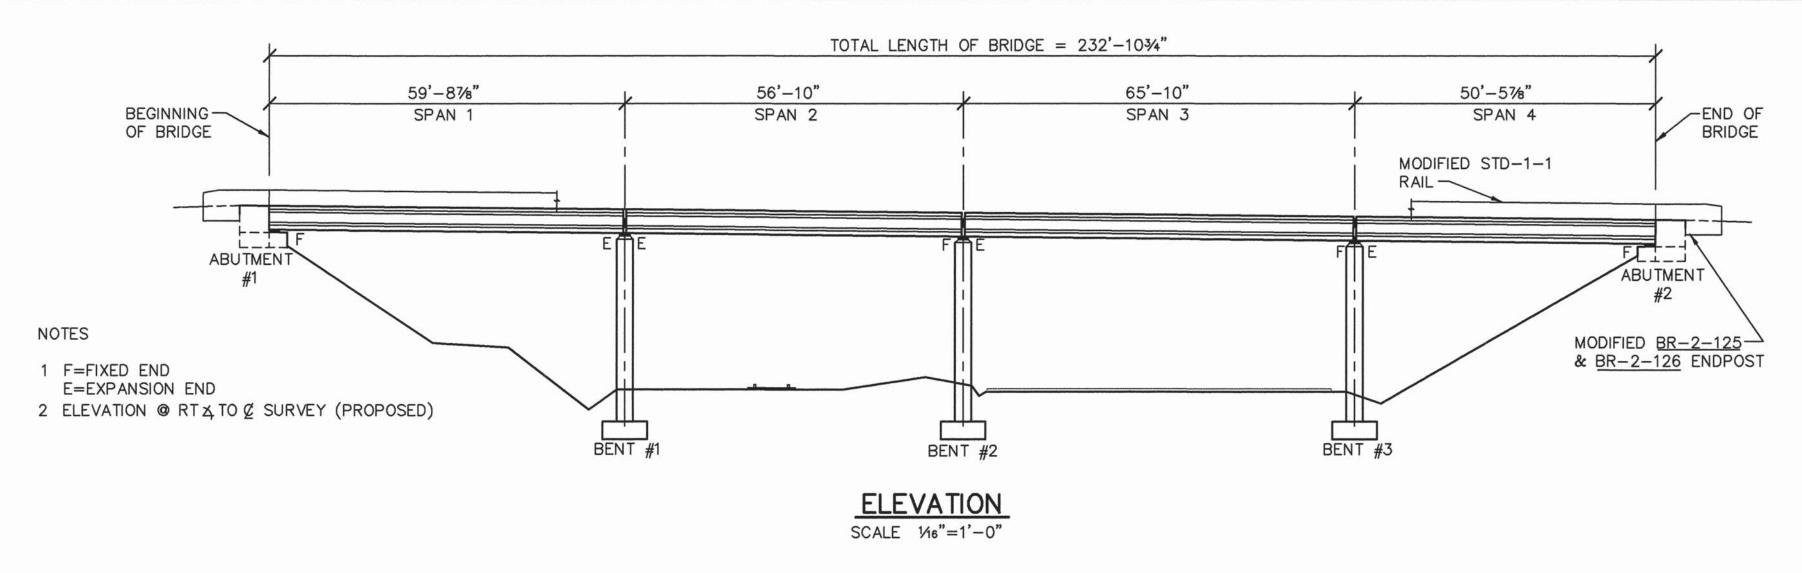

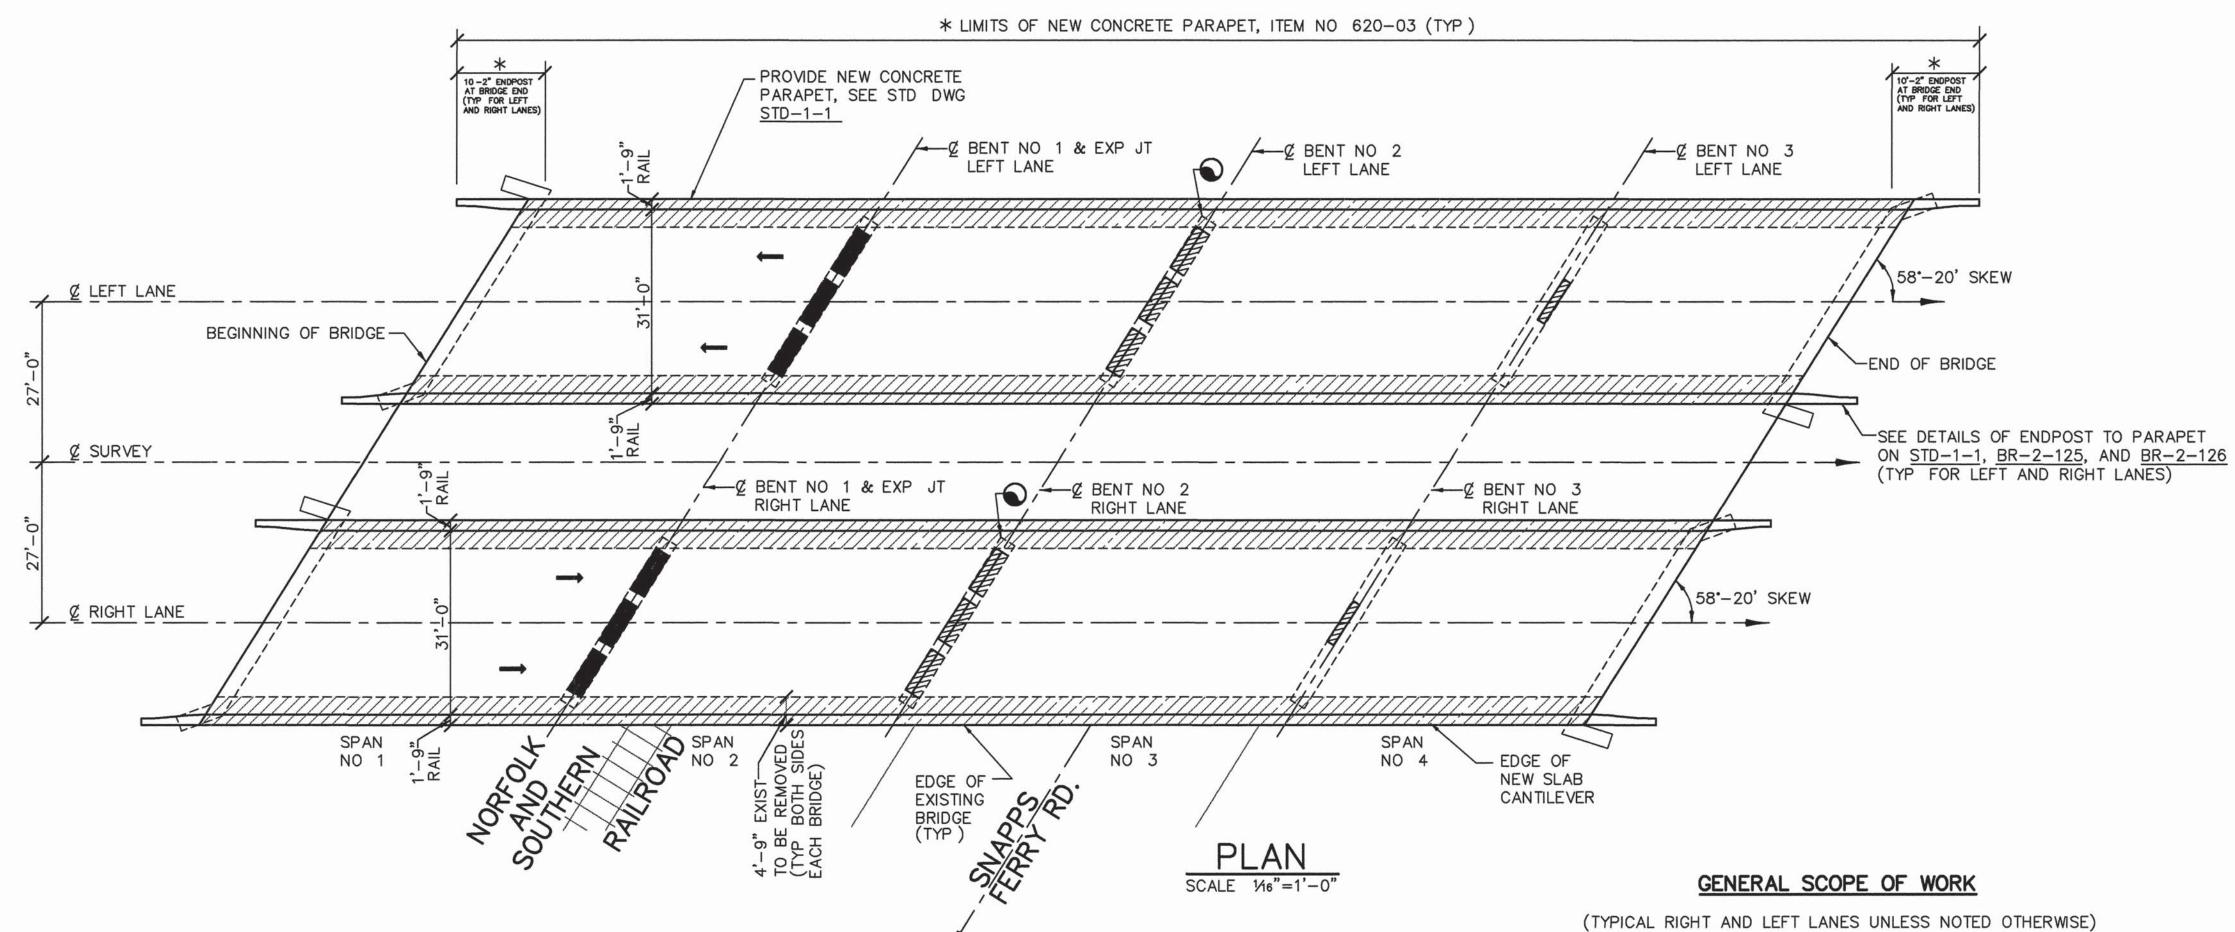

REPAIR LEGEND

LOCATIONS OF BENT CAP END REPAIR (2 LOCATIONS), SEE DETAILS AND NOTES ON DRAWING BR-16-79

LOCATIONS OF DIAPHRAGMS TO BE REMOVED AND REPLACED SEE NOTES AND DETAILS ON DRAWING BR-16-81


LOCATIONS OF CANTILEVER SLAB REPLACEMENT, SEE NOTES AND DETAILS ON DRAWINGS BR-16-76 AND BR-16-77

LOCATIONS OF DIAPHRAGMS TO BE REPAIRED, SEE NOTES AND DETAILS ON DRAWING BR-16-78

THE INTERNATIONAL, LTD

DESIGNED BY J ROBERTS DATE AUGUST 1994
DRAWN BY J WELLS DATE AUGUST 1994
SUPERVISED BY S RAMANNA, J MASON DATE AUGUST 1994
CHECKED BY J MASON, J ROBERTS DATE AUGUST 1994

CONSULTING ENGINEERS Nashville, Termessee 37217 ENG JOB NO 94018

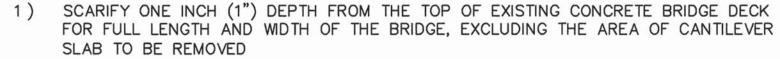

3) PERFORM FULL AND PARTIAL DECK REPAIRS ON THE EXISTING CONCRETE DECK

2) REMOVE THE EXISTING BRIDGERAIL, GUARDRAIL, AND CONCRETE CANTILEVER

- 4) REPAIR CRACKS IN ENDWALL AT ABUTMENT NO 2, LEFT LANE MODIFY WINGWALLS AT ABUTMENT NO 1 AND NO 2 FOR ENDPOSTS
- 5) INSTALL NEW 41/2" CONCRETE OVERLAY WITH NEW REINFORCING STEEL IN PHASES
- * 6) INSTALL NEW JERSEY SHAPE CONCRETE PARAPET AND 10'-2" ENDPOSTS APPLY TEXTURE COATING TO THE PARAPET AND CANTILEVER
- 7) REPAIR DETERIORATED CONCRETE IN END CAPS AT BENT NO 2, NORTHS END ONLY
- 8) REPAIR CONCRETE CRACKS AND SPALLED AREAS AT DESIGNATED LOCATIONS
- 9) REPLACE DIAPHRAGMS AND INSTALL NEW TYPE "H" STRIP SEAL EXPANSION JOINT AT BENT NO 1
- 10) INSTALL EARTH BERM AT MEDIAN, BEGINNING AND END OF BRIDGE
- 11) TRANSITION ROADWAY APPROACH TO EACH END OF BRIDGE
- 12) REPAIR SOIL EROSION AT ABUTMENT NO 1 AND NO 2, LEFT LANE ONLY



30003-4230-04		0003-4230-04 1994		
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YEAR

SHEET NO.

PROJECT NO.

LIST OF DRAWNGS

DRAWING NO	LAST REVISION DATE	DESCRIPTION
BR-16-74 BR-16-75		LAYOUT OF BRIDGE TO BE REPAIRED ESTIMATED BRIDGE QUANTITIES AND GENERAL NOTES
BR-16-76		BRIDGE REPAIR DETAILS, 1 OF 6
BR-16-77		BRIDGE REPAIR DETAILS, 2 OF 6
BR-16-78		BRIDGE REPAIR DETAILS, 3 OF 6
BR-16-79		BRIDGE REPAIR DETAILS, 4 OF 6
BR-16-80		BRIDGE REPAIR DETAILS, 5 OF 6
BR-16-81		BRIDGE REPAIR DETAILS, 6 OF 6

LIST OF STANDARD DRAWNGS

DRAWING NO	LAST REVISION DATE	DESCRIPTION
BR-2-115	07-29-92	GENERAL NOTES AND DETAILS FOR EXPANSION JOINT
BR-2-116	07-29-92	REPLACEMENT CONSTRUCTION TYPES "A" THRU "J"-1991 GENERAL NOTES AND DETAILS FOR STRIP SEAL EXPANSION JOINT REPLACEMENT CONSTRUCTION TYPES "A" THRU "J"-1991
BR-2-120	07-29-92	STRIP SEAL EXPANSION JOINTS REPLACEMENT CONSTRUCTION DETAILS TYPES "G" THRU "H"-1991
BR-2-125	11-16-92	DETAILS SHOWING REPLACEMENT OF EXISTING
BR-2-126	11-16-92	BRIDGERAIL SYSTEM WITH NEW JERSEY SHAPE
		CONCRETE PARAPET AND NEW 10'-2" ENDPOST-1988
STD-1-1	3-28-94	BRIDGE RAILING CONCRETE PARAPET-1990
STD-1-2	5-19-94	STEEL SLIDER PLATE ASSEMBLIES FOR CONCRETE
		PARAPET AND BRIDGE DECK DRAWING DETAILS-1993

LIST OF REFERENCE DRAWINGS

(TO BE PRINTED WITH PLANS)

DRAWNG NO	LAST REVISION DATE	DESCRIPTION
K-27-108 K-27-109		LAYOUT OF BRIDGE PRESTRESSED BEAM DETAILS, VARIABLE SECTIONS, STRAND LOCATIONS, AND QUANTITIES
K-15-65		STANDARD PRESTRESSED BEAM DETAILS
K-27-110 K-27-111		SUPERSTRUCTURE DETAILS ABUTMENT DETAILS
K-27-112		BENT DETAILS
K-27-113		BILL OF STEEL
K-15-59		STANDARD CONCRETE HANDRAIL PILES
11 3 11		TILLS

LIST OF SPECIAL PROVISIONS

** DENOTES CURRENT REVISION DATE, AS PER CONTRACT DOCUMENTS

NO_	LAST REVISION	DATE	REGARDING
100	**		REVISIONS AND ADDITIONS TO STANDARD SPECIFICATIONS
105A	**		APPROVAL OF SHOP DRAWINGS
602	**		SECTION 602- STEEL STRUCTURES
603A	**		PAINTING
604	**		CONCRETE STRUCTURES
604CX	**		CONTRACTOR-MIX DESIGN AND TESTING STRUCTURAL CONCRETE
604R	**		RIDEABILITY OF BRIDGE DECKS AND ROADWAY APPROACHES
907A	**		EPOXY COATED REINFORCING STEEL




STATE OF TENNESSEE **DEPARTMENT OF TRANSPORTATION** BUREAU OF HIGHWAYS


TO BE REPAIRED LEFT AND RIGHT LANES STATE ROUTE 34 OVER NORFOLK-SOUTHERN RAILROAD

LAYOUT OF BRIDGE

AND SNAPPS FERRY ROAD BRIDGE NO. 30-SR34-17.25 GREENE COUNTY 1994

BR-16-74

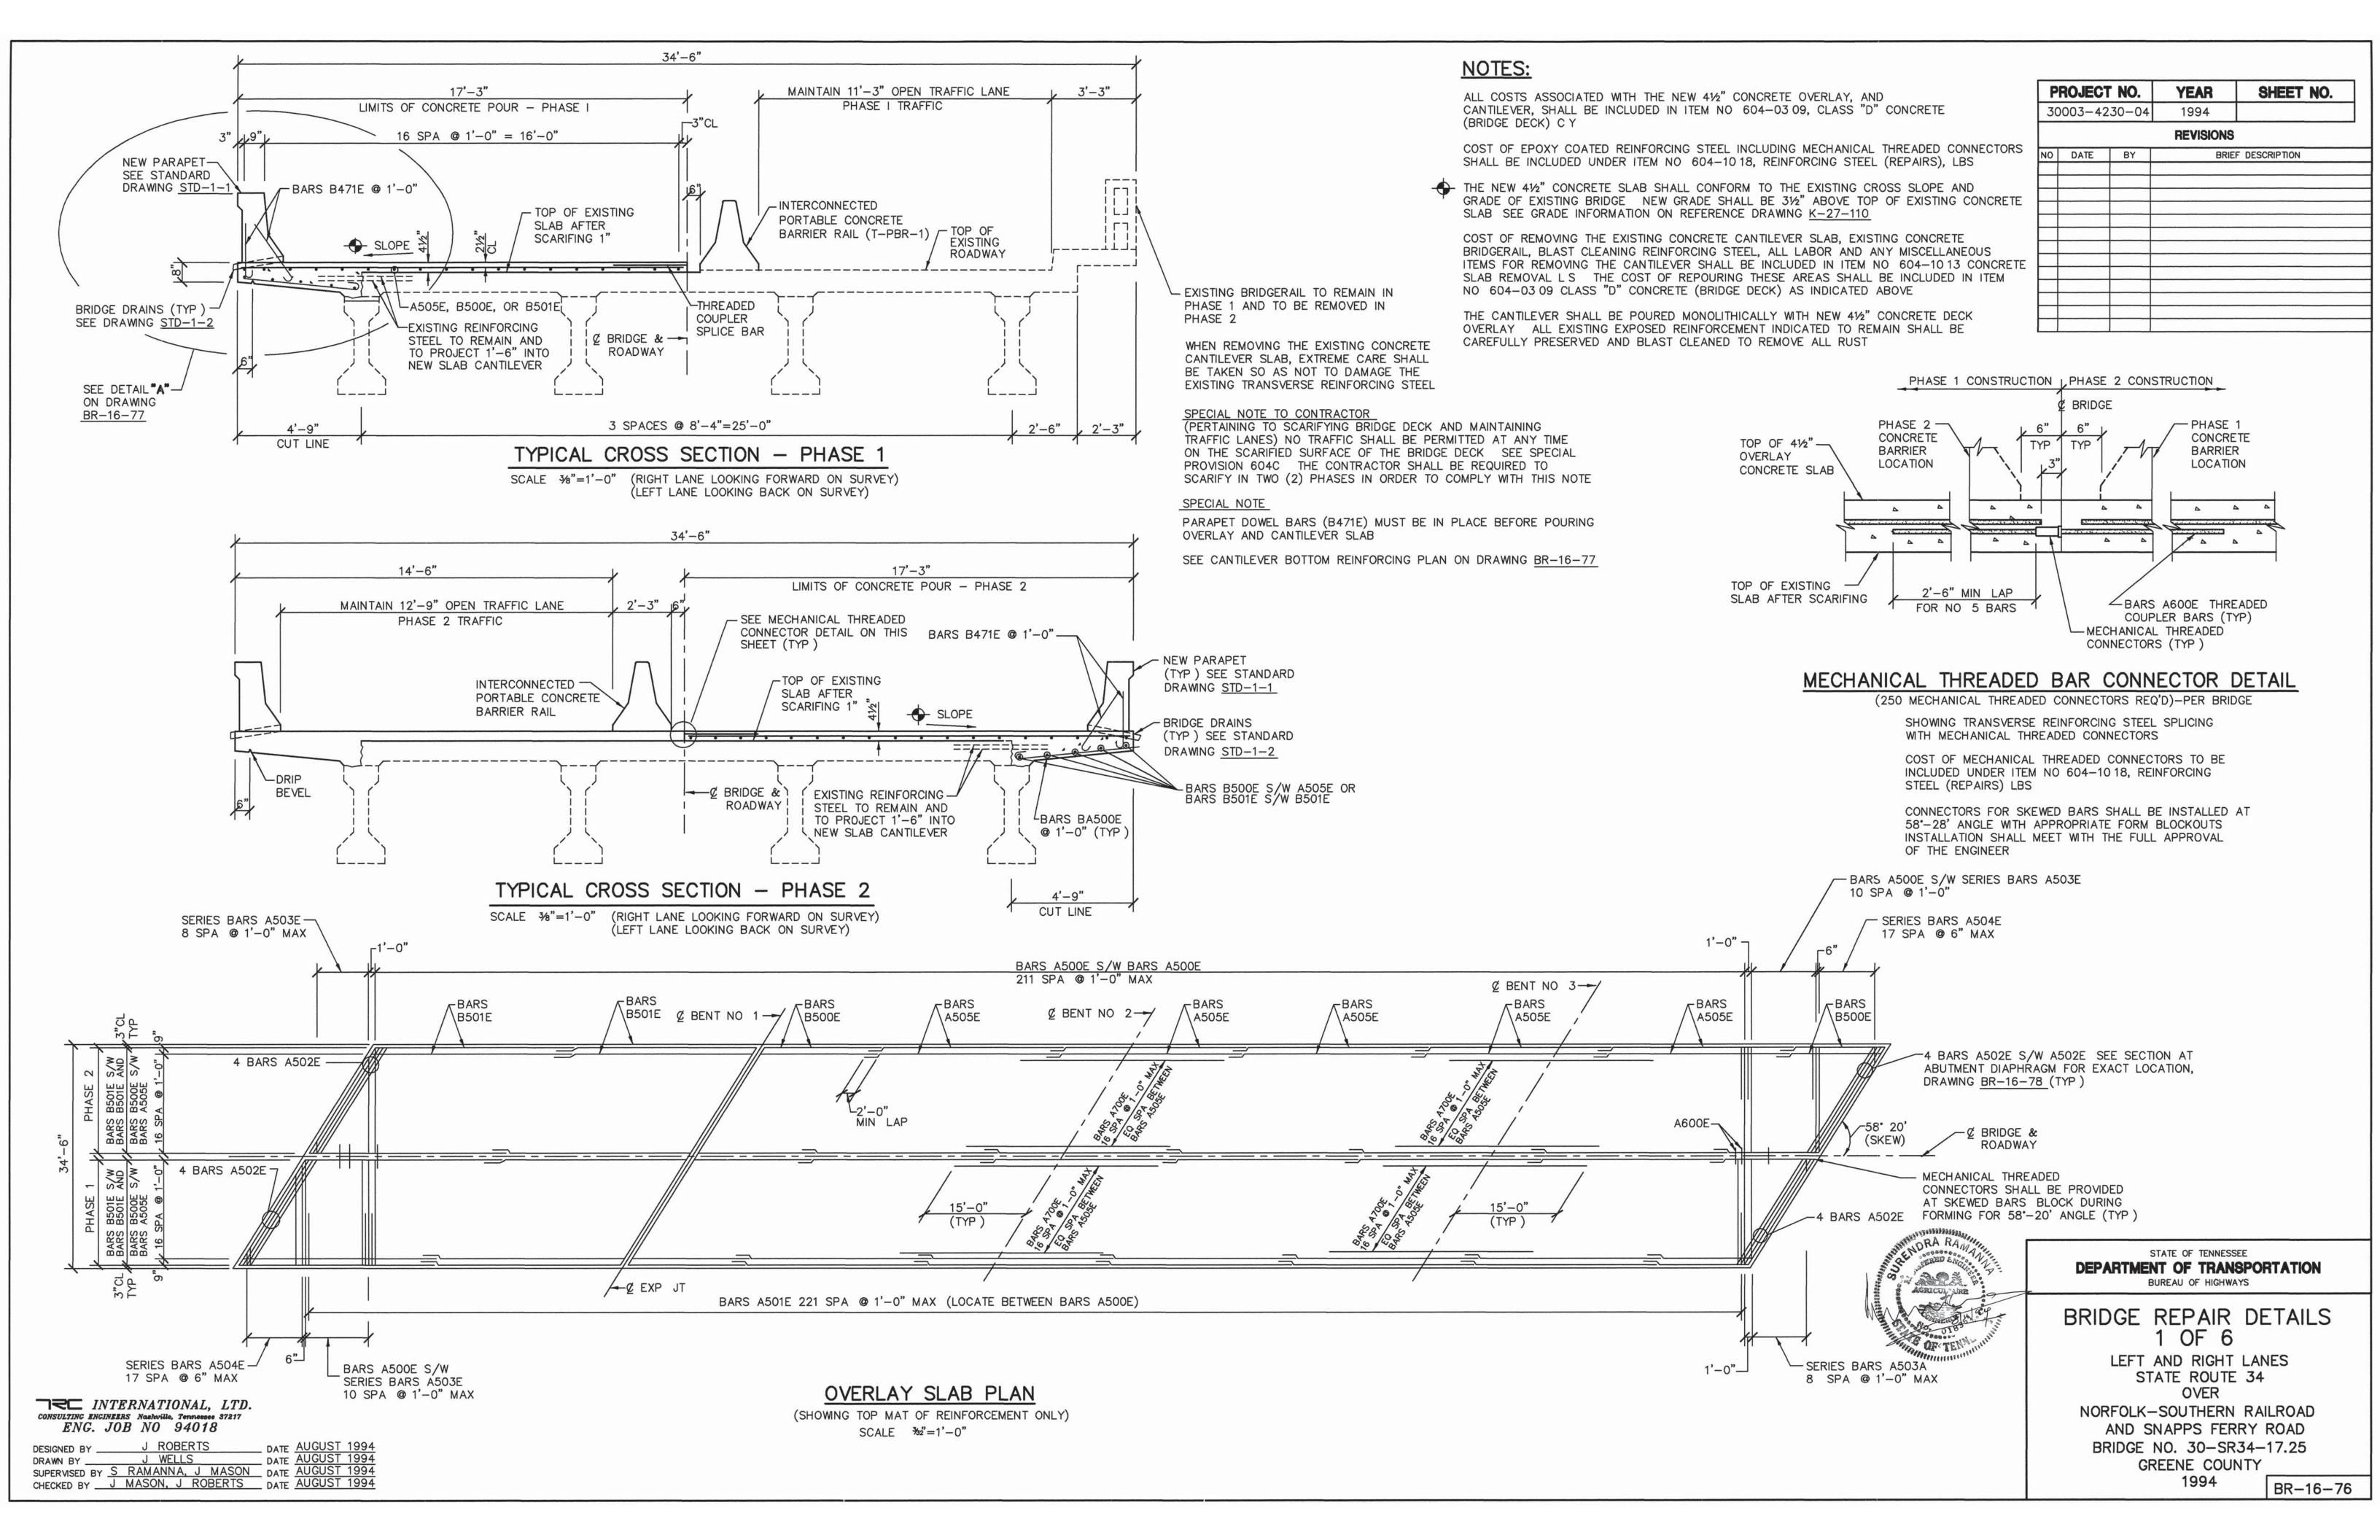

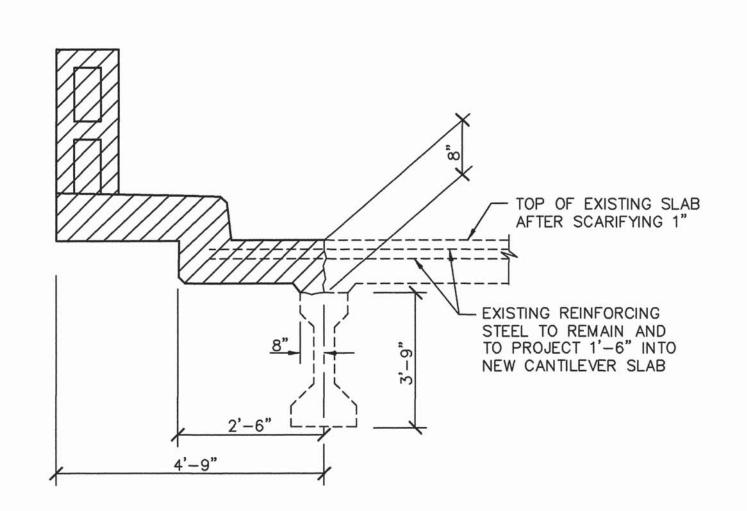


DETAIL SHOWING LIMITS OF EXISTING CANTILEVER TO BE REMOVED

COST OF REMOVING THE EXISTING CONCRETE BRIDGERAIL, CURB, CANTILEVER PORTION OF SLAB AND EXISTING REINFORCING STEEL. SHALL BE PAID FOR UNDER ITEM NO 604-1013, CONCRETE SLAB REMOVAL, LS

WHEN REMOVING THE EXISTING CONCRETE CANTILEVER SLAB, THE CONTRACTOR SHALL TAKE EXTREME CARE SO AS NOT TO DAMAGE THE EXISTING REINFORCING STEEL THAT IS DESIGNATED TO REMAIN THE EXISTING REINFORCING STEEL SHALL BE BLAST CLEANED AND INCORPORATED INTO THE NEW CONCRETE CANTILEVER

DENOTES AREA TO BE REMOVED FOR THE ENTIRE LENGTH OF THE BRIDGE SEE BR-16-74 FOR LIMITS OF EXISTING CANTILEVER TO BE REMOVED

DESIGNED BY J ROBERTS DATE AUGUST 1994
DRAWN BY J WELLS DATE AUGUST 1994
SUPERVISED BY S RAMANNA, J MASON DATE AUGUST 1994
CHECKED BY J MASON, J ROBERTS DATE AUGUST 1994

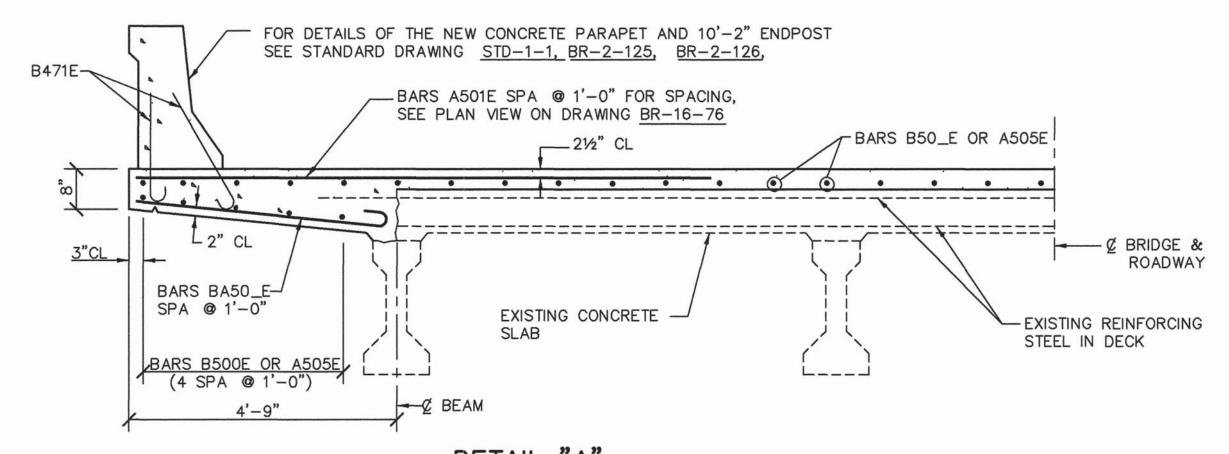



DETAIL "A" (SHOWING NEW CONCRETE PARAPET AND CANTILEVER REINFORCEMENT)

NOTE COST OF POURING THE NEW CONCRETE SLAB CANTILEVERS, FORMING,

LABOR AND ANY MISCELLANEOUS MATERIALS NECESSARY TO POUR THE NEW SLAB CANTILEVER SHALL BE PAID FOR UNDER ITEM NO 604-0309, CLASS "D" CONCRETE (BRIDGE DECK), C Y


COST OF POURING THE NEW CONCRETE PARAPET, INCLUDING EPOXY COATED REINFORCING STEEL, FORMING, LABOR, AND ANY MISCELLANEOUS MATERIALS REQUIRED TO POUR THE PARAPETS, SHALL BE PAID FOR UNDER ITEM NO 620-03 CONCRETE PARAPET, LF

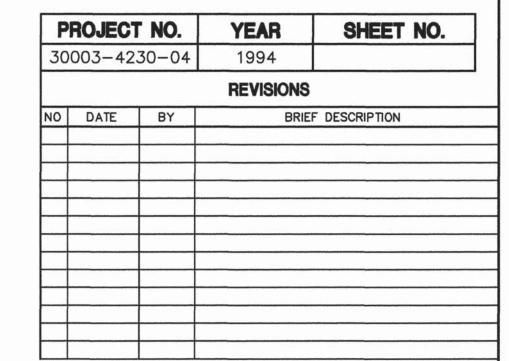

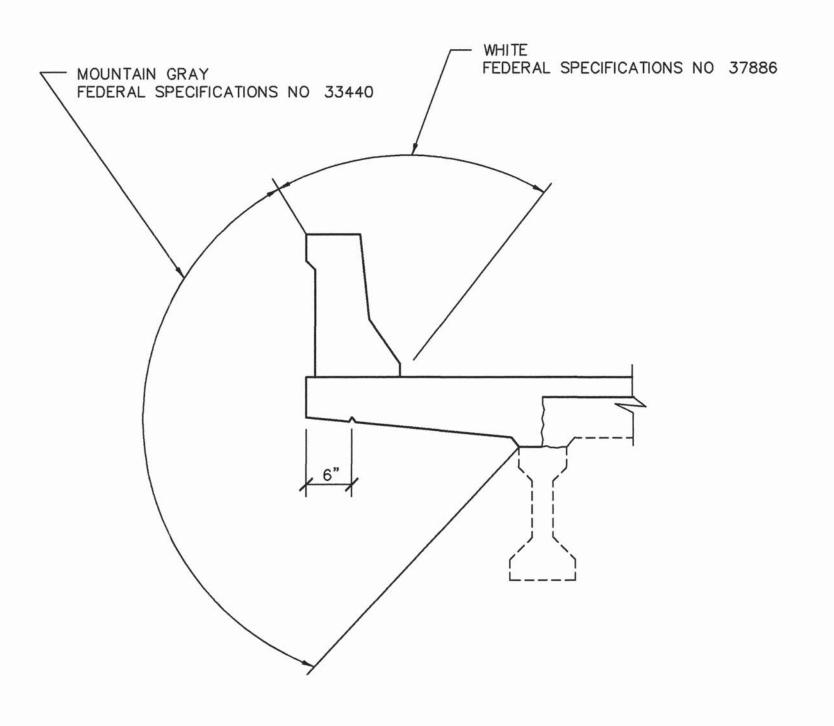

TEXTURE COATING DETAIL

NOTE COST OF TEXTURE COATING SHALL BE INCLUDED IN ITEM NO 620-03 AND INCLUDES 10'-2" ENDPOST AND AS SHOWN ON STANDARD DRAWINGS STD-1-1, BR-16-76 , AND BR-16-77

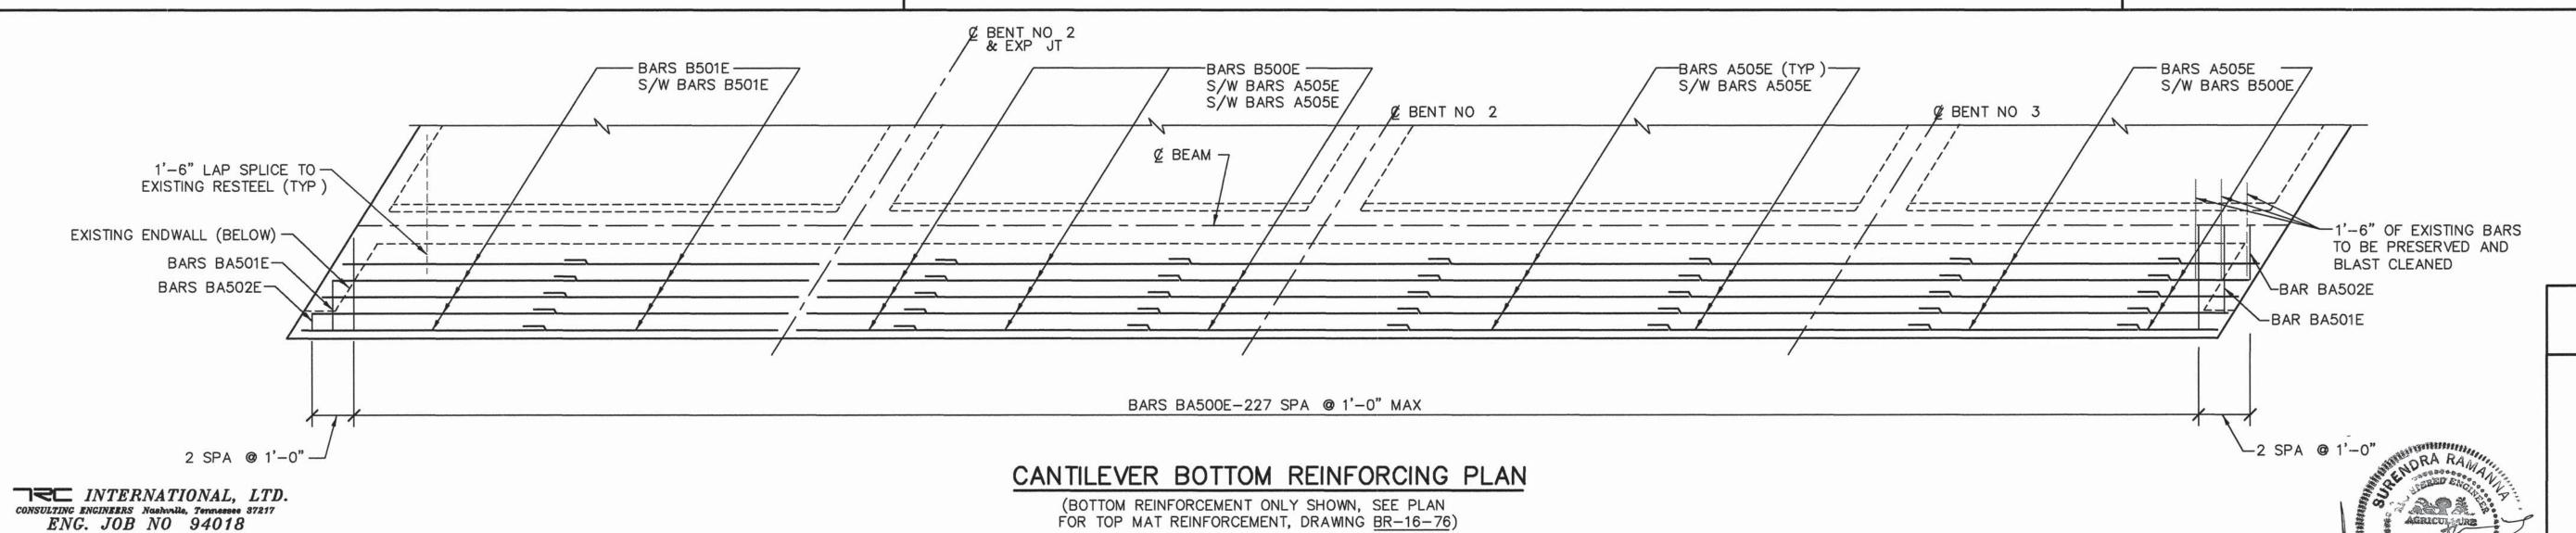

FOR TOP MAT REINFORCEMENT, DRAWING BR-16-76)

STATE OF TENNESSEE DEPARTMENT OF TRANSPORTATION BUREAU OF HIGHWAYS

BRIDGE REPAIR DETAILS 2 OF 6


LEFT AND RIGHT LANES STATE ROUTE 34 OVER


NORFOLK-SOUTHERN RAILROAD AND SNAPPS FERRY ROAD BRIDGE NO. 30-SR34-17.25 GREENE COUNTY

1994

BR-16-77

BAR	SIZE	REQ'D		В	ENDING I B	DIMENSIONS C	D	LENGTH
CONCE	PETE	OVE	PI AY	ANI			REINFOR	CEMENT
			ILAI	VIAL	CAIL	IILL VLIX	ILLINI OI	
A500E	5	446		-				16'-9"
A501E	5	444		_				8'-8"
A502E	5	16		_				19'-8"
SERIES								
A503E	5	2	LEN 15'-6¾	GTH IN	VARIES I	-ROM 2'-7 1'-73/8", 9	3/4" TO REQUIRED	81'-11"
SERIES								11 1 1 1 1 1 1 1 1 1 1 1 1 1 1 1 1 1 1
A504E	5	2	LENGTH IN	VAR I INC	IES FROM	1 2'-2" TO ", 18 REQU	15'-11¾" JIRED	163'-4"
A505E	5	230						30'-0"
A600E*	6	500						2'-6"
A700E	7	68						30'-0"
B471E	4	932	2'-0'	,				2'-7"
B500E	5	92	18'-0	,				18'-7"
B501E	5	92	32'-0	"				32'-7"
BA500E	5	456						4'-8"
BA501E	5	4						3'-5"
BA502E	5	4		_				2'-2"
HA400E	4	48	6"		2'-9"	5"	3'-3"	7'-5"
D500E	5	24	7'-4	"				8'-6"
				+				

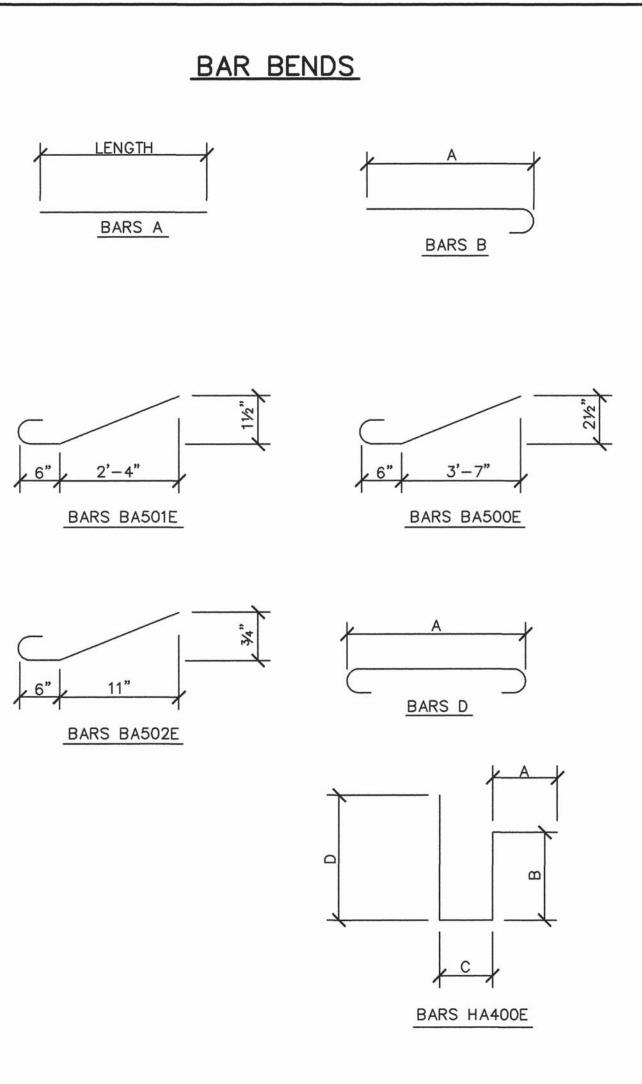


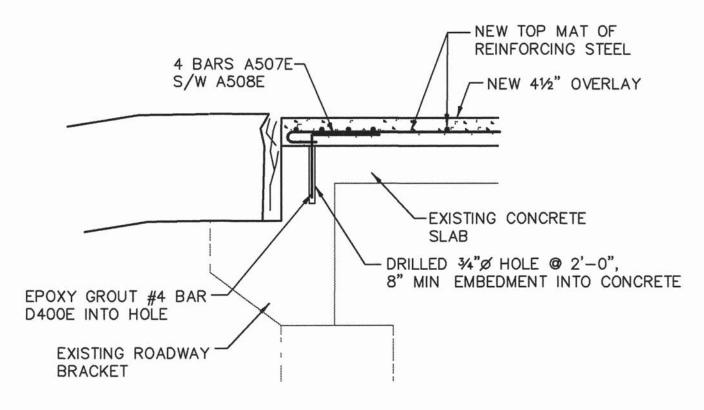

SECTION @ ABUTMENT ENDWALL

NOTES:

- 1 EXISTING SLAB AND DIAPHRAGM REINFORCING STEEL TO REMAIN IN PLACE AND TO BE BLAST CLEANED BEFORE POURING THE NEW CONCRETE
- 2 COST OF REMOVING EXISTING CONCRETE, FORMING NEW CLASS "D" CONCRETE, AND ALL LABOR AND OTHER MATERIAL NECESSARY FOR DIAPHRAGM REPLACEMENT WILL BE INCLUDED IN ITEM NO 604-03 09, CLASS "D" CONCRETE (BRIDGE DECK) C Y

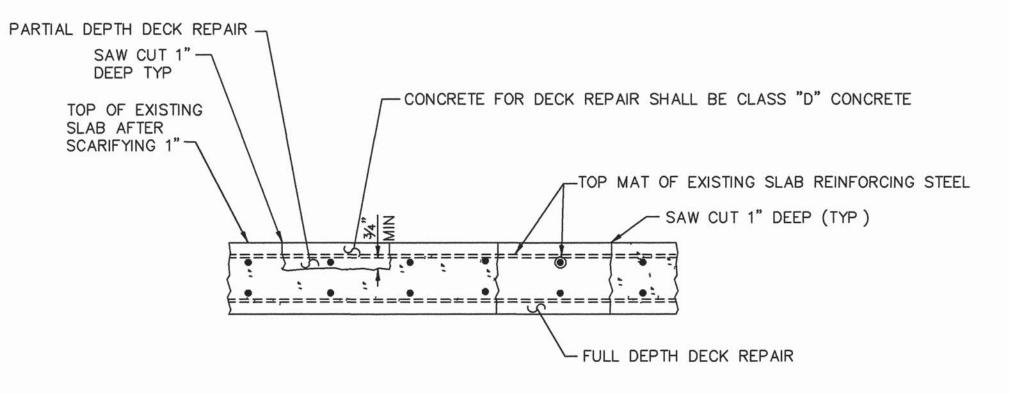

P	ROJEC1	Γ NO.	YEAR	SHEET NO.
300	003-42	30-04	1994	
			REVISIONS	}
NO	DATE	BY	BRIE	EF DESCRIPTION

DETAIL SHOWING FULL AND PARTIAL DEPTH DECK REPAIR

REMOVE CONCRETE IN ALL DELAMINATED AREAS TO A DEPTH OF 34" BELOW THE TOP BAR OF THE TOP MAT OF REINFORCING STEEL ALL REINFORCING STEEL IN AREAS OF DECK REPAIR SHALL BE BLAST CLEANED AREAS OF CONCRETE REMOVAL SHALL BE DESIGNATED BY PERSONNEL FROM THE HEADQUARTERS, BRIDGE INSPECTION AND REPAIR OFFICE DECK REPAIR WILL BE PAID FOR UNDER ITEM NO 604-10 50, BRIDGE DECK REPAIR (PARTIAL DEPTH OF SLAB), AND ITEM NO 604-10 30, BRIDGE DECK REPAIR (FULL DEPTH OF SLAB) DURING PARTIAL DEPTH REPAIRS, SHOULD DETERIORATED CONCRETE BE ENCOUNTERED WHICH APPEARS TO RUN FULL DEPTH IN THE SLAB, THE ENGINEER MAY DESIGNATE THESE AREAS TO BE REPAIRED UNDER ITEM NO 604-10 30 POWER DRIVEN HAND TOOLS USED FOR THE REMOVAL OF UNSOUND CONCRETE IN MAKING PARTIAL DEPTH REPAIRS ARE SUBJECT TO THE FOLLOWING RESTRICTIONS 1) PNEUMATIC HAMMERS HEAVIER THAN NOMINAL 35 POUND CLASS SHALL NOT BE USED, 2) CHIPPING HAMMERS OF THE 15 POUND CLASS SHALL BE USED TO REMOVE CONCRETE FROM BENEATH ANY REINFORCING

ITEM NO 604-10 30 AND 604-10 50 SHALL BE BID WITH THE CONTINGENCY THAT THESE ITEMS MAY BE INCREASED, DECREASED, OR ELIMINATED AS DIRECTED BY THE ENGINEER

__ 1" SAW CUT (TYP) LIMITS OF DIAPHRAGM -REMOVAL - BARS B50_E SPLICED WITH BARS A505E 101/2" -EXISTING DECK SURFACE 17-7-A -----EXISTING BARS TO REMAIN AND BE BLAST CLEANED ------_______ F 1 F 1 - AREA OF CONCRETE EXISTING -REMOVAL PRESTRESSED BEAM BENT CAP E=EXPANSION END F=FIXED END

DIAPHRAGM REPAIR DETAIL @ BENTS NO. 2 AND 3

STATE OF TENNESSEE DEPARTMENT OF TRANSPORTATION BUREAU OF HIGHWAYS

BRIDGE REPAIR DETAILS 3 OF 6

> LEFT AND RIGHT LANES STATE ROUTE 34 OVER NORFOLK-SOUTHERN RAILROAD AND SNAPPS FERRY ROAD BRIDGE NO. 30-SR34-17.25 GREENE COUNTY 1994

□₹□ INTERNATIONAL, LTD

CONSULTING ENGINEERS Nacharile, Tennessee 37217

ENG JOB NO 94018


DESIGNED BY J ROBERTS DATE AUGUST 1994
DRAWN BY J WELLS DATE AUGUST 1994
SUPERVISED BY S RAMANNA, J MASON DATE AUGUST 1994
CHECKED BY J MASON, J ROBERTS DATE AUGUST 1994

BR-16-78


REPAIR LEGEND

REPAIR CONCRETE SPALLING ON BENT CAPS, SEE NOTES AND DETAILS ON DRAWING BR-16-80


> REPAIR CONCRETE SPALLING ON BENTS, AND COLUMNS SEE NOTE AND DETAILS ON THIS SHEET AND DRAWING BR-16-80

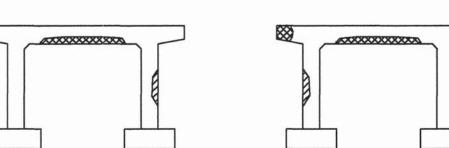


RIGHT LANE BENT NO 1 LOOKING FORWARD TO SURVEY

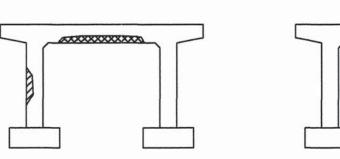


RIGHT LANE BENT NO 1 LOOKING BACK ON SURVEY

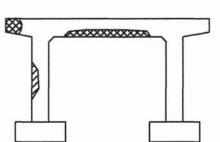


RIGHT LANE BENT NO 2 LOOKING FORWARD TO SURVEY

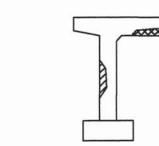


RIGHT LANE BENT NO 2 LOOKING BACK ON SURVEY

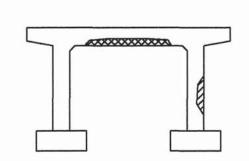


RIGHT LANE BENT NO 3 LOOKING FORWARD TO SURVEY

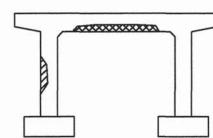


RIGHT LANE BENT NO 3 LOOKING BACK ON SURVEY

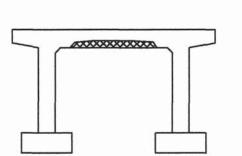


LEFT LANE BENT NO 1 LOOKING FORWARD TO SURVEY

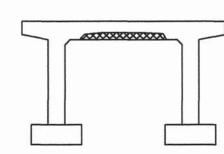

LEFT LANE BENT NO 1 LOOKING BACK ON SURVEY

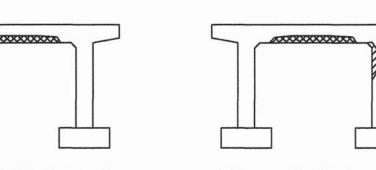

LEFT LANE BENT NO 2 LEFT LANE BENT NO 3 LOOKING FORWARD TO LOOKING FORWARD TO SURVEY

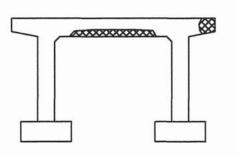

SURVEY

LEFT LANE BENT NO 2 LEFT LANE BENT NO 3 LOOKING BACK ON SURVEY LOOKING BACK ON SURVEY


LOCATION	ITEM NO 004 40 40			
OF REPAIR	ITEM NO 604-1042 CONCRETE REPAIRS, C.F.	ITEM NO 604-1054 CONCRETE REPAIRS, SF		
	BENT CAP	BENT CAP	DIAPHRAGMS	
BENT NO 1 RIGHT LANE	_	60 0	*	
BENT NO 2 RIGHT LANE	20 0	60 0	30 0	
BENT NO 3 RIGHT LANE	-	40 0	10 0	
BENT NO 1 LEFT LANE	-	40 0	*	
BENT NO 2 LEFT LANE	20 0	60 0	30 0	
BENT NO 3 LEFT LANE	-	60 0	10 0	
TOTAL	40 0	320 0	80 0	

* DIAPHRAGMS TO BE REPLACED


PROJECT NO.			YEAR	SHEET NO.	
0003-4230-04			1994		
			REVISIONS		
	DATE BY BRIEF DESCRIPTION				
+					
+					
L					

- DENOTES AREA OF EXISTING SPALLED -SAW CUT -CONCRETE \1" (TYP) *90 (TYP) -SAW CUT 1" (TYP) - DENOTES AREA OF EXISTING SPALLED CONCRETE


DETAIL SHOWING SPALLED CONCRETE

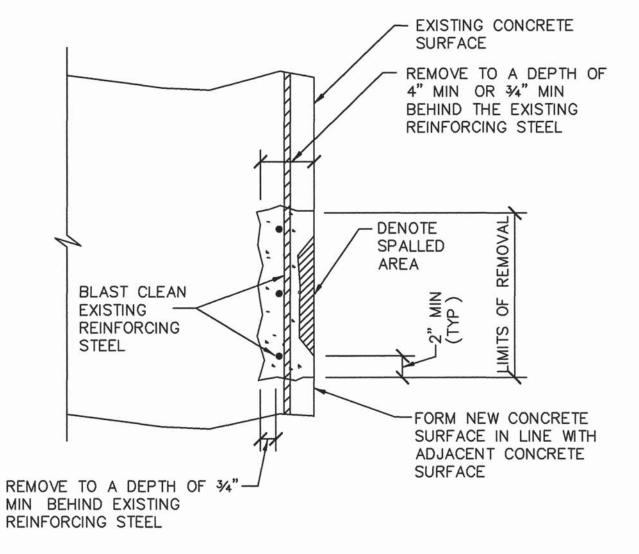

SECTION A-A

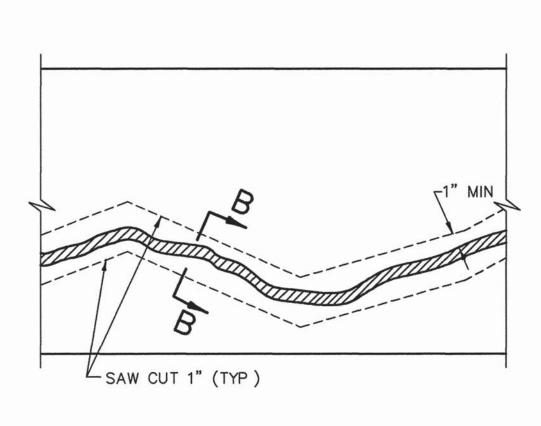

DETAIL SHOWING EXISTING CRACKED CONCRETE

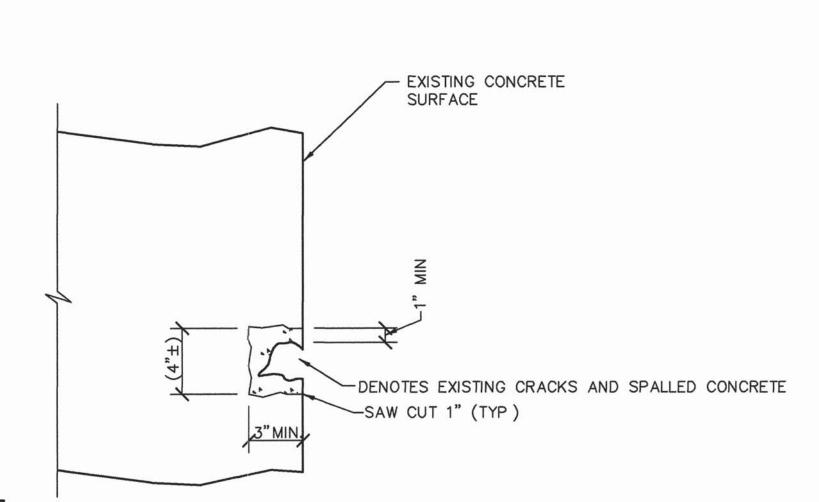

SECTION B-B

NOTES:

* SAW CUT EXISTING CONCRETE SO AS TO OBTAIN A SQUARE AREA

DURING SAW CUT OPERATION, CONTRACTOR TO FIELD VERIFY CONCRETE COVER TO PREVENT DAMAGE TO EXISTING STEEL REINFORCEMENT

COST OF SAW CUTTING, REMOVING SPALLED OR BLAST CLEANING, NEW PATCHING MATERIAL, LABOR, AND ANY MISCELLANEOUS MATERIALS NECESSARY TO COMPLETE THE REPAIRS AS SHOWN TO BE INCLUDED IN ITEM NO 604-1054 CONCRETE REPAIRS, SF

THE CONTRACTOR MAY OBTAIN A LIST OF ACCEPTABLE BRANDS OF PATCHING MATERIAL FROM THE TENNESSEE DEPARTMENT OF TRANSPORTATION, DIVISION OF MATERIALS AND TEST

NOTES:

DURING SAW CUT OPERATION, CONTRACTOR TO FIELD VERIFY CONCRETE COVER TO PREVENT DAMAGE TO EXISTING STEEL REINFORCEMENT

COST OF SAW CUTTING, REMOVING SPALLED CONCRETE, NEW PATCHING MATERIAL LABOR, AND ANY MISCELLANEOUS MATERIALS NECESSARY TO COMPLETE THE REPAIRS AS SHOWN TO BE INCLUDED IN ITEM NO 604-1054, CONCRETE REPAIRS, SF



DENOTES EXISTING CRACK AND SPALLED CONCRETE

PATCHING MATERIAL SHALL BE POLYMER-MODIFIED CEMENTITIOUS, NON-SAG GROUT, SUCH AS SIKATOP 122 OR EQUAL



STATE OF TENNESSEE DEPARTMENT OF TRANSPORTATION BUREAU OF HIGHWAYS

BRIDGE REPAIR DETAILS 4 OF 6

LEFT AND RIGHT LANES STATE ROUTE 34 OVER NORFOLK-SOUTHERN RAILROAD

AND SNAPPS FERRY ROAD BRIDGE NO 30-SR34-17.25 GREENE COUNTY


1994

BR-16-79

CONSULTING ENGINEERS Nashville, Tennessee 87217 ENG. JOB NO 94018


TEL INTERNATIONAL, LTD

DESIGNED BY J ROBERTS DATE AUGUST 1994
DRAWN BY J WELLS DATE AUGUST 1994
SUPERVISED BY S RAMANNA, J MASON DATE AUGUST 1994
CHECKED BY J MASON, J ROBERTS DATE AUGUST 1994

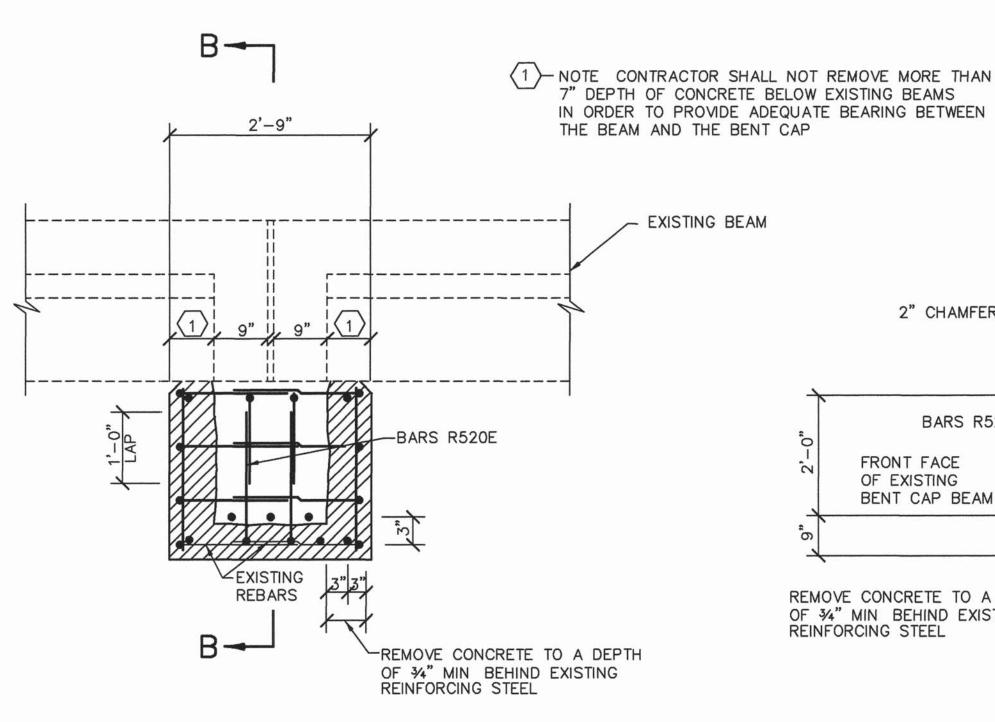

NOTE THE CONTRACTOR SHALL PERFORM THE REPAIR IN A MANNER TO INSURE THAT STRUCTURAL SUPPORT OF BEAMS IS MAINTAINED AT ALL ADDITIONAL SUPPORT WHEREVER REQUIRED BY

TIMES CONTRACTOR SHALL PROVIDE TEMPORARY HIS CONSTRUCTION OPERATIONS

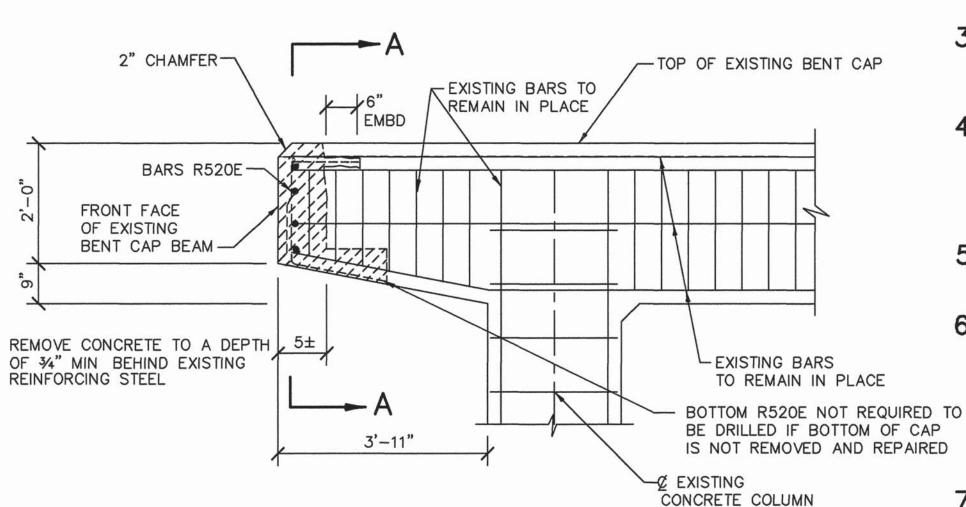


SECTION B-B

SHOWING AREA OF BENT CAP

END REPAIR (2 TOTAL REQ'D)


NOTES:

- CARE SHALL BE TAKEN WHEN REMOVING THE EXISTING DETERIORATED CONCRETE IN DESIGNATED AREAS SO AS NOT TO DAMAGE THE EXISTING LONGITUDINAL REINFORCING
- 2 ALL EXPOSED EXISTING REINFORCING STEEL SHALL RECEIVE A COMPLETE BLAST CLEANING TO REMOVE ALL RUST ALL WORK MUST MEET FULL APPROVAL OF THE ENGINEER
- 3 EXISTING REINFORCING STEEL SHALL REMAIN IN PLACE AND BE INCORPORATED WITH NEW REINFORCING STEEL WHEN REPOURING THE NEW BENT CAP BEAM END CONCRETE SHALL BE REPLACED TO MATCH EXISTING LINES AND SURFACES
- 4 COST OF SAW CUTTING, EXISTING CONCRETE REMOVAL, BLAST CLEANING OF EXISTING REINFORCING STEEL, CLASS "D" CONCRETE, LABOR, AND ANY MISCELLANEOUS MATERIALS NECESSARY TO COMPLETE THE REPAIRS TO THE CAP ENDS AS SHOWN IN THE DETAILS ON THIS SHEET TO BE INCLUDED UNDER ITEM NO 604-10 42 CONCRETE REPAIRS CF
- 5 COST OF EPOXY COATED REINFORCING STEEL IN BENT CAP AREAS OF REPAIR SHALL BE PAID FOR UNDER ITEM NO 604-1018, REINFORCING STEEL (REPAIRS) LBS
- 6 GROUTED BARS IN DRILLED HOLES HOLES FOR GROUTED BARS R520E SHALL BE DRILLED WITH HIGH SPEED DRILL THE DRILL BIT SHALL BE CAPABLE OF DRILLING THROUGH REINFORCING BARS AND CONCRETE THE DRILLED HOLE SHALL BE DRILLED 1/2" IN DIAMETER LARGER THAN THE BAR, CLEANED, PACKED WITH NON-SHRINK GROUT, AND THE BAR DRIVEN TO ITS SEAT A LIST OF APPROVED GROUTS MAY BE OBTAINED FROM THE TENNESSEE DEPARTMENT OF TRANSPORTATION, DIVISION OF MATERIAL AND TESTS
- THE ENGINEER MAY INCREASE, DECREASE, OR ELIMINATE THE QUANTITIES PAID FOR UNDER ITEM NO 604-10 42 CONCRETE REPAIRS, CF

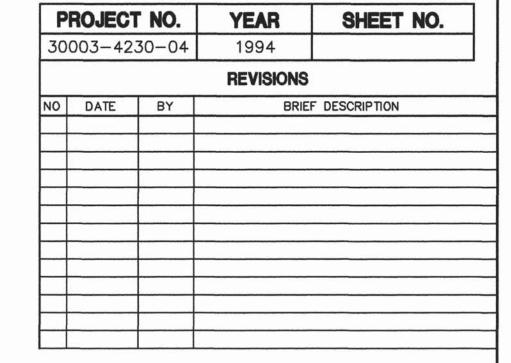


BILL OF STEEL

BARS	SIZE	NO REQ	LENGTH	LOCATION
A421E	4	16	2'-3"	CAP BEAM
R421E	4	16	4'-6"	CAP BEAM
R520E	5	8	3'-0"	CAP BEAM

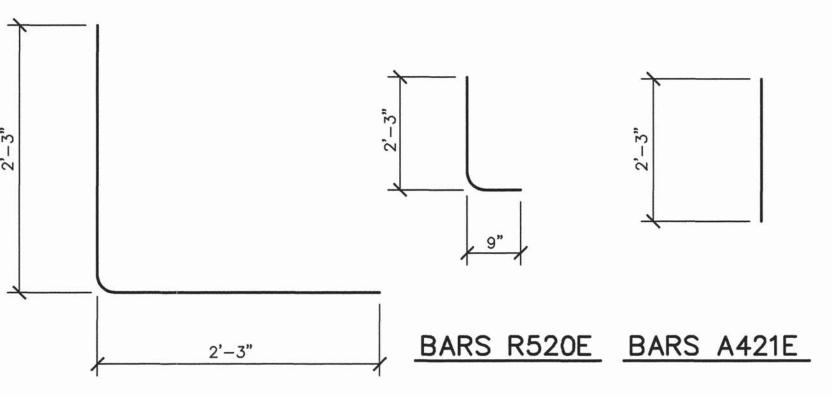


BARS R421E

SECTION A-A

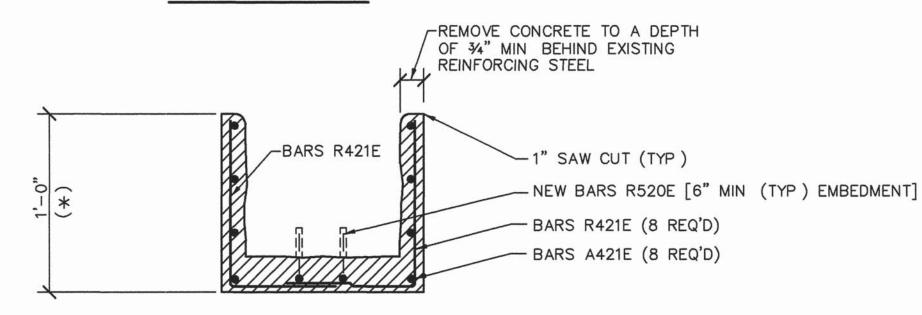

PLAN-TOP OF BENT CAP

* FIELD CUT REBAR IF LENGTH IS FIELD ADJUSTED BY ENGINEER

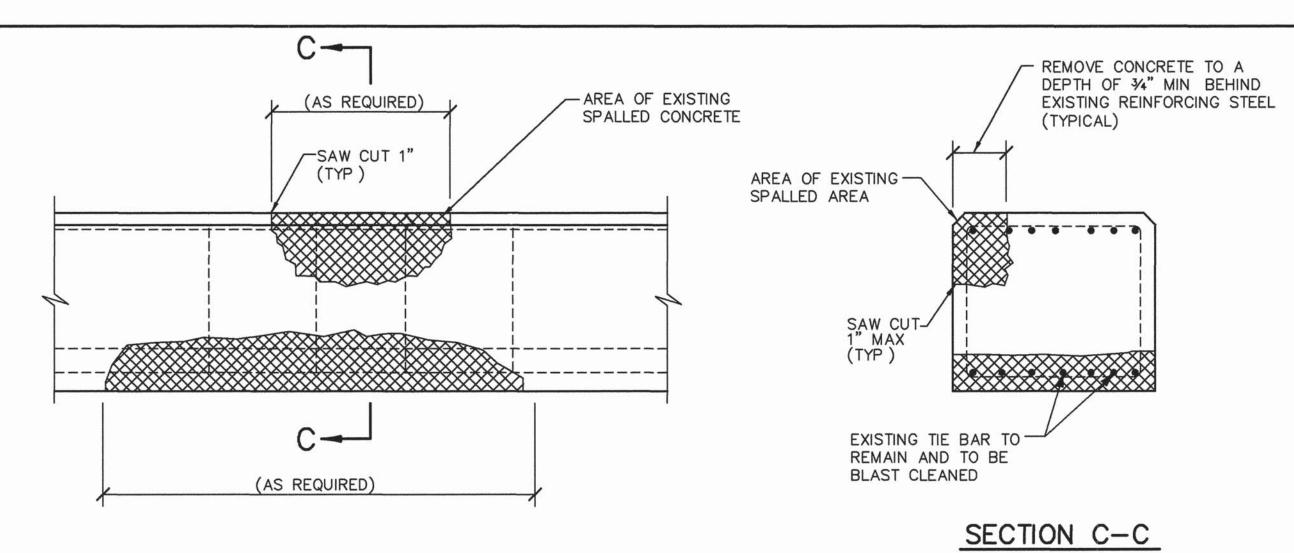


BENT CAP SPALL REPAIR

(SEE DRAWING BR-16-79 FOR LOCATIONS)

NOTES COST OF SAW CUTTING, EXISTING CONCRETE REMOVAL, BLAST CLEANING OF EXISTING EXPOSED REINFORCING STEEL, NEW PATCHING MATERIAL, LABOR AND ALL MISCELLANEOUS MATERIALS AS NECESSARY TO COMPLETE THE SPALLING REPAIRS AS SHOWN IN THE DETAIL SHALL BE INCLUDED IN ITEM NO 604-10 54 CONCRETE REPAIR S F

> EXTREME CARE SHALL BE TAKEN WHEN REMOVING THE EXISTING DETERIORATED CONCRETE IN DESIGNATED AREAS SO AS NOT TO DAMAGE THE EXISTING REINFORCING STEEL ALL EXPOSED REINFORCING STEEL SHALL BE BLAST CLEANED AND REMAIN IN PLACE ALL WORK MUST MEET THE APPROVAL OF THE ENGINEER

PATCHING MATERIAL SHALL BE POLYMER-MODIFIED CEMENTITIOUS, NON-SAG GROUT, SUCH AS SIKATOP 122, 123 (FOR OVER HEAD), OR EQUAL

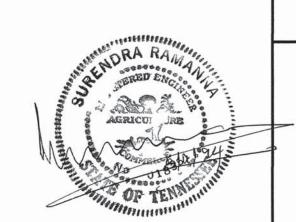

STATE OF TENNESSEE DEPARTMENT OF TRANSPORTATION BUREAU OF HIGHWAYS

BRIDGE REPAIR DETAILS 5 OF 6


LEFT AND RIGHT LANES STATE ROUTE 34 OVER NORFOLK-SOUTHERN RAILROAD AND SNAPPS FERRY ROAD

BRIDGE NO. 30-SR34-17.25 GREENE COUNTY 1994

BR-16-80

TEL INTERNATIONAL, LTD CONSULTING ENGINEERS Nachwille, Tennessee 37217 ENG. JOB NO 94018

DESIGNED BY J ROBERTS DATE AUGUST 1994
DRAWN BY J WELLS DATE AUGUST 1994
SUPERVISED BY S RAMANNA, J MASON DATE AUGUST 1994
CHECKED BY J MASON, J ROBERTS DATE AUGUST 1994 DESIGNED BY ______ J ROBERTS

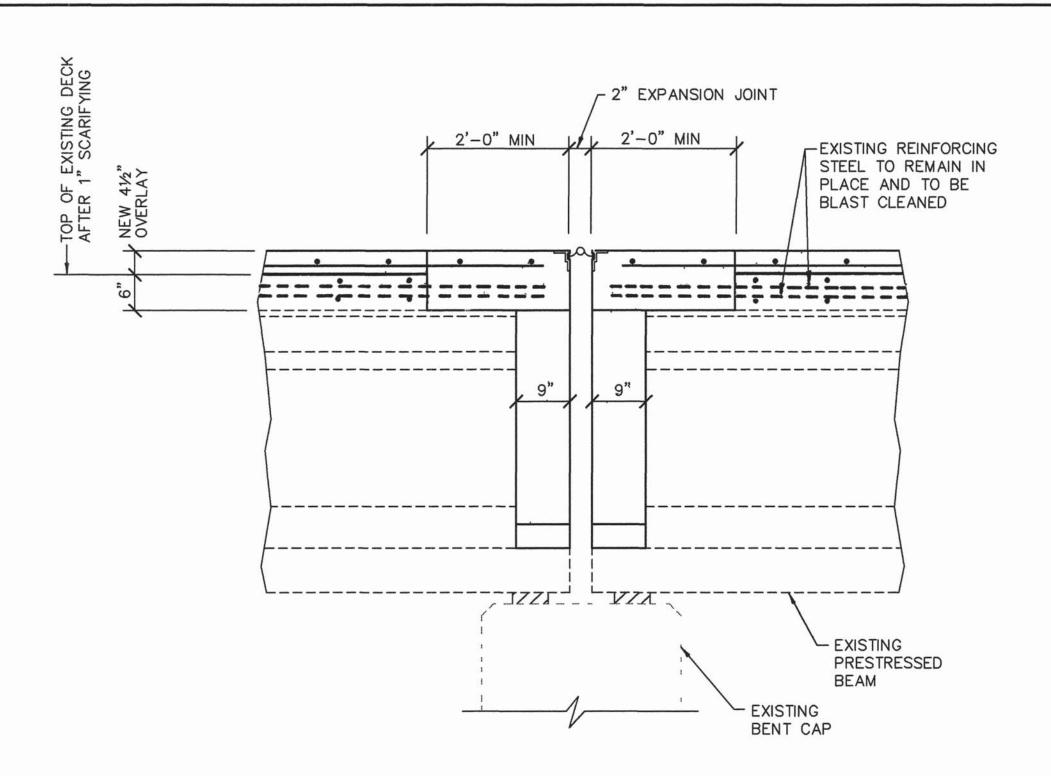

EXPANSION JOINT TYPE "H" DETAIL


NEW JOINT AT BENT NO 1 (LEFT AND RIGHT LANES)

FOR ADDITIONAL INFORMATION NOT SHOWN, SEE EXPANSION JOINT REPLACEMENT DETAILS, TYPE "H" ON STANDARD DWG NO BR-2-120 ALSO FOR ADDITIONAL NOTES AND DETAILS SEE STANDARD DRAWING BR-2-115 AND BR-2-116

NOTE COST OF ALL EPOXY COATED REINFORCING STEEL FOR THE TYPE "H" EXPANSION JOINT AREAS SHALL BE PAID FOR UNDER ITEM NO 604-10 47, LF

NOTE COST OF INSTALLING NEW TYPE "H" EXPANSION JOINT SHALL BE MEASURED AND PAID FOR UNDER ITEM NO 604-10 47, EXPANSION JOINT REPAIR (TYPE "H"), LF

NOTE A LIST OF APPROVED EPOXY GROUTS MAY BE OBTAINED FROM THE TENNESSEE DEPARTMENT OF TRANSPORTATION, DIVISION OF MATERIALS AND TESTS

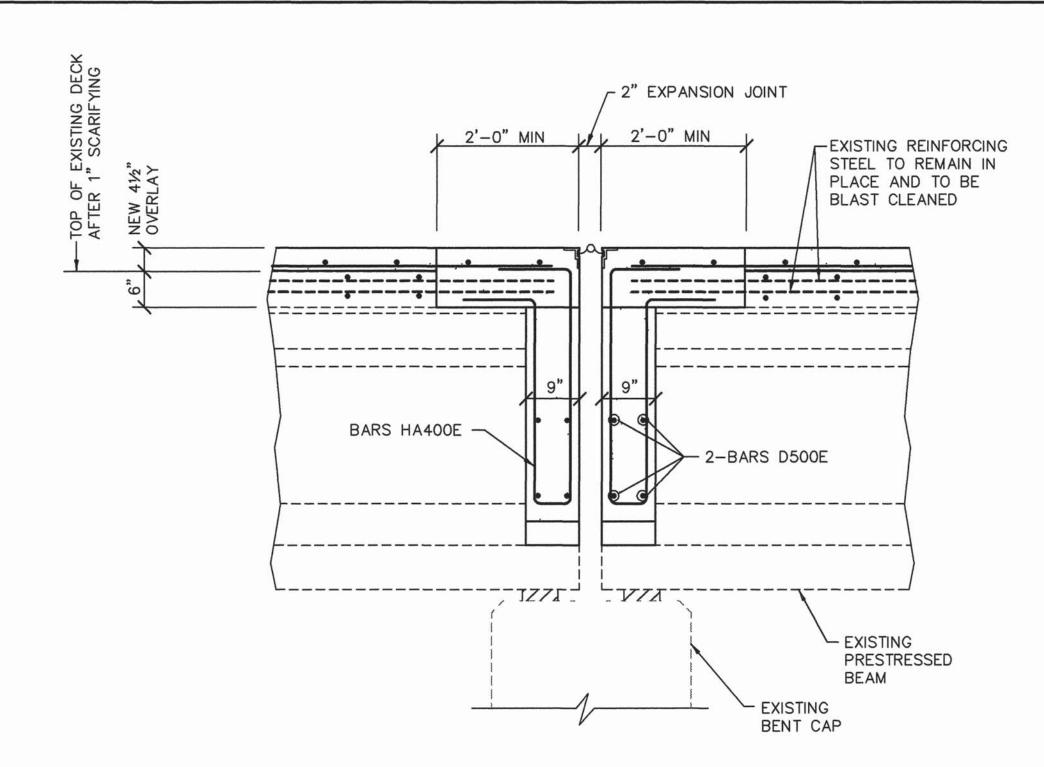


DETAIL "B"

SHOWING AREAS OF REPAIR FOR TYPE "H" EXPANSION JOINT REPLACEMENT AND DIAPHRAGMS AT BENT NO 1 (LEFT AND RIGHT LANES)


NOTES:


COST OF ALL FORMING, SAW CUTTING, WELDING, GROUT, CLEANING, LABOR, AND ANY MISCELLANEOUS MATERIALS NEEDED TO COMPLETE THE REPAIRS AS SHOWN SHALL BE INCLUDED IN THE ITEMS BID ON

COST OF REMOVING EXISTING CONCRETE, FORMING NEW CLASS "D" CONCRETE, AND ALL LABOR AND OTHER MATERIAL NECESSARY FOR DIAPHRAGM REPLACEMENT WILL BE INCLUDED IN ITEM NO 604-03 09, CLASS "D" CONCRETE, (BRIDGE DECK) C Y

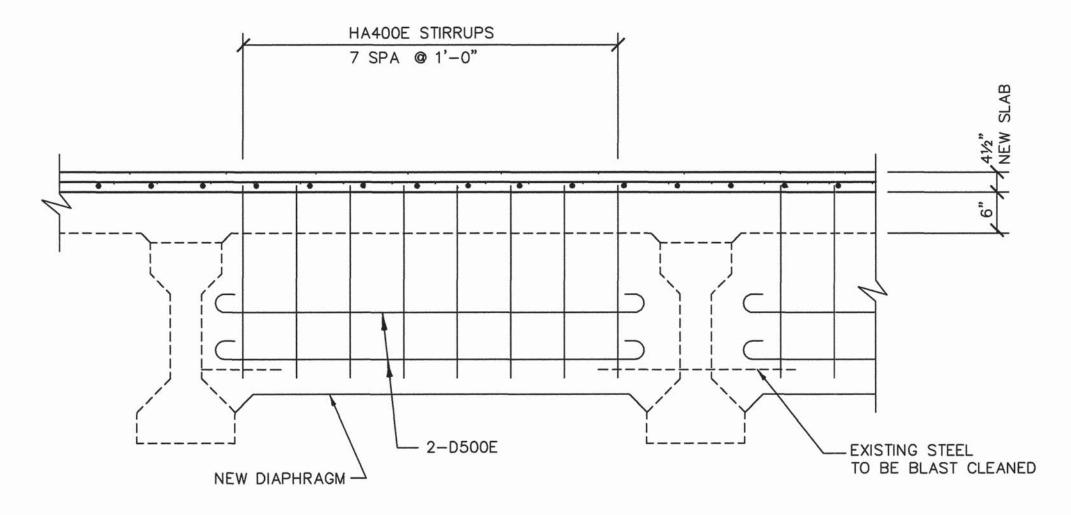

DIAPHRAGM REPLACEMENT DETAIL AT BENT NO. 1

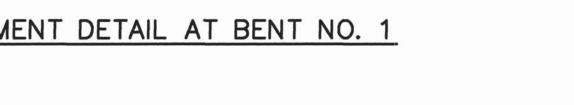

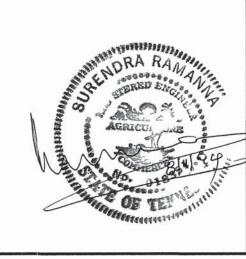

STATE OF TENNESSEE

DEPARTMENT OF TRANSPORTATION BUREAU OF HIGHWAYS

YEAR

1994

REVISIONS

SHEET NO.

BRIEF DESCRIPTION

PROJECT NO.

30003-4230-04

NO DATE BY


BRIDGE REPAIR DETAILS 6 OF 6


LEFT AND RIGHT LANES STATE ROUTE 34 **OVER** NORFOLK-SOUTHERN RAILROAD AND SNAPPS FERRY ROAD BRIDGE NO 30-SR34-17.25 GREENE COUNTY 1994


BR-16-81


□ INTERNATIONAL, LTD CONSULTING ENGINEERS Nashwille, Termessee 37217 ENG JOB NO. 94018


DESIGNED BY J ROBERTS DATE AUGUST 1994
DRAWN BY J WELLS DATE AUGUST 1994
SUPERVISED BY S RAMANNA, J MASON DATE AUGUST 1994
CHECKED BY J MASON, J ROBERTS DATE AUGUST 1994

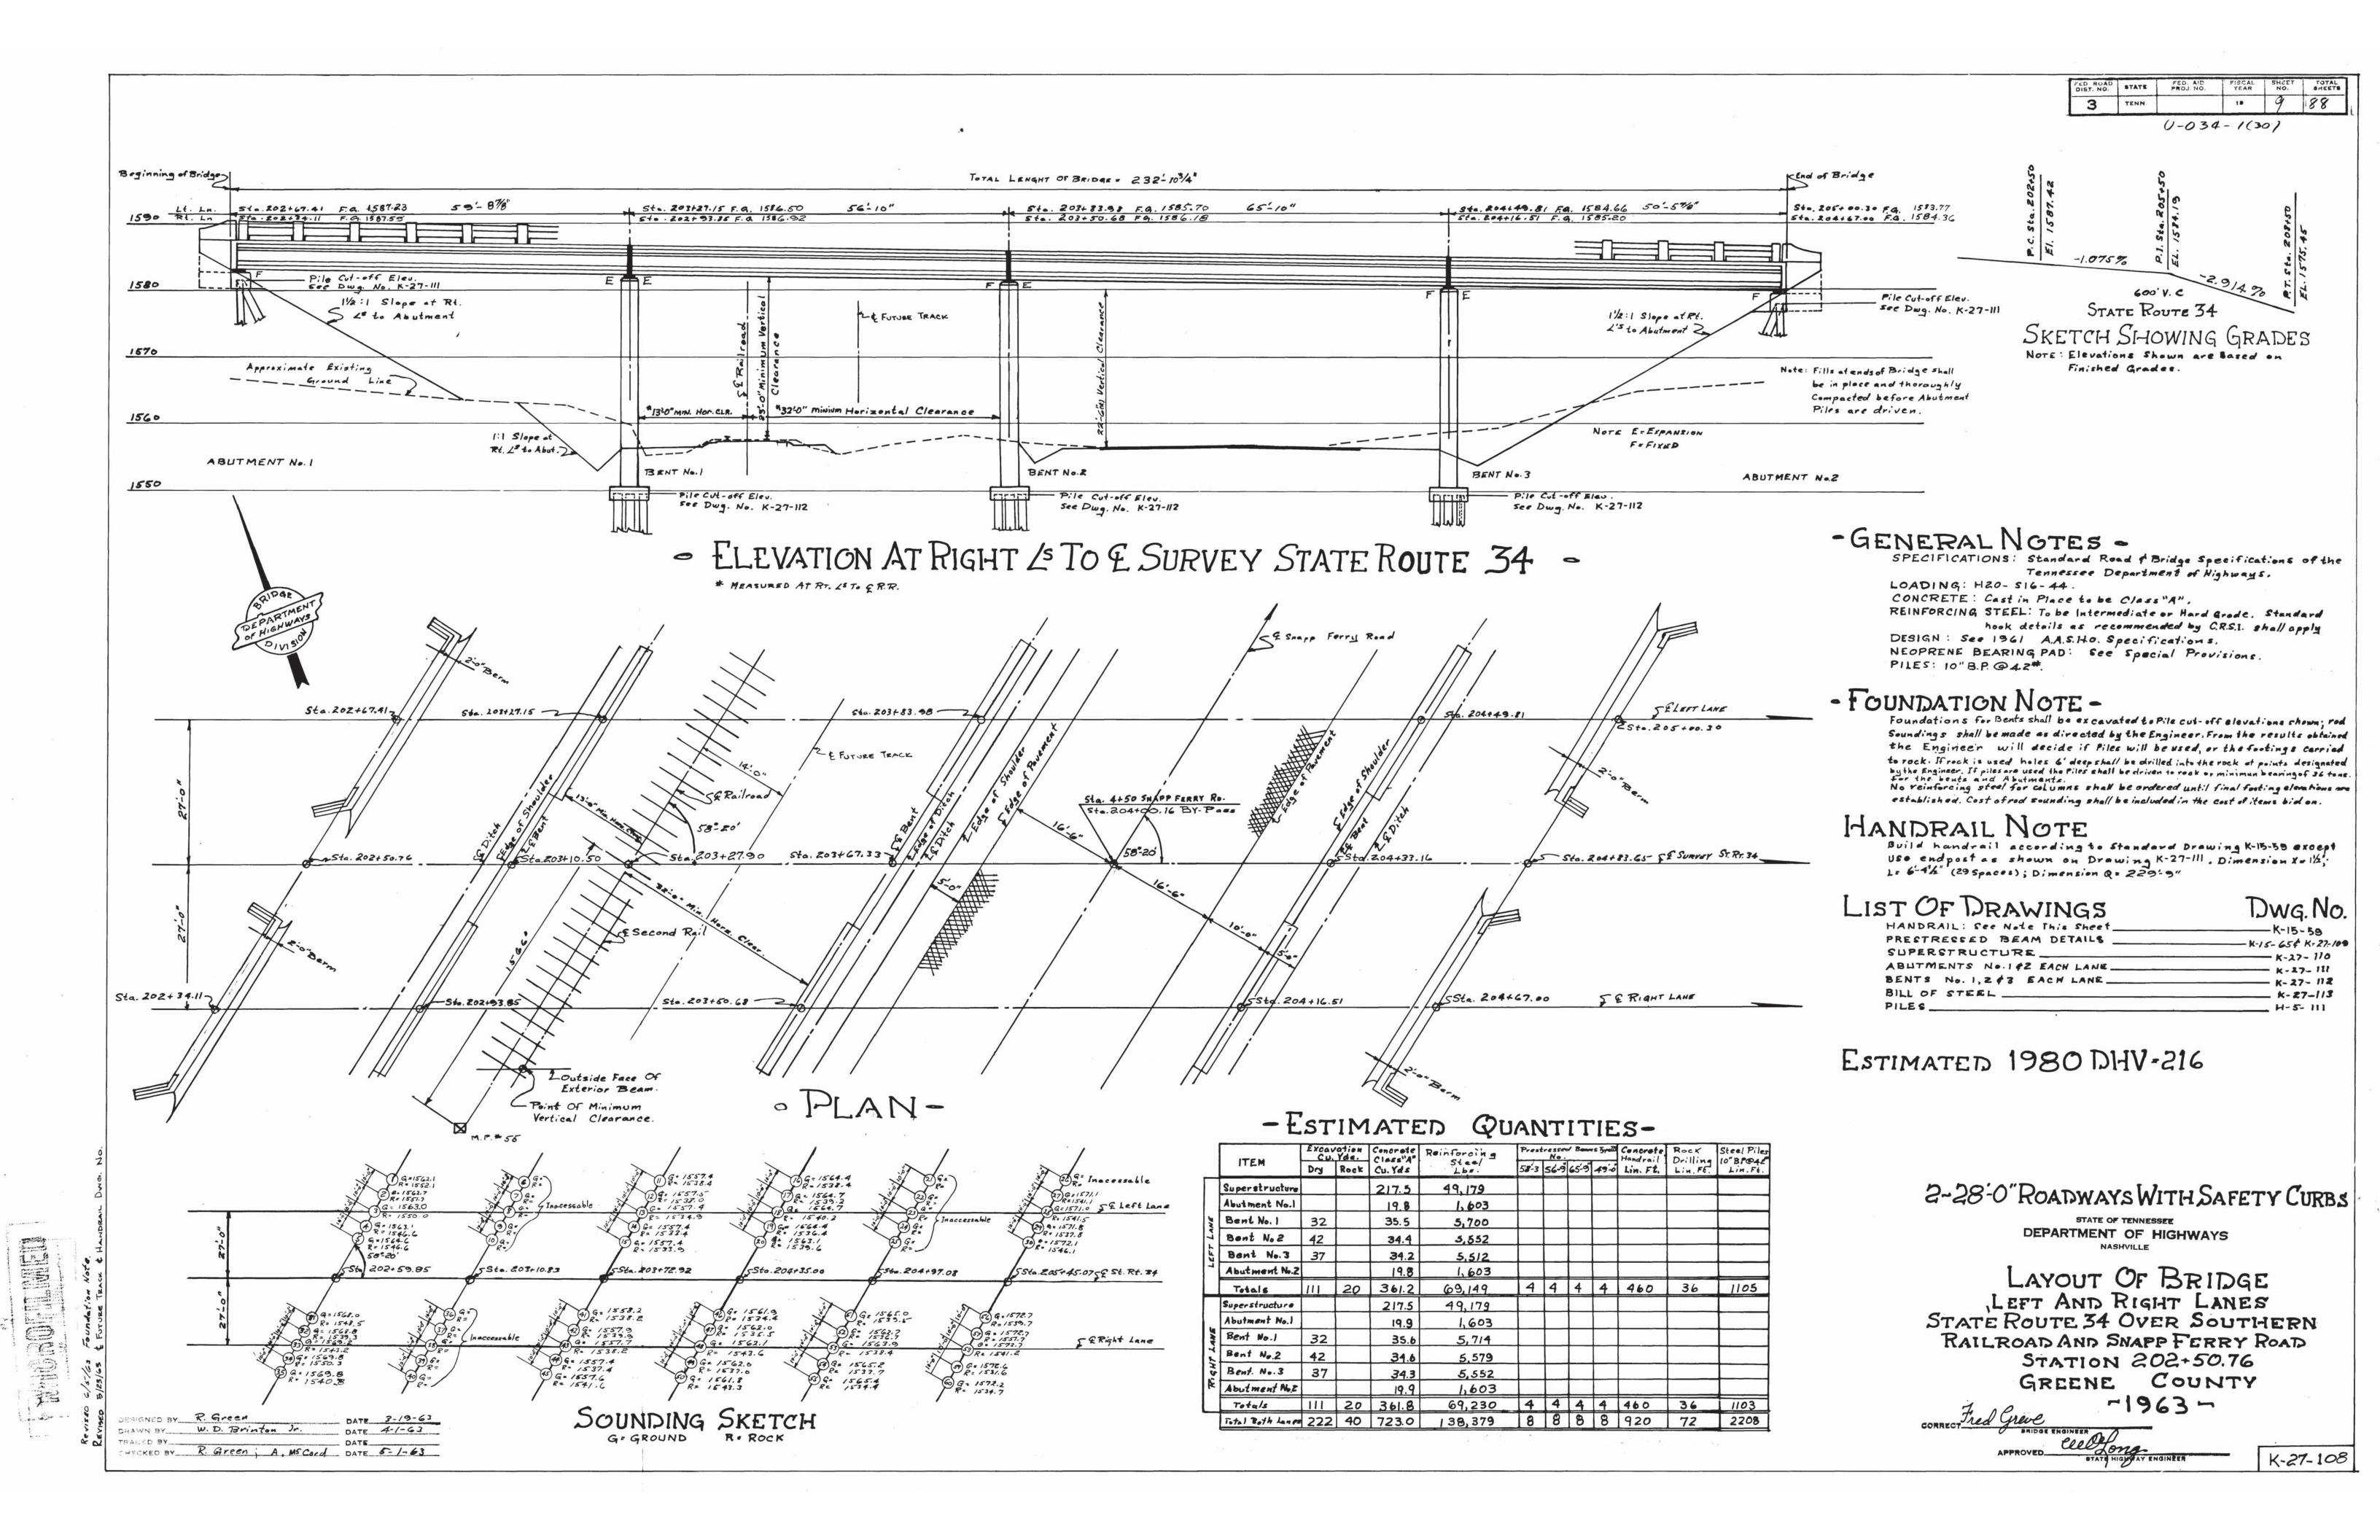


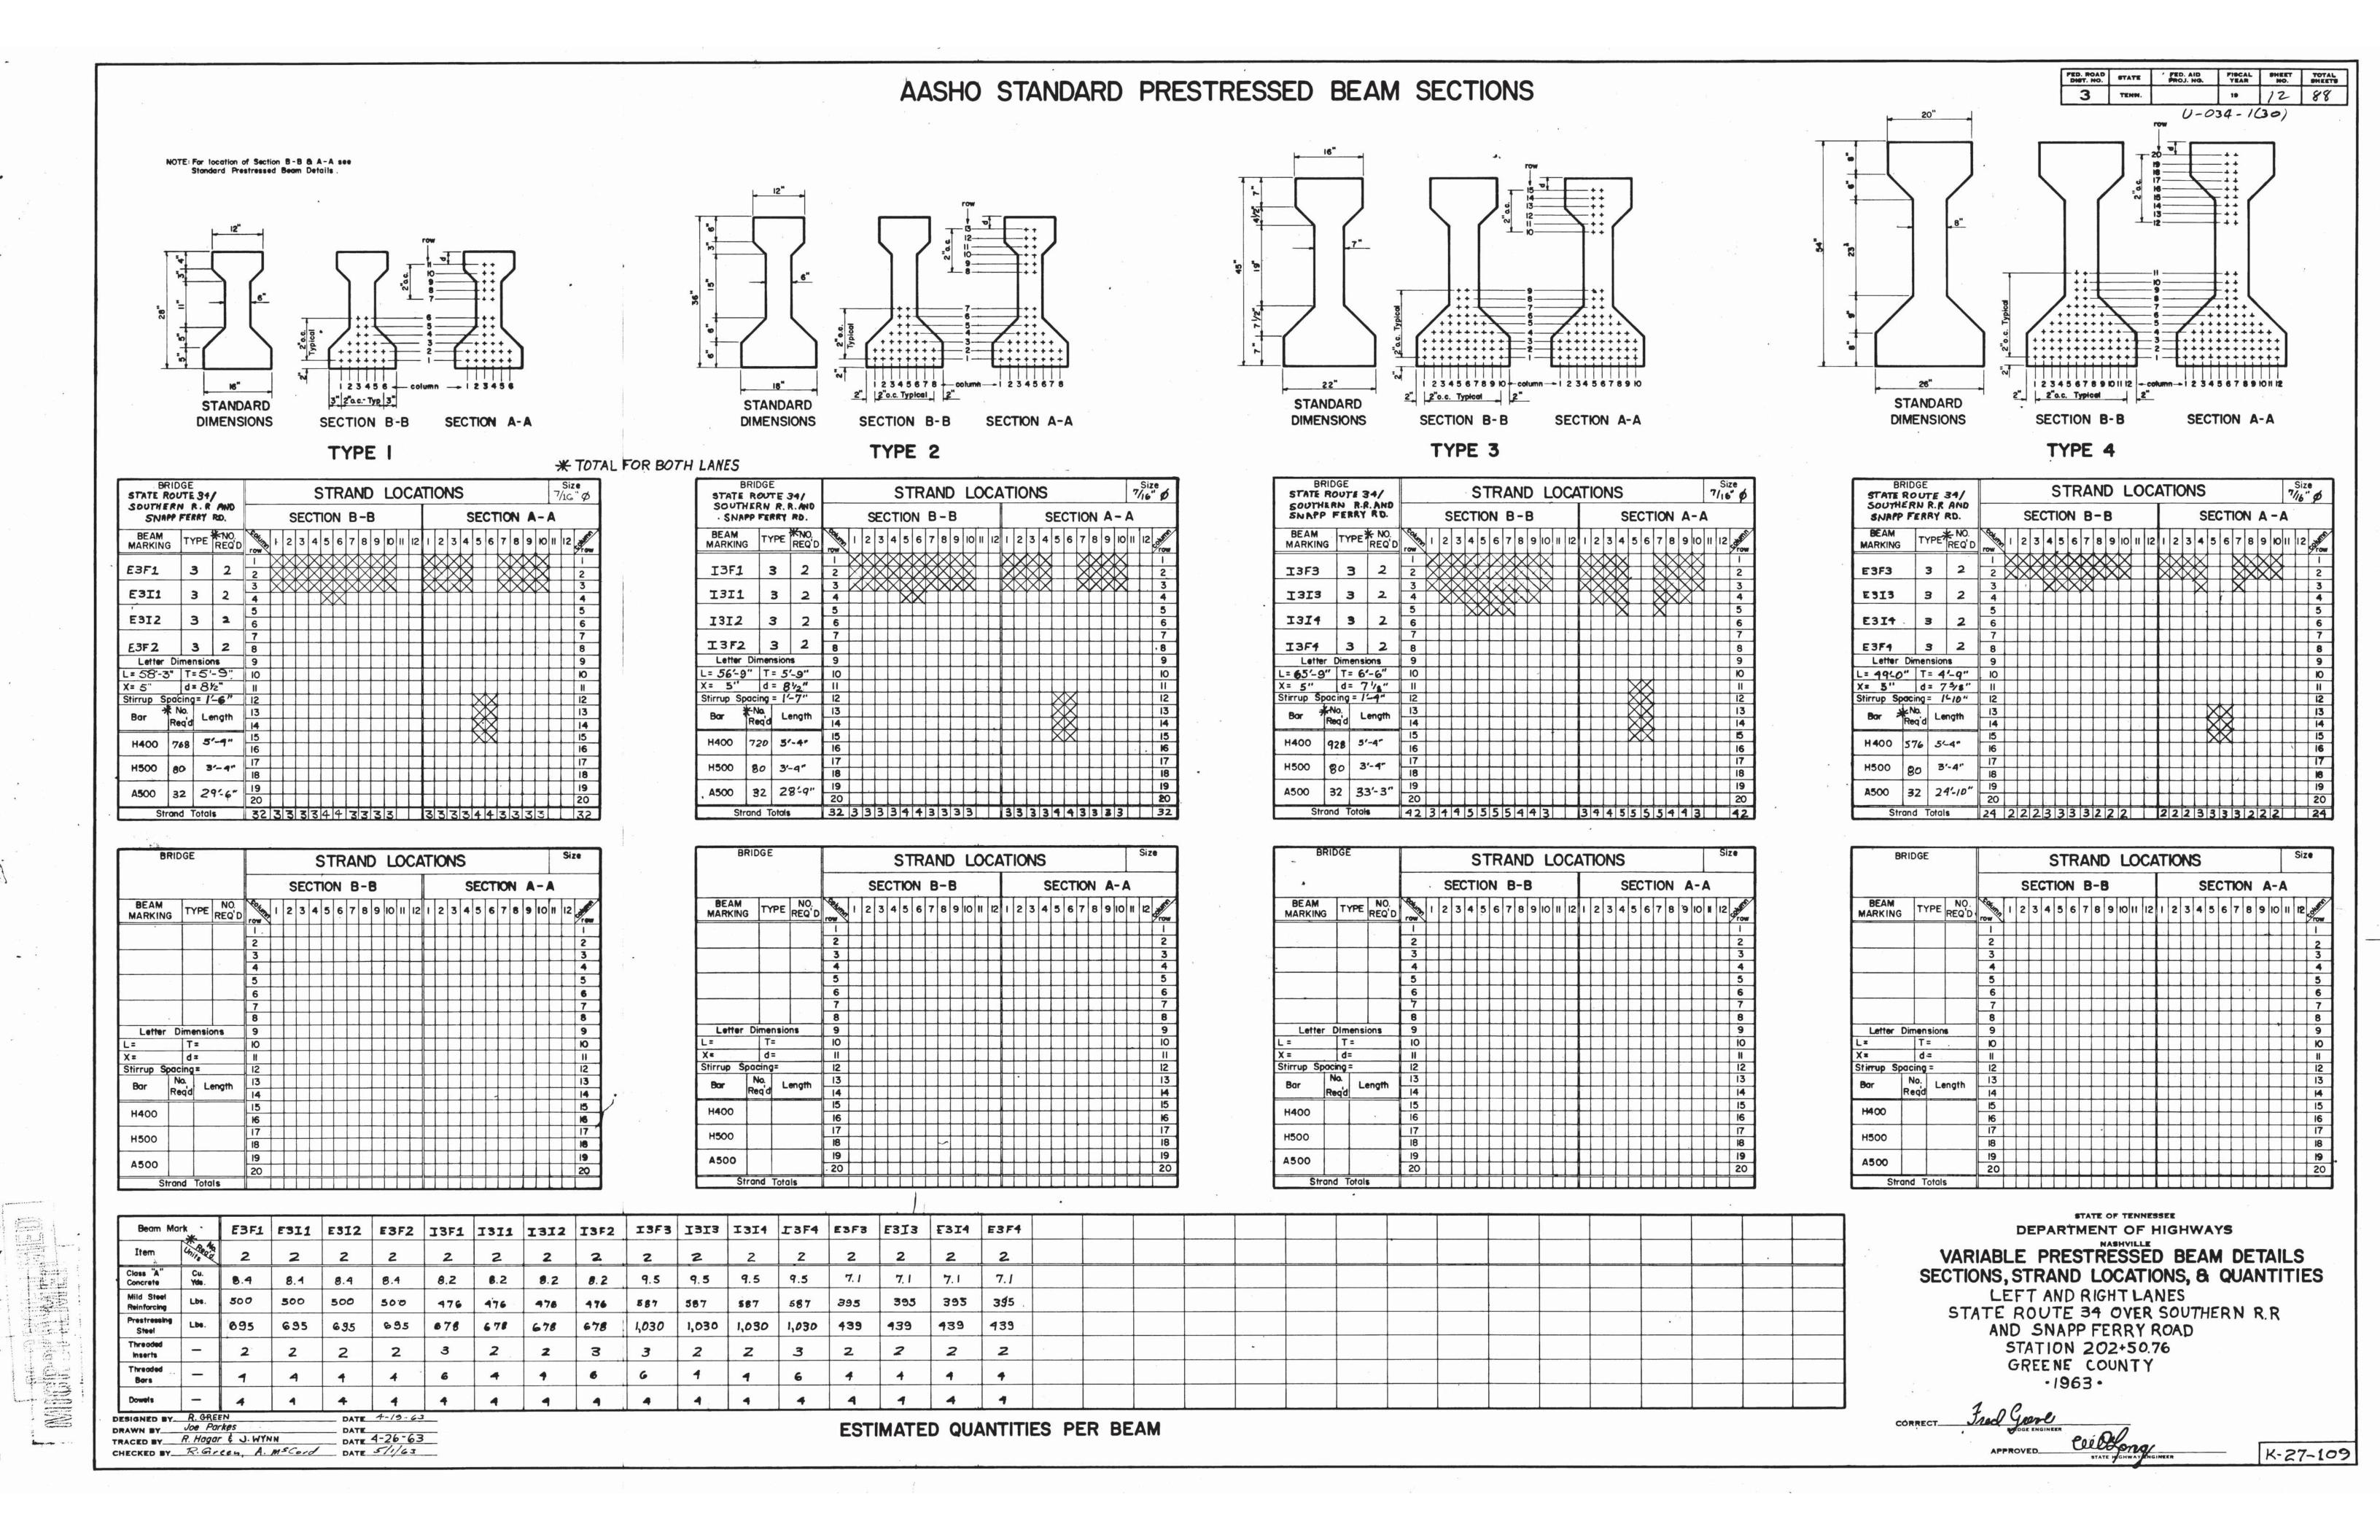

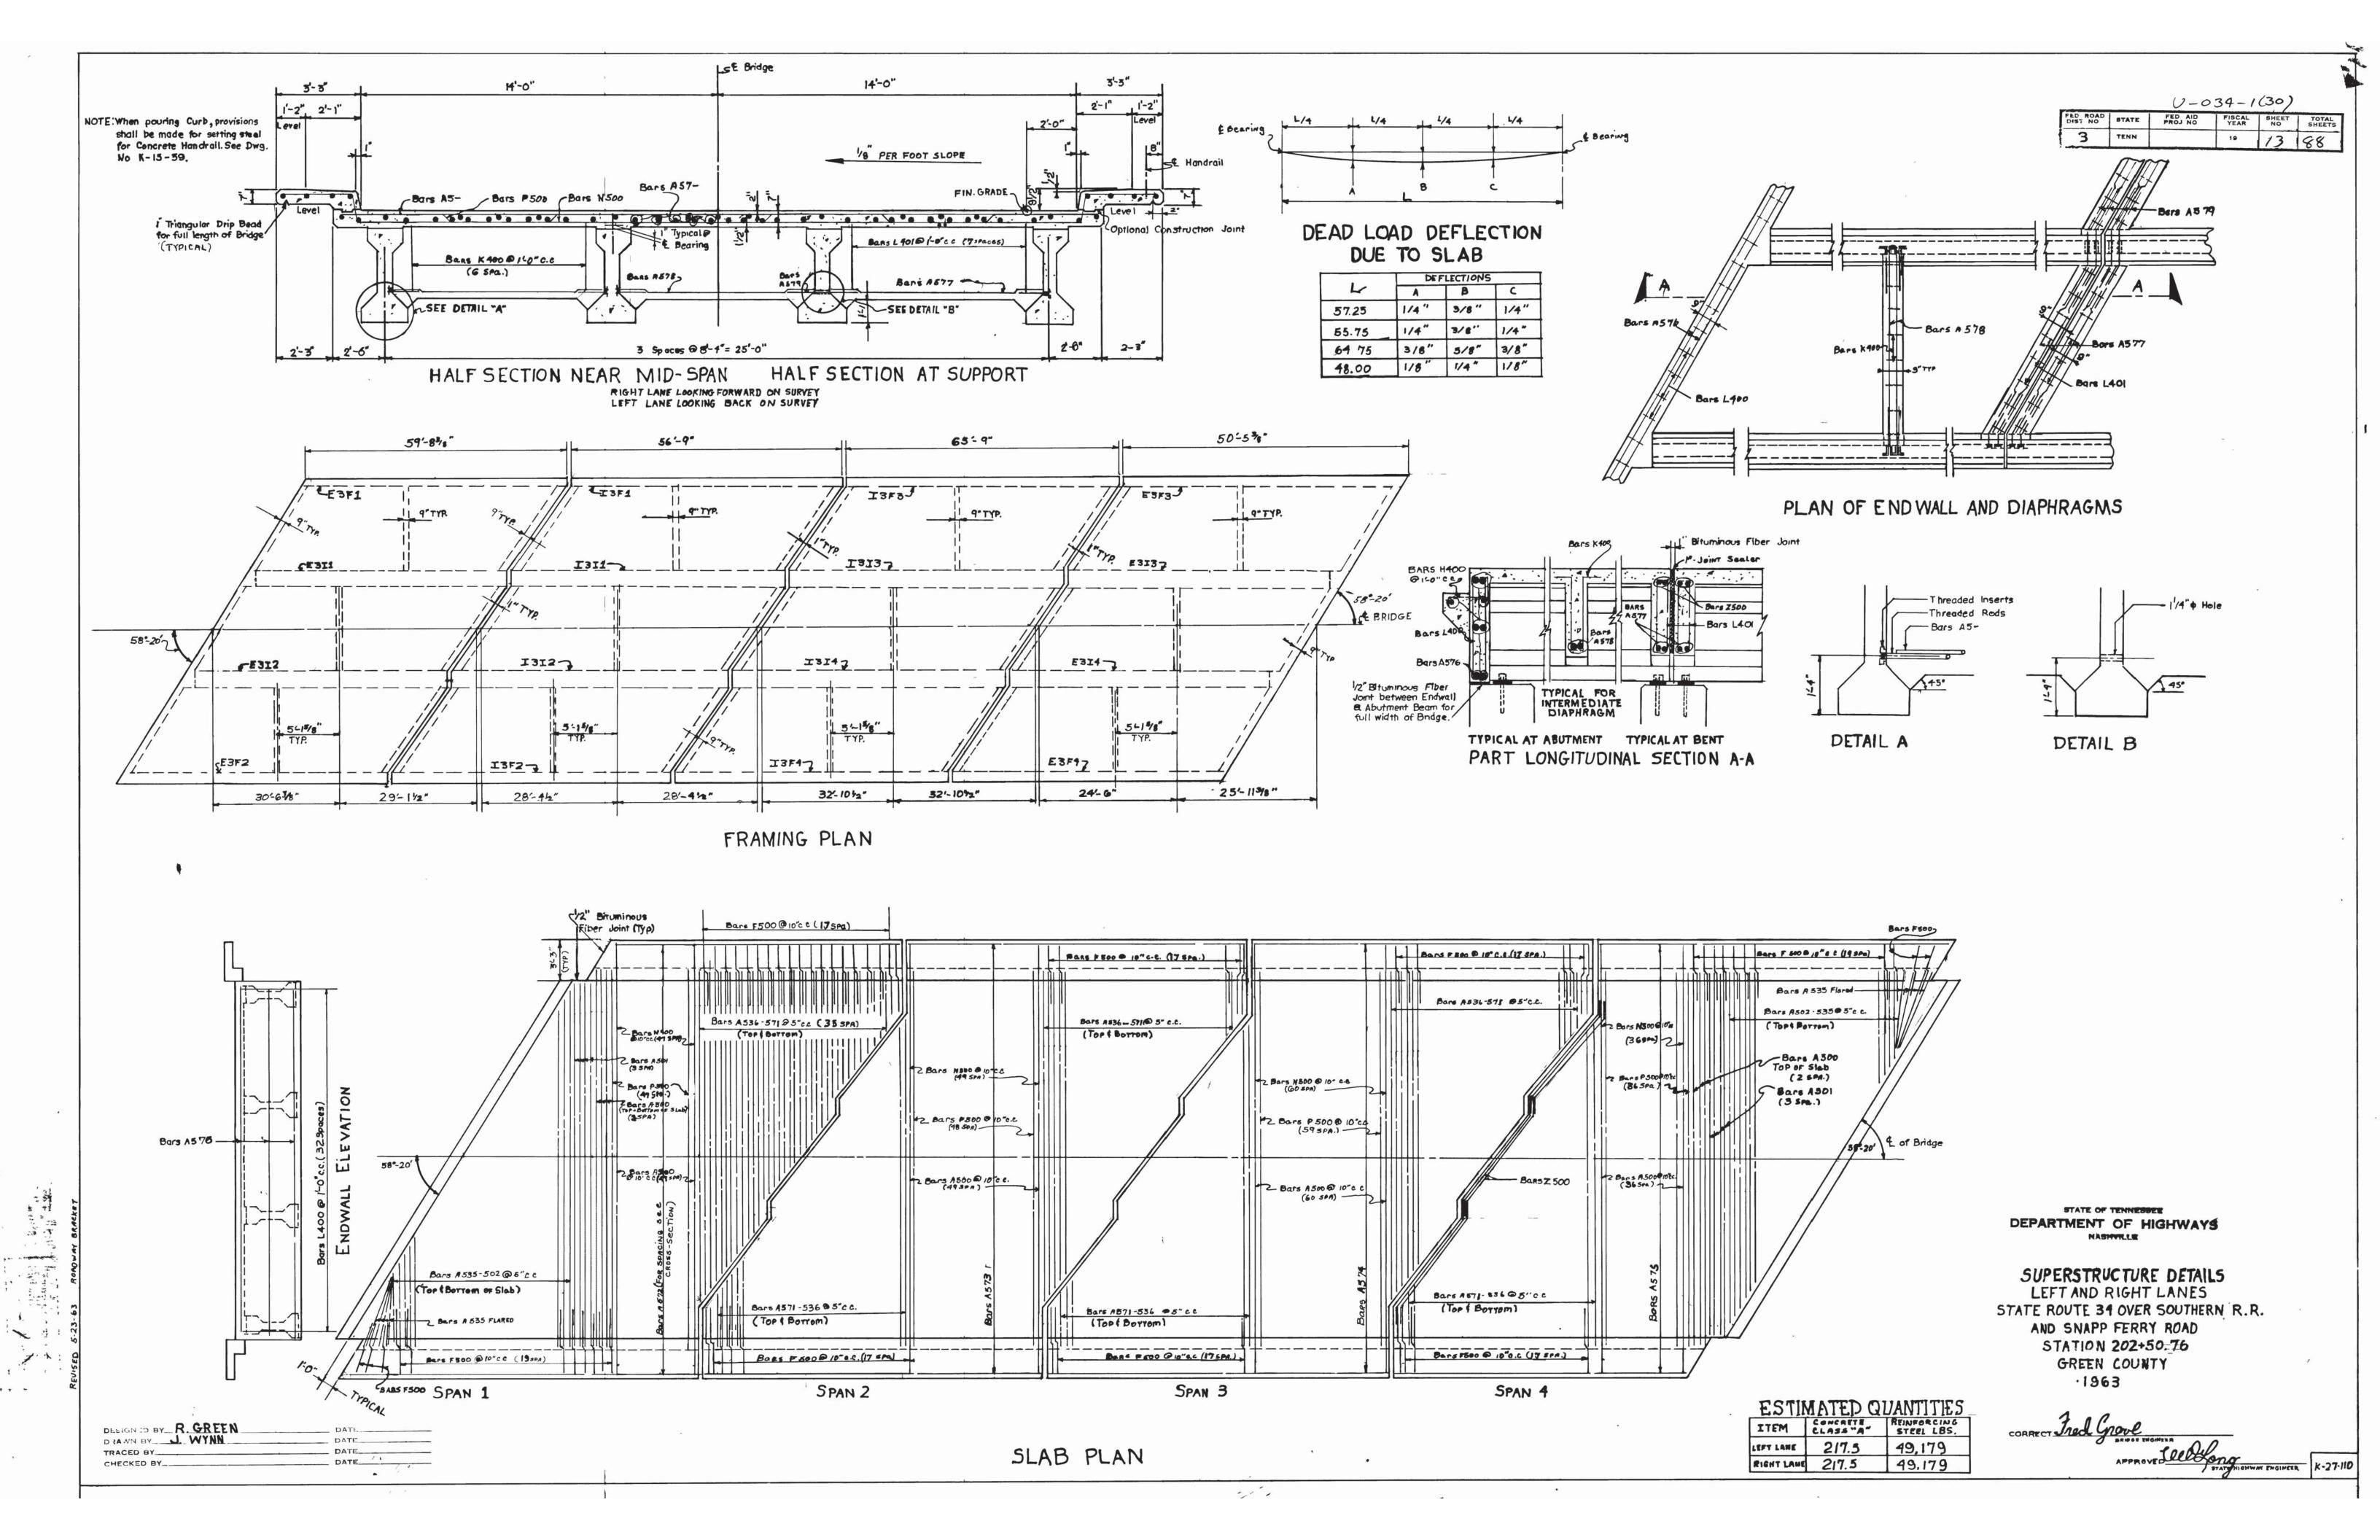

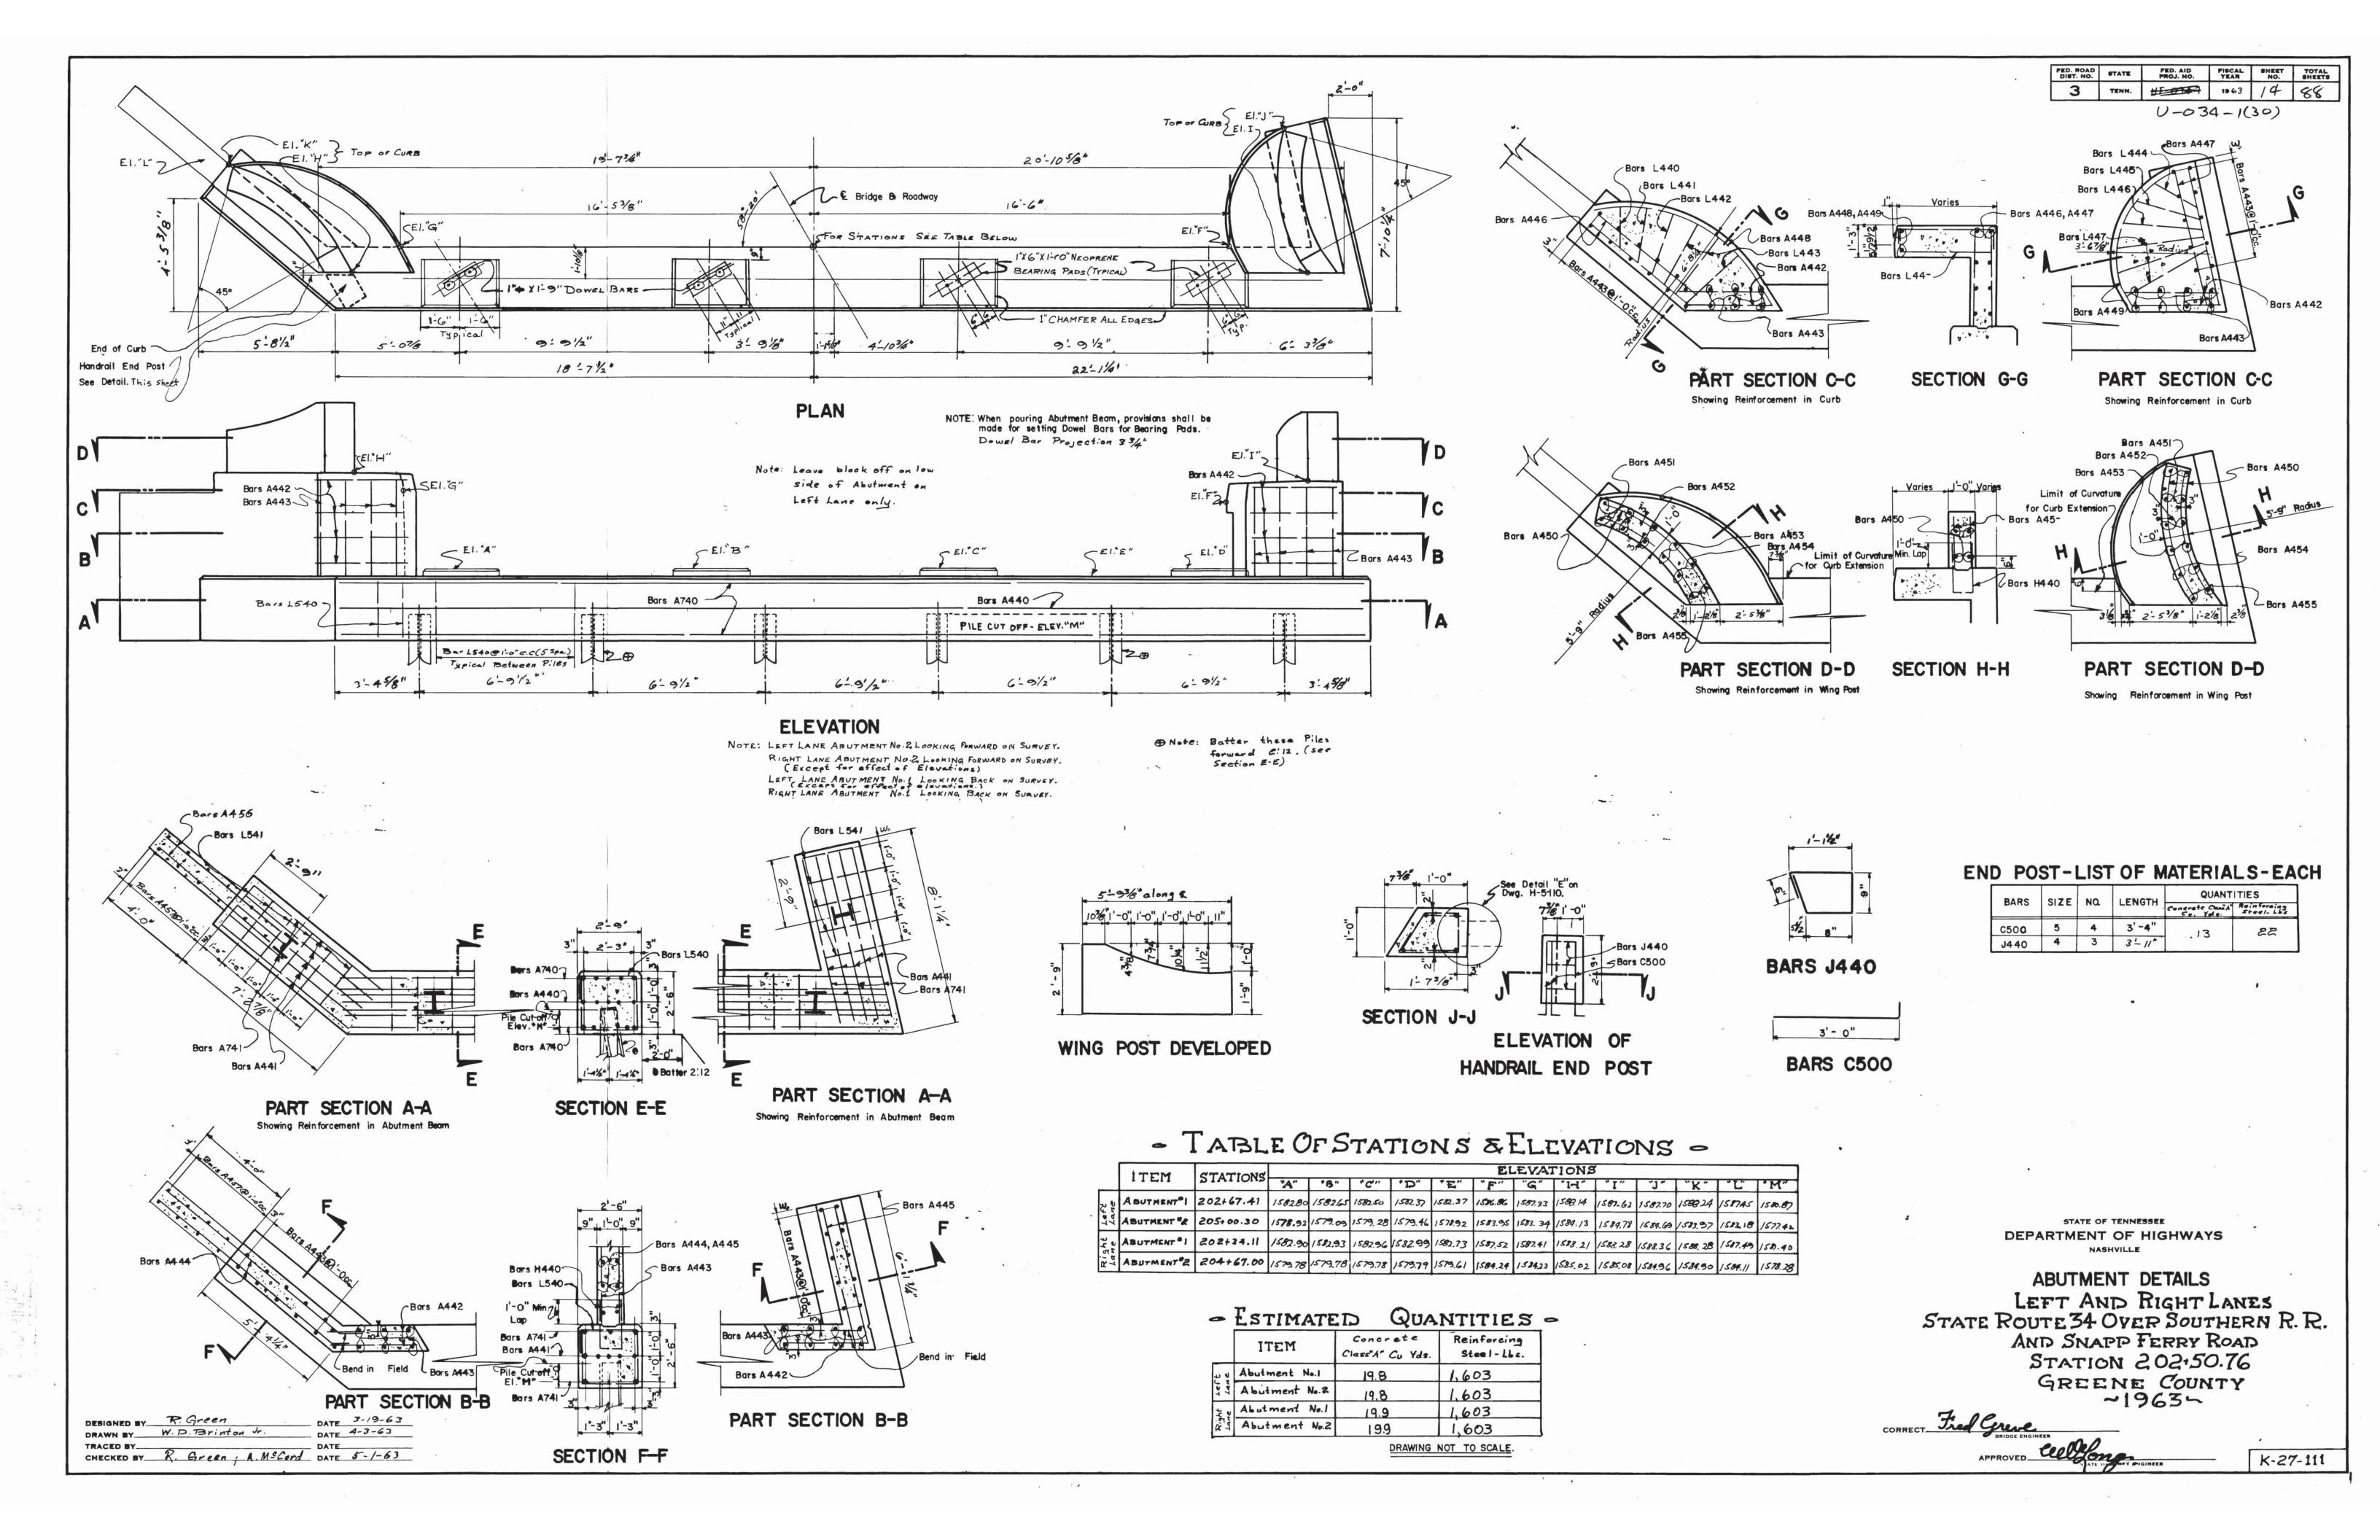

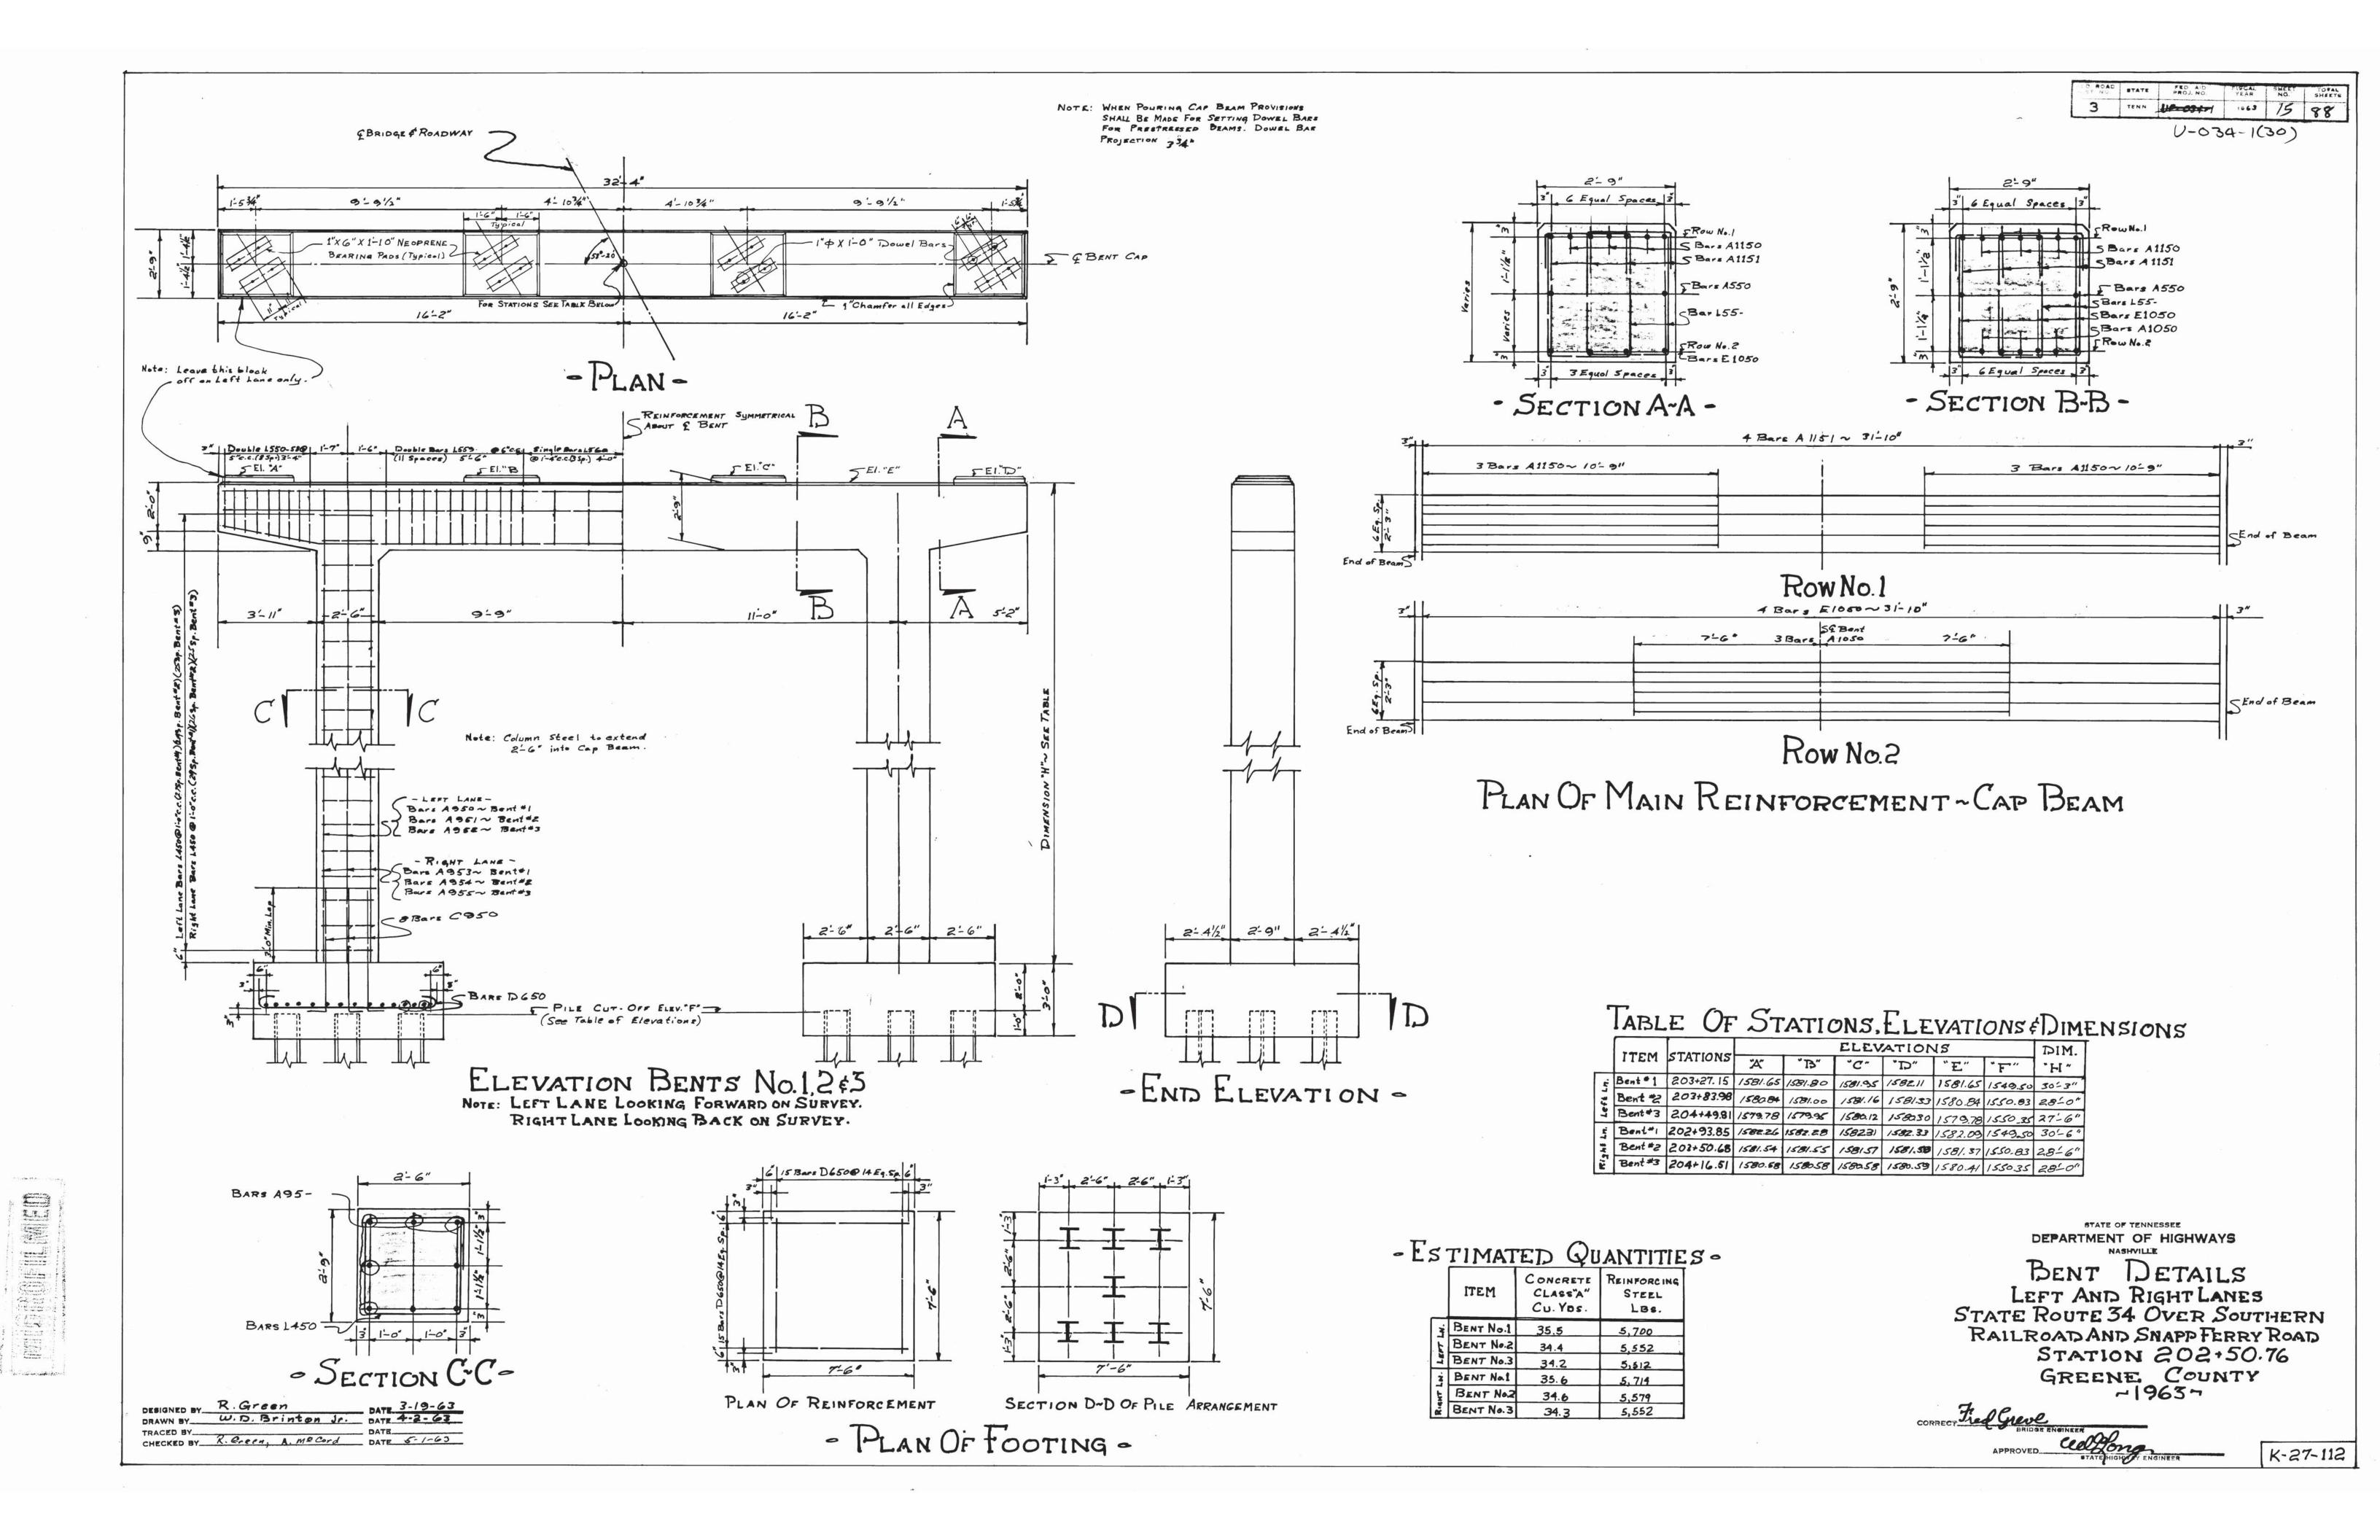

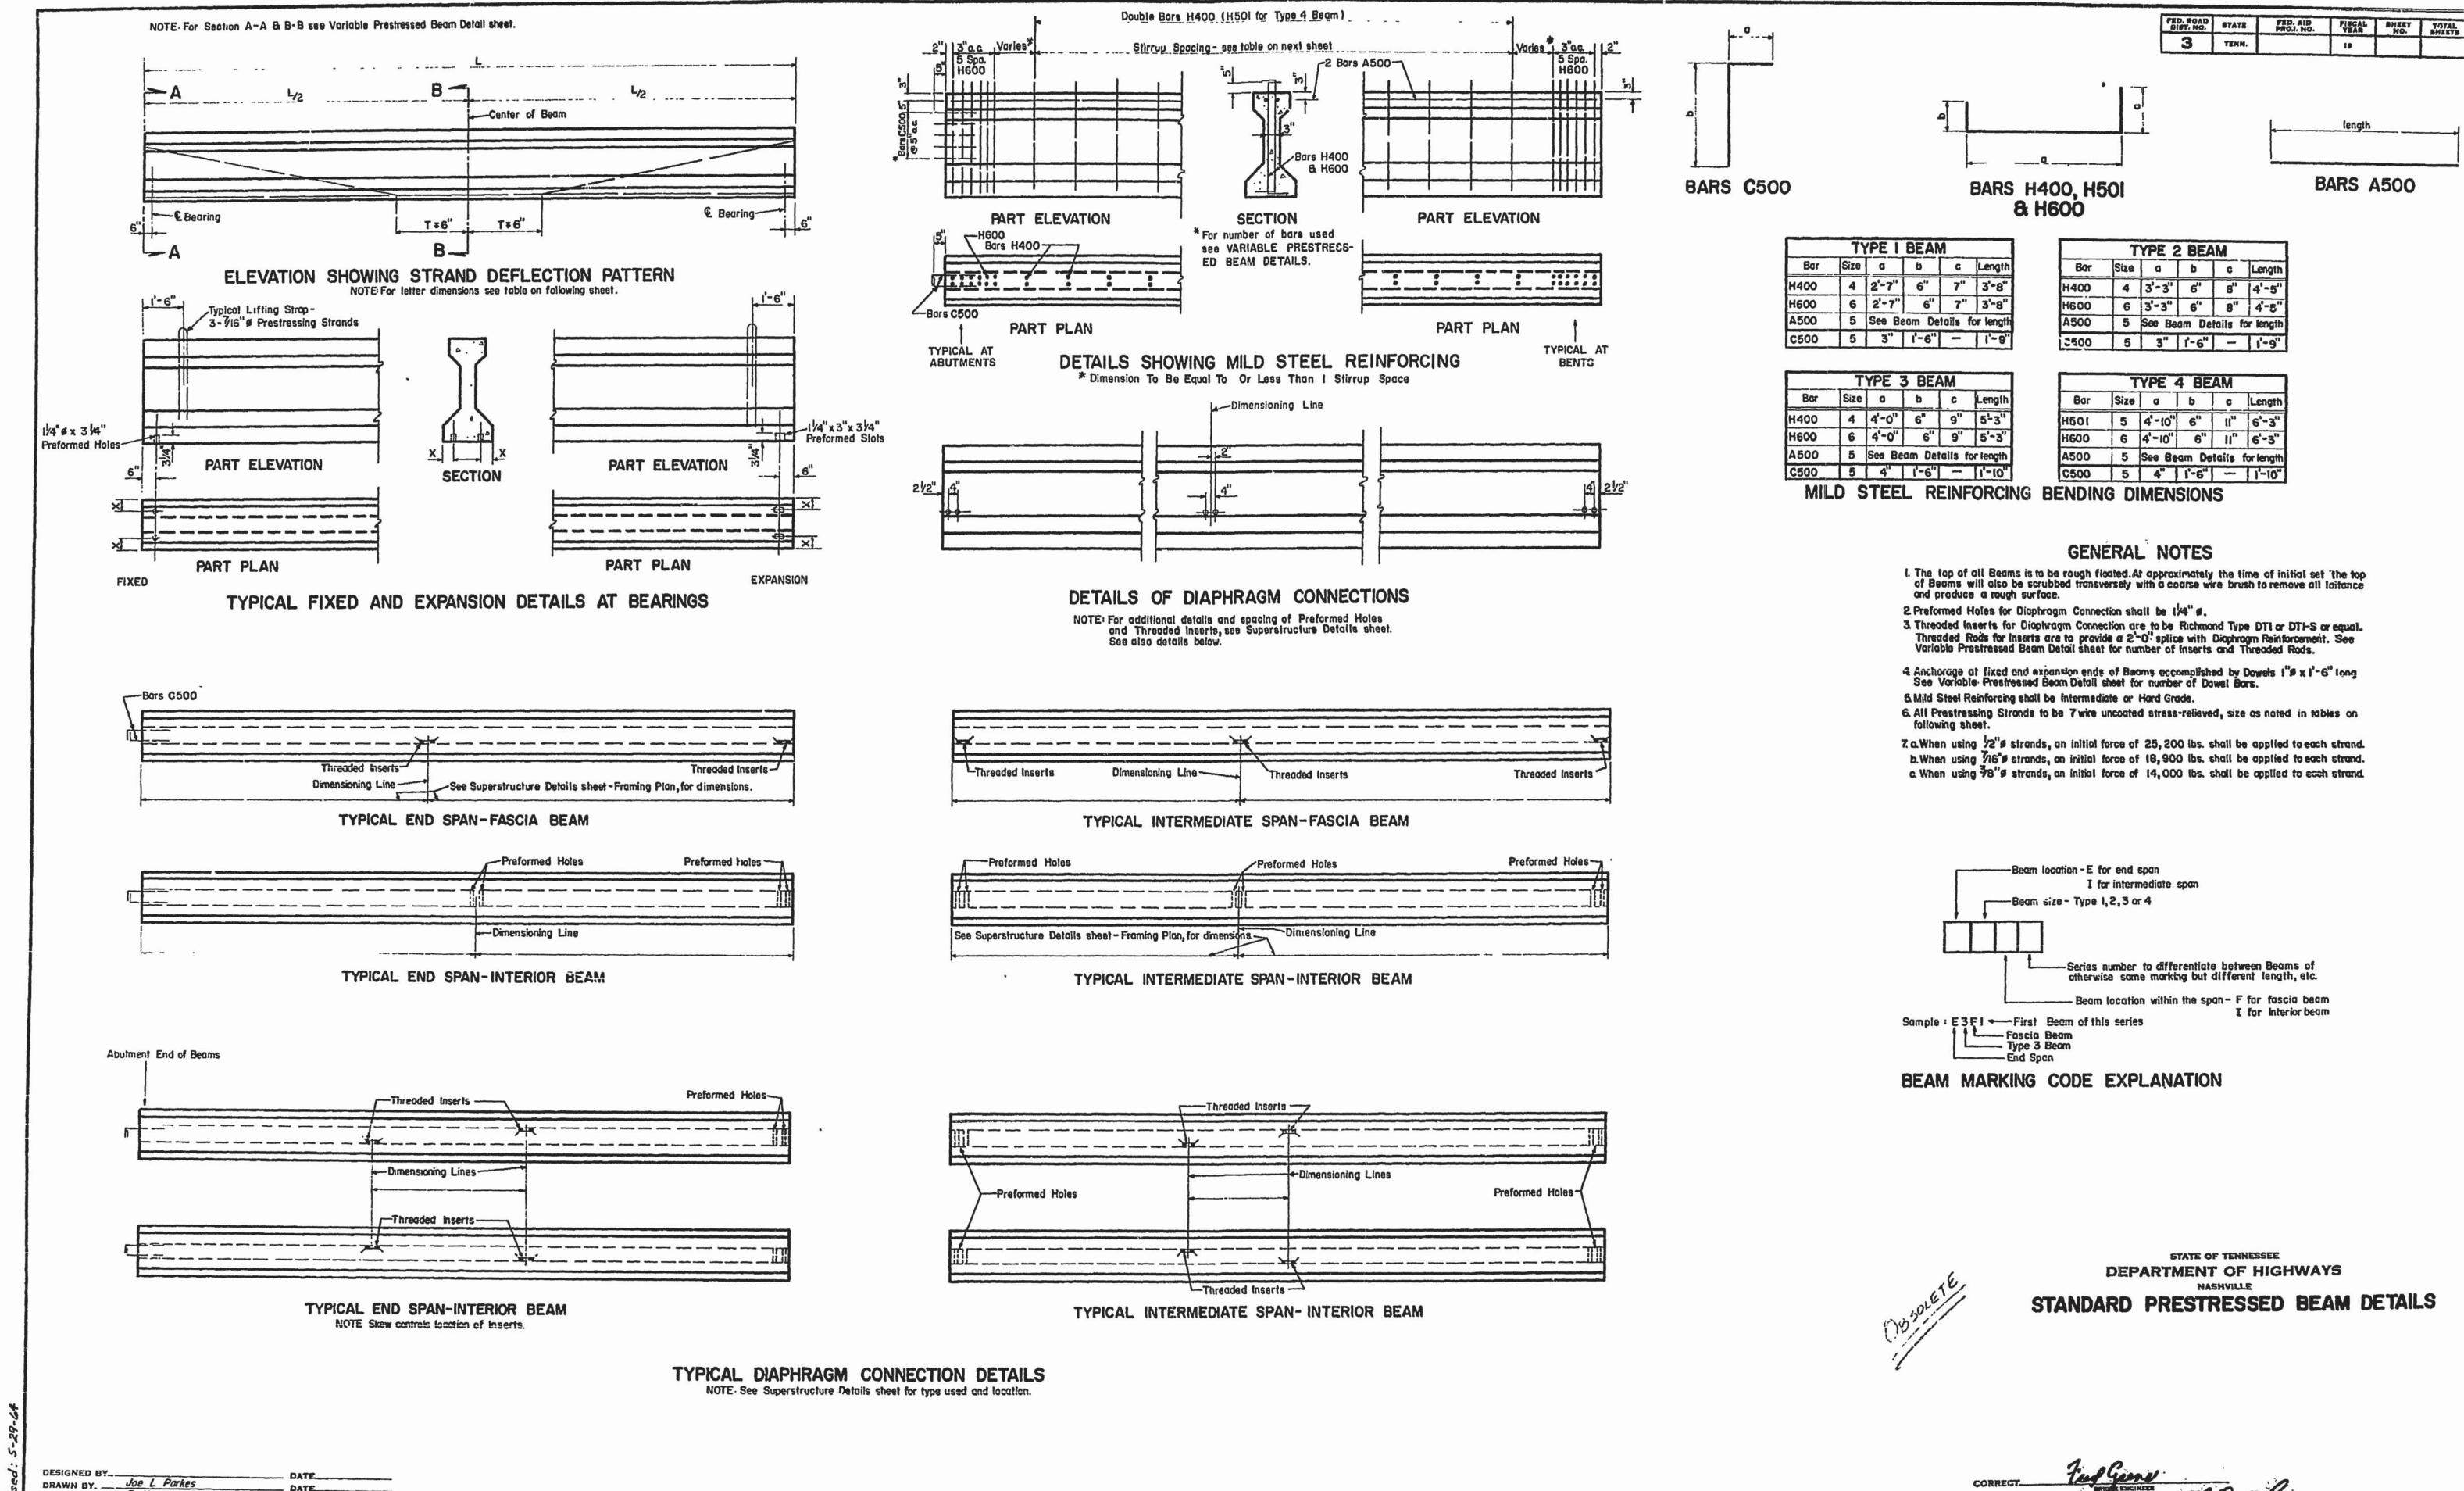

TRACED BY R Hagar

CHECKED BY_____